


CORRODED CONDUIT
DETAIL: PHOTO

SCALE: NOT TO SCALE

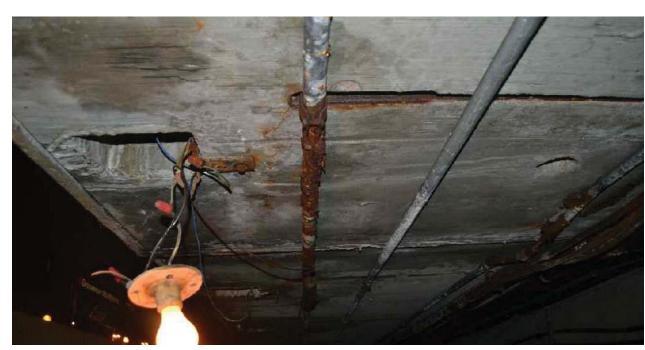



CORRODED CONDUIT
DETAIL: PHOTO
A(1E-100) SCALE: NOT TO SCALE



CORRODED CONDUIT
DETAIL: PHOTO

SCALE: NOT TO SCALE




CORRODED CONDUIT
DETAIL: PHOTO

SCALE: NOT TO SCALE


APPROVED -

PROFESSIONAL CERTIFICATION. I HEREBY CERTIFY THAT THESE DOCUMENTS WERE PREPARED OR APPROVED BY ME, AND THAT I AM A DULY LICENSED PROFESSIONAL ENGINEER UNDER THE LAWS OF THE STATE OF MARYLAND, LICENSE NO. 43224, EXPIRATION DATE 04-14-2015.

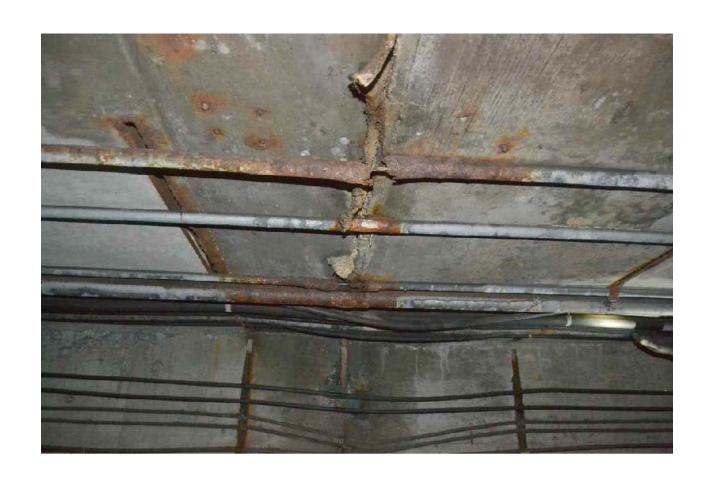

CORRODED CONDUIT
DETAIL: PHOTO

SCALE: NOT TO SCALE

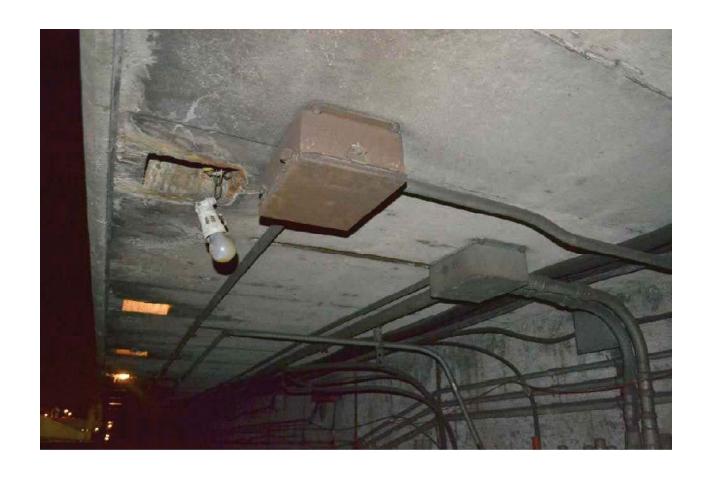

F CORRODED PULL BOX DETAIL: PHOTO

SCALE: NOT TO SCALE

## SHEET NOTES

1. COORDINATE REPLACEMENT OF CORRODED OR BROKEN CONDUITS AND JUNCTION BOXES WITH WMATA AR.

FINAL

RED LINE REHAB.-FRIENDSHIP HEIGHTS TO GROSVENOR - PART 4

FQ15093



# WASHINGTON METROPOLITAN AREA TRANSIT AUTHORITY

SUBMITTED

DEPARTMENT OF TRANSIT INFRASTRUCTURE AND ENGINEERING SERVICES OFFICE OF INFRASTRUCTURE RENEWAL PROGRAM




Brad Mason, P.E.


PROJECT MANAGER

GROSVENOR STATION — PLATFORM REMOVAL ELECTRICAL REPRESENTATIVE PICTURES

SCALE 1/8"=1'-0" 2 1 0 2 4 6 8 10 A11-E-703

WING NO. SHEET NO. M1272-179

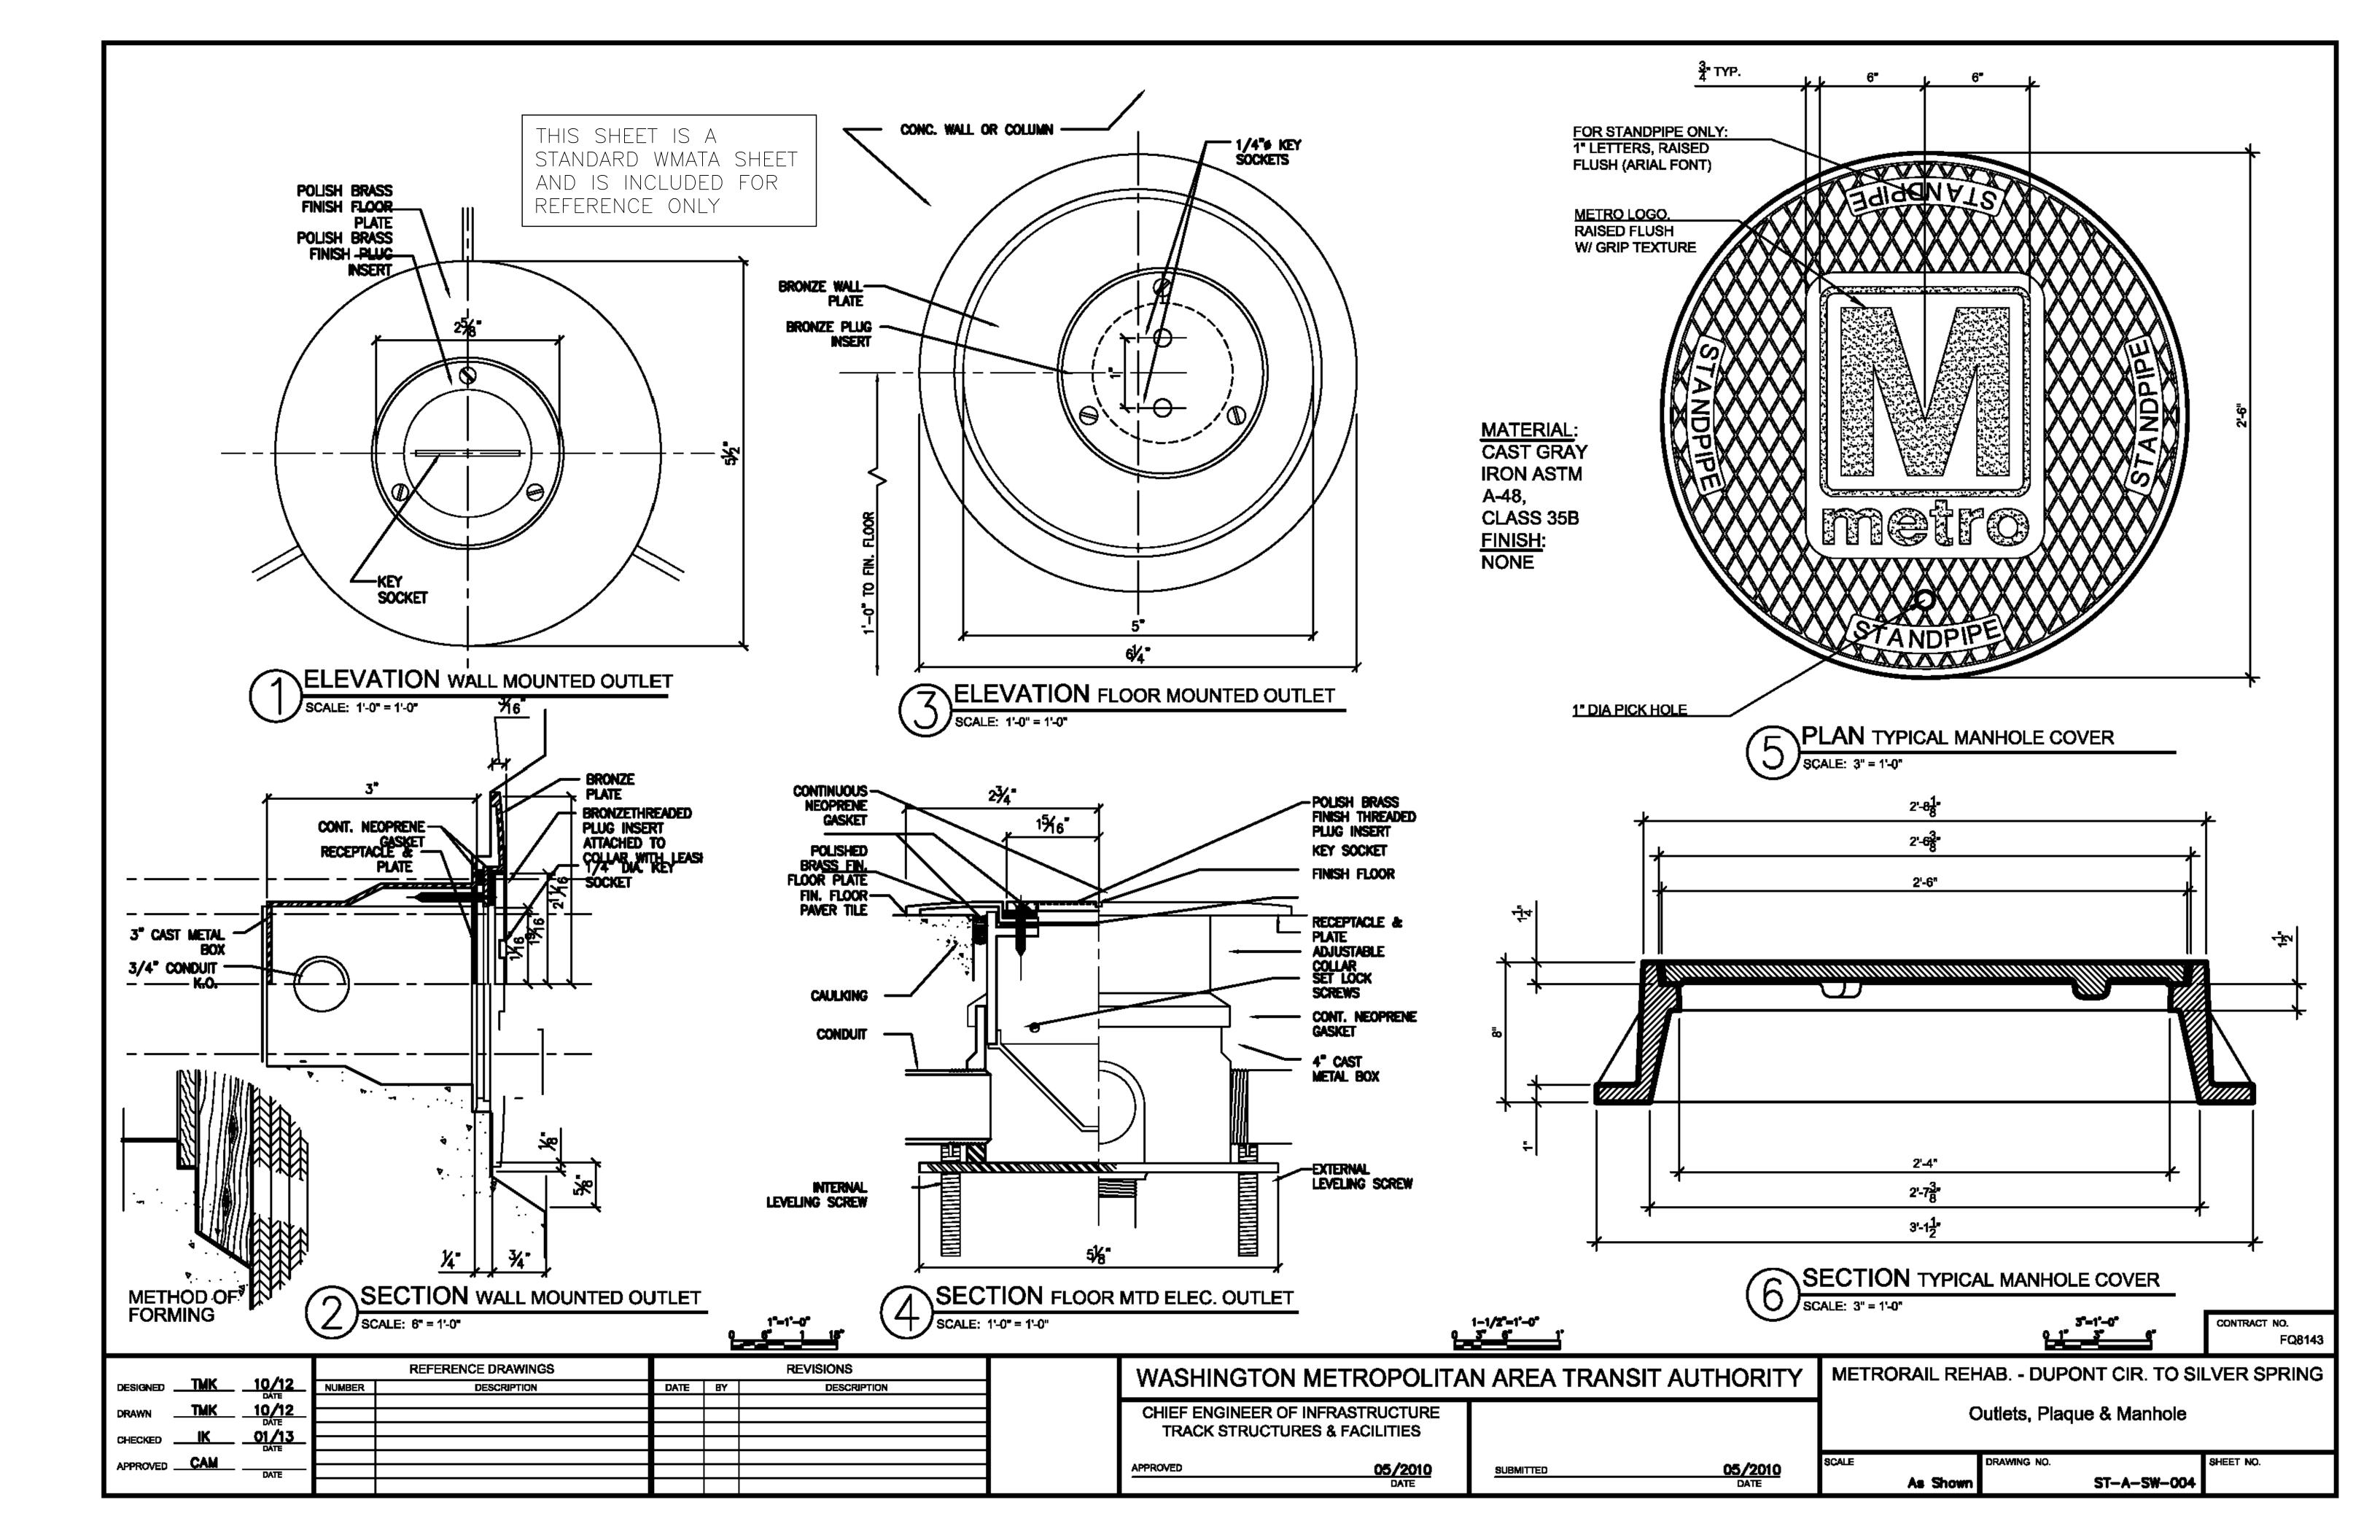

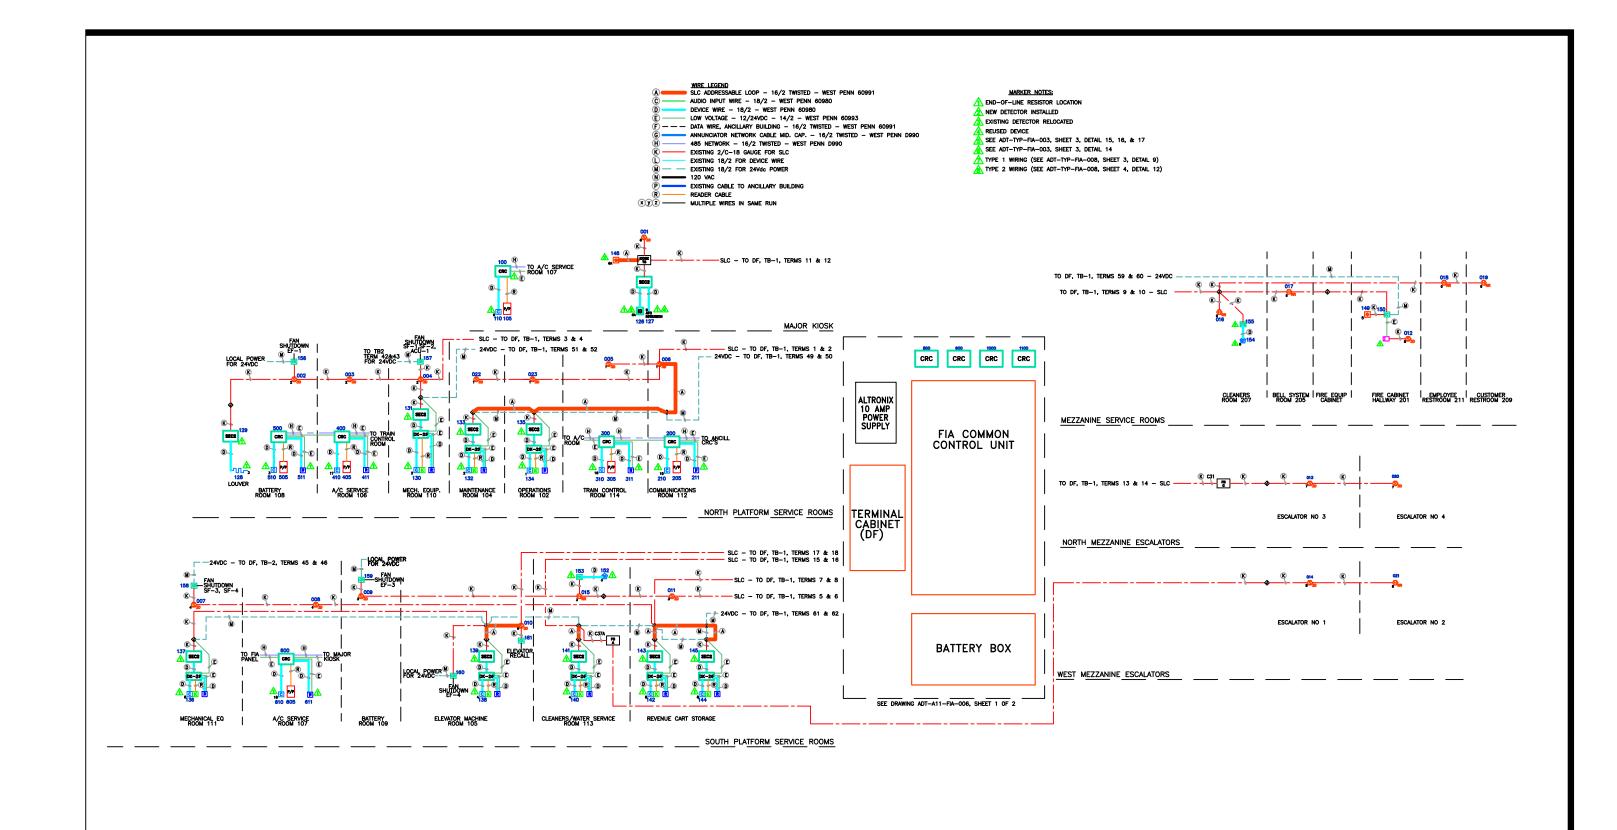


Designed: JBG | 10/22/00 REFERENCE DRAWINGS Drawn: GN 10/24/0 Checked: JBG 10/26/0 Approved: MCM 10/28/0








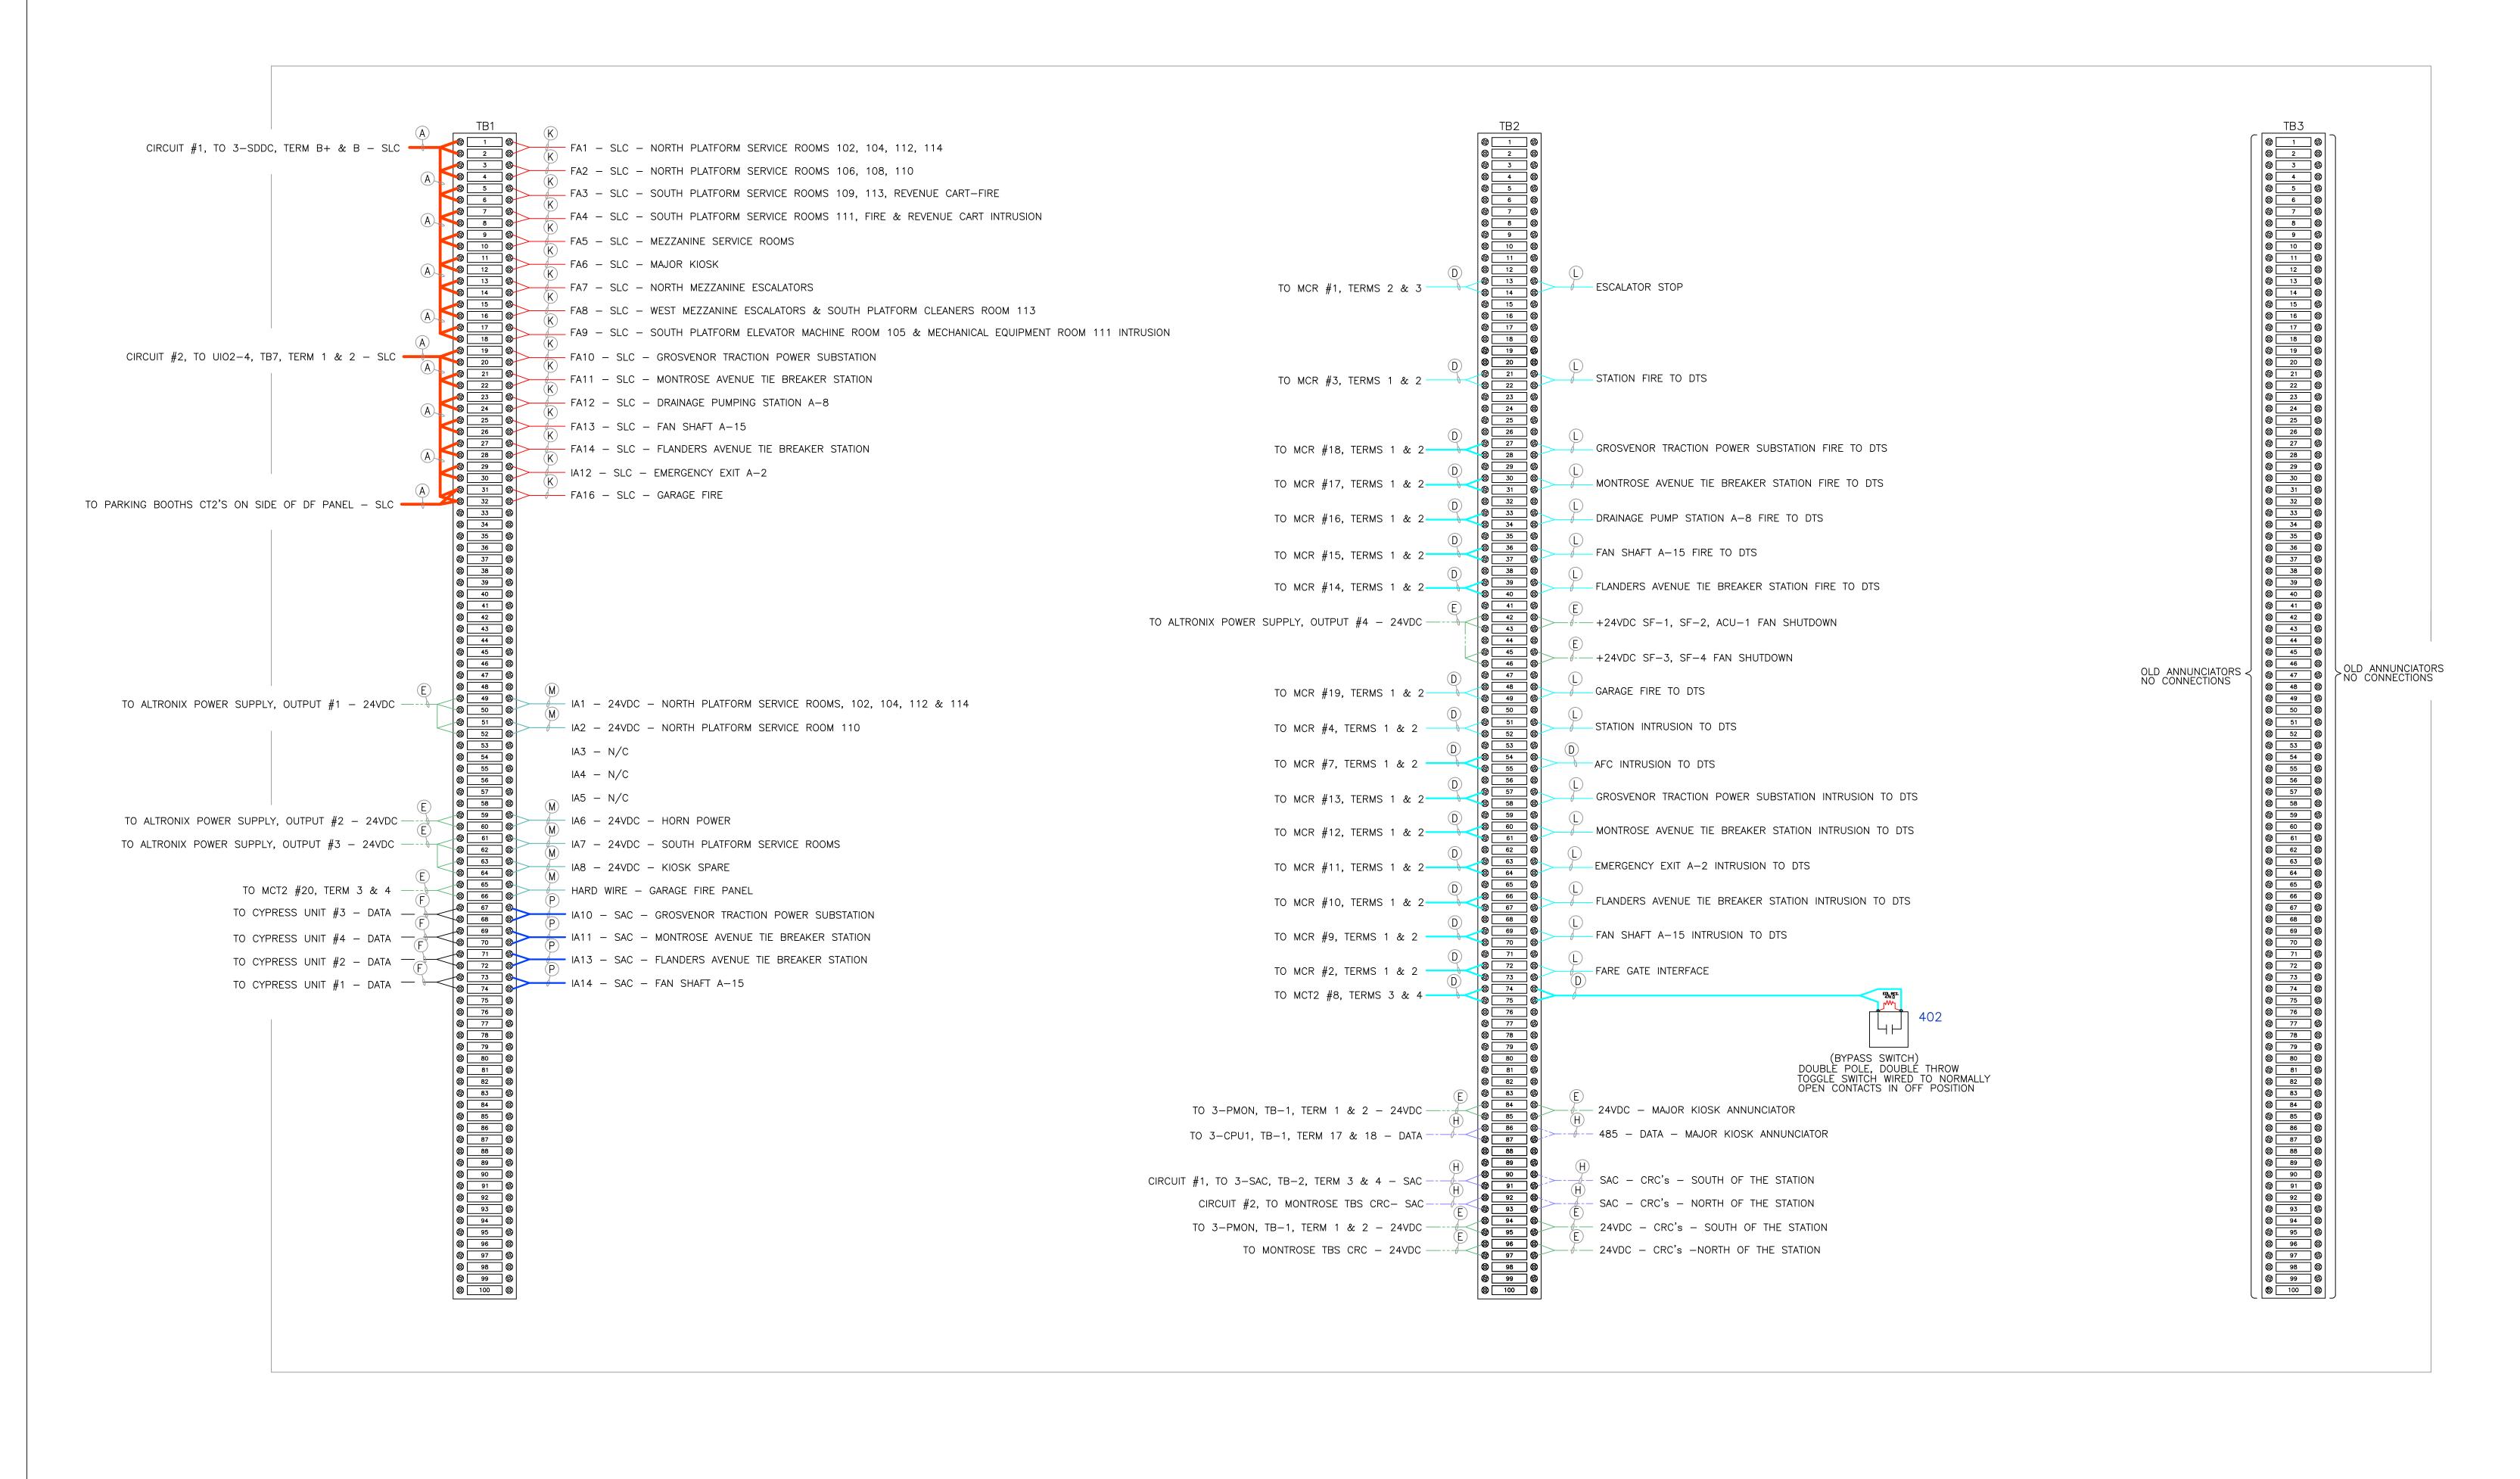

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A 02/28/07 CHANGES MADE PER WMATA REVIEW GN 10/24/06 Checked: JBG | 10/26/06 Approved: MCM 10/28/06



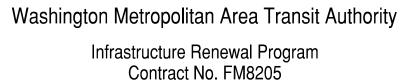




ADT Security Services,	lη
ADT Security Services, Systems Sales & Engine	фrì
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(215) - 654 - 7450 ext	5
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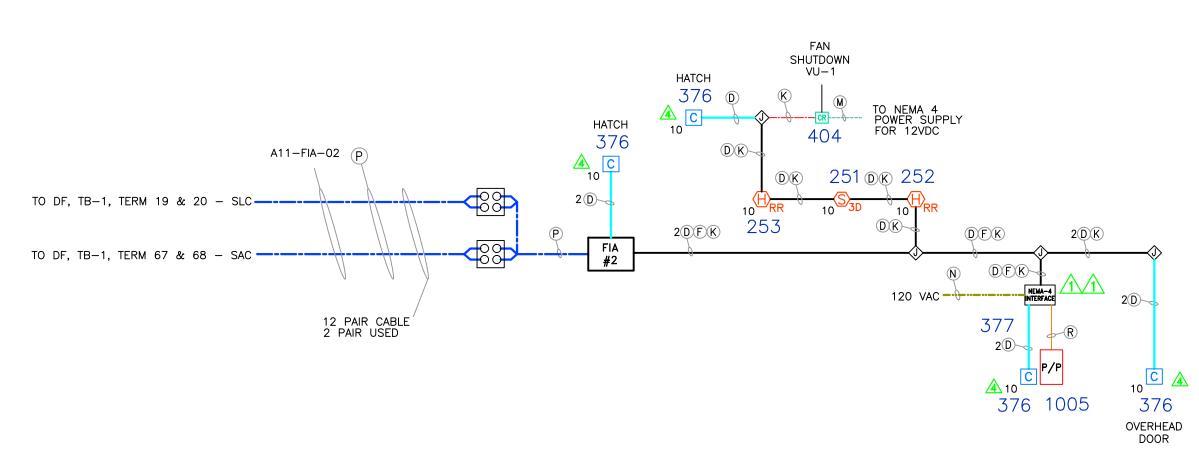
	Directory:	WMATA\GROSVENO	OR STR	RATHMO	RE	Created: <b>10/22/06</b>
Security Services, I s Sales & Engine	n <del>c</del> ilename: ring	DF Terminal Panel		Format:		Scale: NTS
		ENOR STRATHMORE	Station	No.:	11	Sheet: 2 of 2
	DWG No:	ADT-A11-FIA-006		Rev:		<b>AS-BUILT</b>

GROSVENOR STRATHMORE **DF Terminal Panel Connections** 

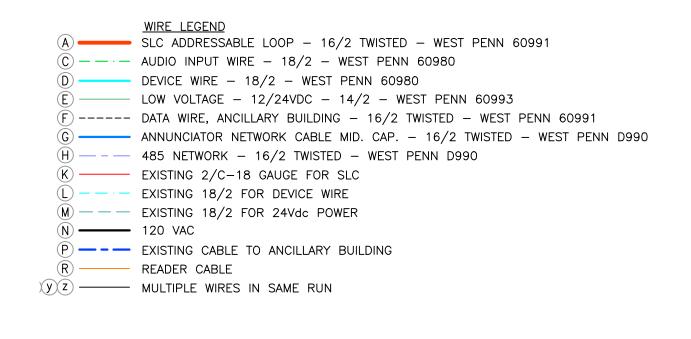


### MARKER NOTES:


- 1 END-OF-LINE RESISTOR LOCATION
- NEW DETECTOR INSTALLED
- \$\ EXISTING DETECTOR RELOCATED
- REUSED DEVICE
- $\frac{1}{5}$  SEE ADT-TYP-FIA-003, SHEET 3, DETAIL 15, 16, & 17
- SEE ADT-TYP-FIA-003, SHEET 3, DETAIL 14
- TYPE 1 WIRING (SEE ADT-TYP-FIA-008, SHEET 3, DETAIL 9)
- TYPE 2 WIRING (SEE ADT-TYP-FIA-008, SHEET 4, DETAIL 12)





GROSVENOR TRACTION POWER SUBSTATION (571+75)

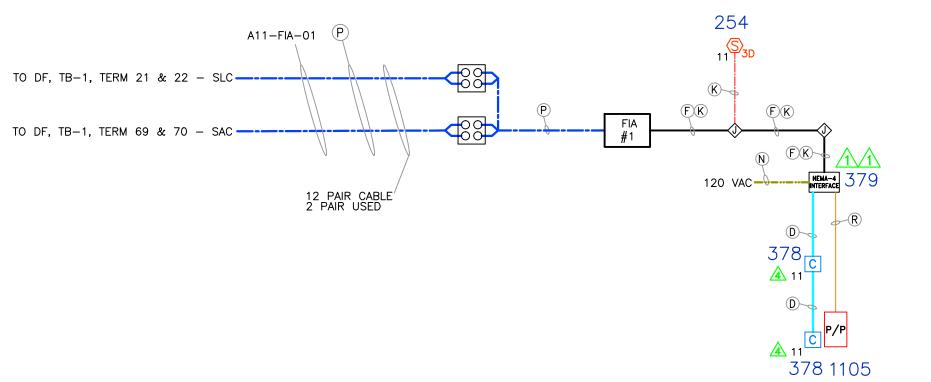


MONTROSE AVENUE TIE BREAKER STATION (546+10)

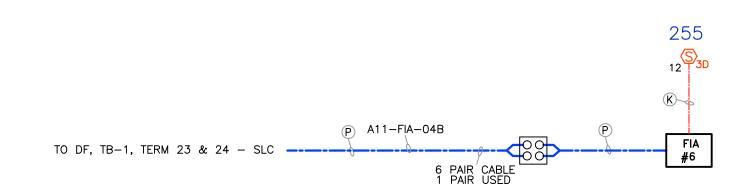

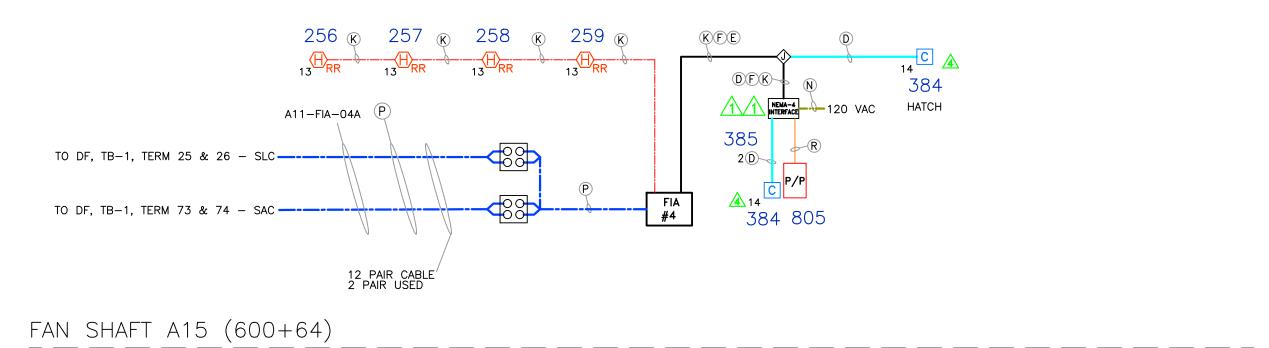


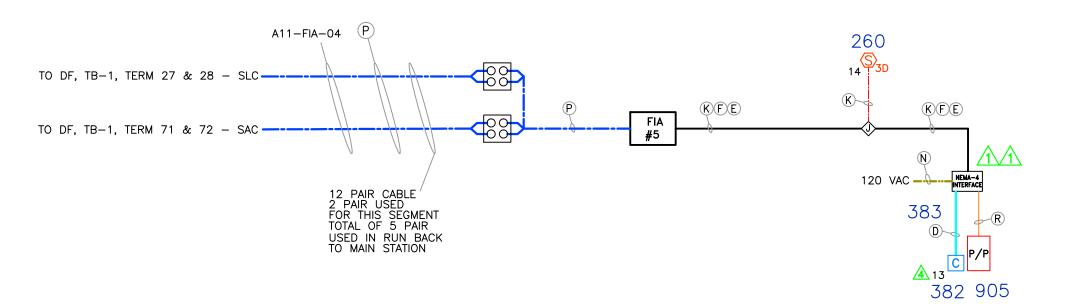


FLANDERS AVENUE TIE BREAKER STATION (600+65)

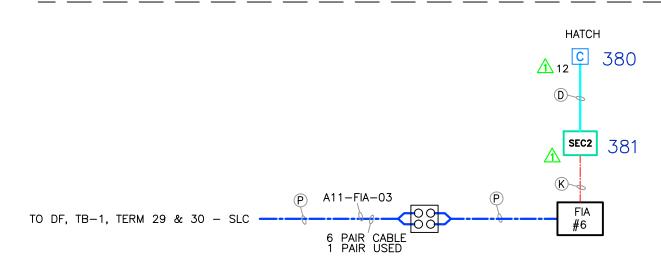


<u>EMERGENCY EXIT A-2 (583+05)</u> \_\_ \_ \_ \_ \_ \_ \_ \_ \_ \_ \_ \_ \_ \_ \_ \_

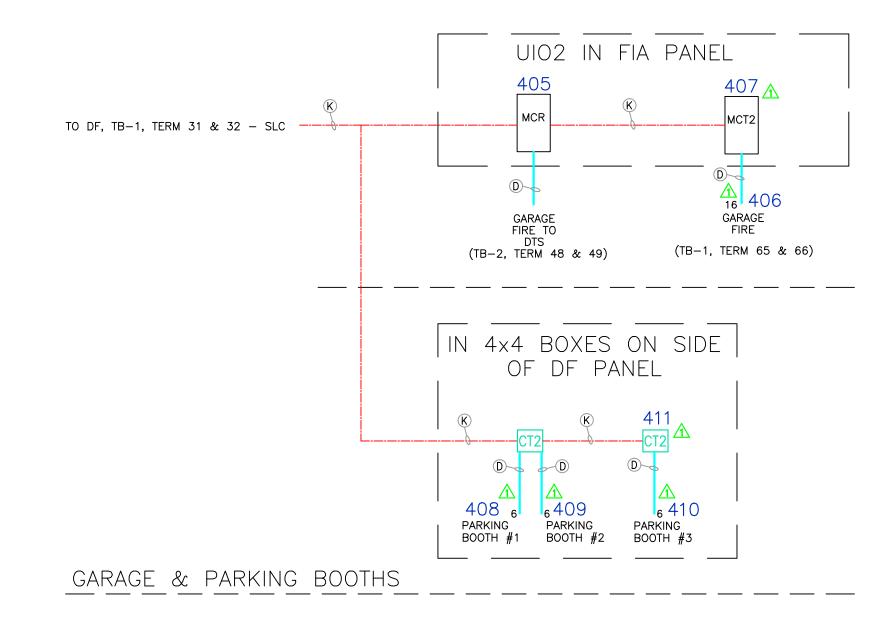

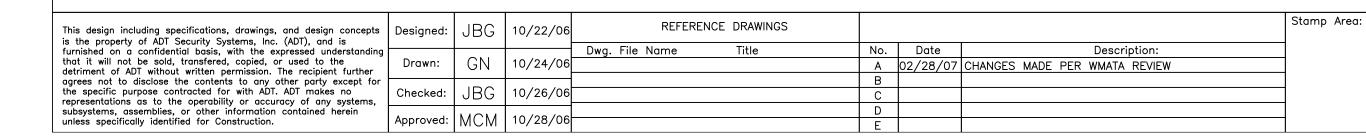



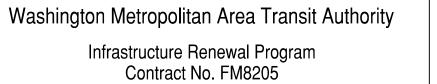



ADT Security Serv Systems Sales & E	ices, I	١
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602 Office Center	r Drive	
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(210) 004 740		۰

	Directory:	<b></b>	A <b>T</b> 11140	D.E.
	WMATA\GROSVENO	JK SIK	AIHMU	KE
ervices, I	n <sub>Eilename:</sub>		Format:	
: Engine	neillename:  ***********************************	<b>Panel</b>		
DA 1001	Station:	Station	No.:	
450 ext	Station: GROSVENOR STRATHMORE		Α	<u> 11 </u>
	DWG No:		Rev:	
	ADT-A11-FIA-005		A	

## INTERCOM STATION DETAIL

1 — CENTRAL EXCHANGE (CE)

### INSTALLATION HOOK-UPS

### CENTRAL EXCHANGE (CE #1) CENTRAL EXCHANGE (CE #2) IISA115650A GE100-16 DC GEZ100-32 DC IISA115651A HSA115652A GETA100 SUNSCRIBER CARD IISA115653A EE411-DC MASTER STATION EE420-DC IISA115654A MASTER STATION MASTER STATION IISA115655A EE442-DC IISA115656A ET508-DC CALL UNIT IISA115657A FILTER MODULE 1-PORT LFM-1 IISA115658A 2LM 2-LED MODULE

**SCHEMATICS** 

IISA115600A	WMATA INTER-COMMUNICATION	1—CE CONFIGURATION COVER SHEET / INDEX
IISA115601A	WMATA INTER-COMMUNICATION	SYSTEM BLOCK DIAGRAM, MAJOR EQUÍPMENT LIST & CHART ID
IISA115602A	WMATA INTER-COMMUNICATION	PRIMARY KIOSK CABLE ROUTING
IISA115603A	WMATA INTER-COMMUNICATION	CE INTERCONNECTION
IISA115604A	WMATA INTER-COMMUNICATION	PERS INTERCOM WIRING INTERCONNECTIONS
IISA115605A	WMATA INTER-COMMUNICATION	ELEVATOR INTERCOM WIRING INTERCONNECTIONS
IISA115606A	WMATA INTER-COMMUNICATION	IDF INTERCONNECTIONS
IISA115607A	WMATA INTER-COMMUNICATION	CE TO IDF WIRING
		CENTRAL EXCHANGE UNIT LAYOUT
		KIOSK MASTER STATION TO CE UNIT WIRING DETAILS
		KIOSK PAID / UNPAID ENTRY CALL STATION TO CE UNIT WIRING DETAIL
		STROBE AND SONALERT TO CE UNIT WIRING DETAIL
		ELEVATOR CALL STATION WIRING DETAILS (PLAT 1 LEVEL)
		ELEVATOR CALL STATION WIRING DETAILS (STREET 1 LEVEL)
		ELEVATOR CALL STATION WIRING DETAILS (CAR PANEL & TOC JACK)
		ELEVATOR CALL STATION WIRING DETAILS (MACHINE ROOM MASTER STATION)
IISA115613A-1	WMATA INTER-COMMUNICATION	PASSENGER EMERGENCY PERS STATION WIRING DETAILS
IISA115613A-2	WMATA INTER-COMMUNICATION	PASSENGER EMERGENCY PERS STATION WIRING DETAILS

		REFERENCE DRAWINGS		REVISIONS					
	NUMBER	DESCRIPTION	NO.	DESCRIPTION	B		DATE	FN3020	
DRAWN: J. LoPIER 11/3/05				INITIAL RELEASE				NEXT ASSY.	
. DATE								NEAT A331.	
CHECKED: DATE		*							
APPROVED:									
DATE									
APPROVED:								FILE:	
DATE									

WASHINGTON	METROPOLITAN	AREA	TRANSIT	AUTHORITY
			Rama 8-30 129° S LEGE POINT	

A11 GROSVENOR
WMATA INTER-COMMUNICATION
1-CE CONFIGURATION
COVER SHEET / INDEX


LEGE POINT NY 11356			*		
0.	SIZE	SCALE	WMATA DRAWING NO.	SHEET	REV.
3534A11A001	D	NONE	IISA115600A	1 OF 1	-

### CHART ID

RAMEX PART #	DESCRIPTION
GE100-16DC	CENTRAL EXCHANGE EQUIPPED FOR 16 STATIONS
GEZI-100-32DC	EXPANSION EXCHANGE EQUIPPED FOR ADD'L 16 STATIONS
G1-SA-DC	CALL PLACEMENT STROBE WITH SONALERT
EE420-DC	KIOSK MASTER STATION, WALL UNIT
EE442-DC	MACHINE ROOM MASTER STATION, WALL UNIT
EE411-DC	PORTABLE TOP OF CAR MASTER STATION
R22030-DC	WALL ENCLOSURE, TOP OF CAR MASTER STATION
ES433-DC	KIOSK, PAID / UNPAID CALL STATION
ET508-DC	ELEVATOR CAR, LANDING, CALL STATION
ET508-PERS	PASSENGER EMERGENCY STATION, PERS
RJ11-DC	TOP OF CAR RECEPTACLE FOR EE411-DC
ENC 100K-DC	ENCLOSURE WITH INTERCONNECTING PCB ASSEMBLY
ADA BRAILLE DECALS	BRAILLE DECAL ON ELEV CAR PANEL, MEZZ, STREET, PLAT
ADA BRAILLE EMER DECALS	BRAILLE DECAL ON ELEVATOR CAR PANEL
CALL BUTTONS	CALL BUTTON, ELEVATOR PANEL, MEZZANINE, STREET, PLAT
R18096	IDF #1 USED FOR INTERCONNECTING IN KIOSK
R18097	IDF #2 USED FOR INTERCONNECTING IN KIOSK
R10024	SHELF WITH POWER SUPPLY & AC POWER STRIP


MAJOR EQUIPMENT LIST

LOCATION	UNIT DISPLAY ID	INTERCOM EXTENSION
MASTER/CALL STATION	UP TO 6 CHARACTERS	2-DIGITS
KIOSK	KIOSK1	10
PAID PASSENGER	PAID 1	12
UNPAID PASSENGER	UNPD 1	11
PERS #1	PERS 1	41
PERS #2	PERS 2	42
PERS #3	PERS 3	43
PERS #4	PERS 4	44
MACHINE ROOM #1	M/R 1	20
TOP OF CAR #1 MASTER CALL STATION	CAR 1	22
CAR INTERCOM #1	CAR 1	22
MEZZANINE LANDING #1	MEZZ 1	23
PLATFORM LANDING #1	PLAT 1	21
STREET LANDING #1	STRET 1	24
MACHINE ROOM #2	M/R 2	30
TOP OF CAR #2 MASTER CALL STATION	CAR 2	32
CAR INTERCOM #2	CAR 2	32
MEZZANINE LANDING #2	MEZZ 2	33
PLATFORM LANDING #2	PLAT 2	31
STREET LANDING #2	STRET 2	34
	•	
· GR	OUP CALLS	
ALL STATION GROUP PAGE	010	
MASTER STATION GROUP PAGE	011	
ELEVATOR STATION GROUP PAGE	012	
PERS STATION GROUP PAGE	013	
UNPAID/PAID GROUP PAGE	014	

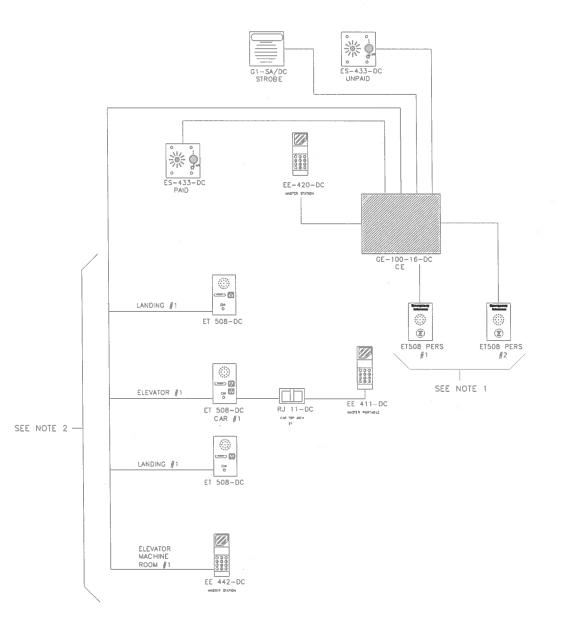

- NOTES: 1. TYPICAL PERS LAYOUT. MAX 4 PERS PER 1-CE CONFIGURATION
- 2. TYPICAL ÉLÉV LAYOUT MAX 2 ELEV & ASSOCIATED CALL UNITS PER 1-CE CONFIG.
- 3. ADA DECALS & CALL BUTTON PART #'S ARE XXXX ON STATION DWG'S
- 4. TYPICAL ELEV LAYOUT MAX 2 ELEV & ASSOCIATED CALL UNITS PER 1-CE CONFIG.

		REFERENCE DRAWINGS		REVISIONS			CONTRACT NO.			
	NUMBER	DESCRIPTION	NO.	DESCRIPTION	BY AP	DA1E	FN3020	WASHINGTON METROPOLITA	AN AREA TRANSIT AUTHORIT $\dagger$	
DRAWN: J. LoPIER 11/3/05			-	INITIAL RELEASE			NEXT ASSY.			WMATA INTER-COMMUNICATION
DATE				,		1	NEAT ASST.			SYSTEM BLOCK DIAGRAM, MAJOR
CHECKED: DATE			-						(((( Ramex ))))	EQUIPMENT LIST & CHART ID
APPROVED:										EQUIPMENT LIST & CHART ID
DATE					_ _ _		-		18-30 129 STREET	
APPROVED:							FILE:	The state of the s	COLLEGE POINT NY 11356	
DATE			-				-	Medro	24534A11A002	SIZE SCALE WMATA DRAWING NO. SHEET REV.  D NONE IISA115601A 1 OF 1 -

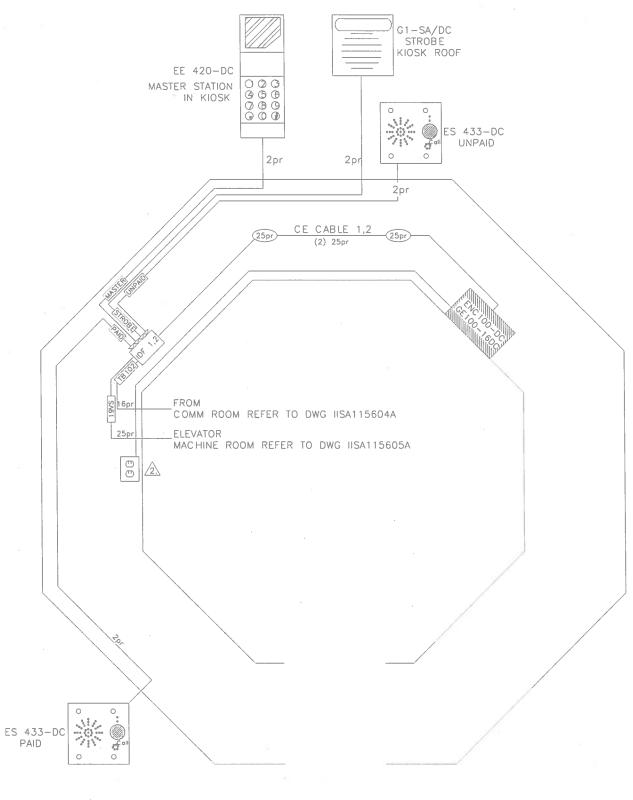

NOTES:
1. PAID UNIT LOCATION VARIES.

AC POWER OUTLET SHOWN REPRESENTS
POWER STRIP ON CE SHELF AND AC OUTLET
AT REAR OF VIDEO MONITORS.

REFERENCE DRAWINGS REVISIONS DESCRIPTION NUMBER - INITIAL RELEASE DRAWN: J. LoPIER CHECKED:


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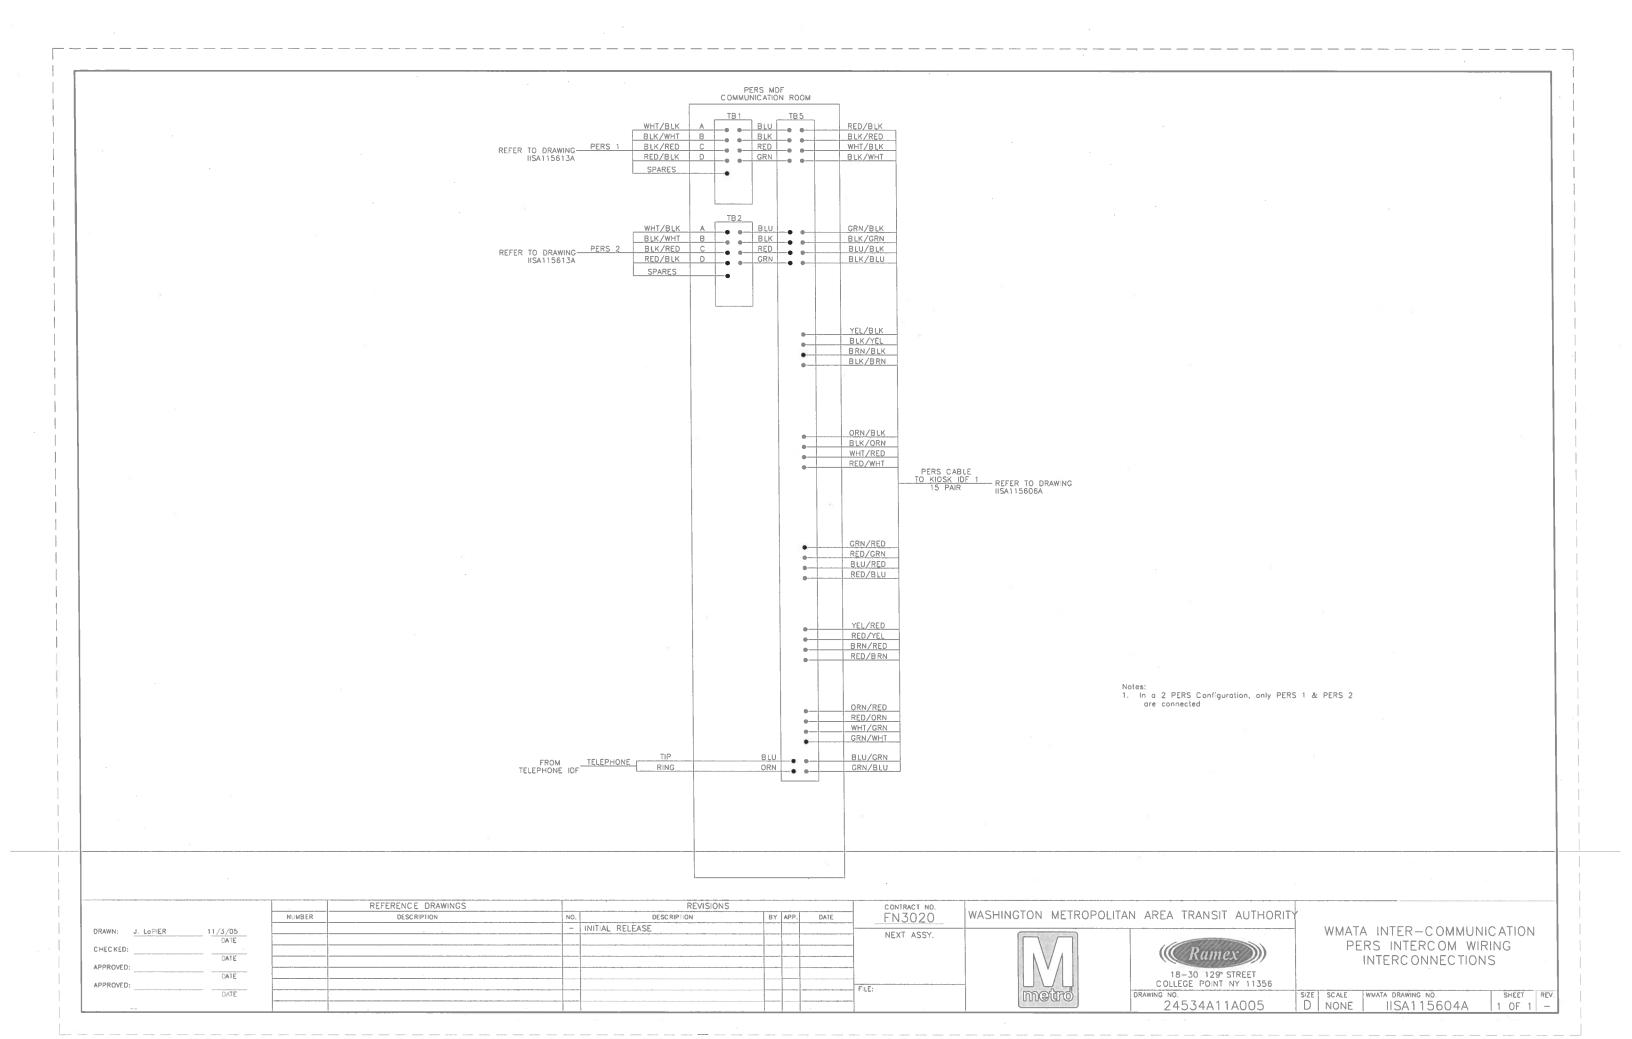
WASHINGTON METROPOLITAN AREA TRANSIT AUTHORITY




((Ramex )) 18-30 129" STREET COLLEGE POINT NY 11356 WMATA INTER-COMMUNICATION PRIMARY KIOSK CABLE ROUTING

SHEET REV. SIZE SCALE D NONE WMATA DRAWING NO.
USA115602A RAWING NO. 24534A11A003



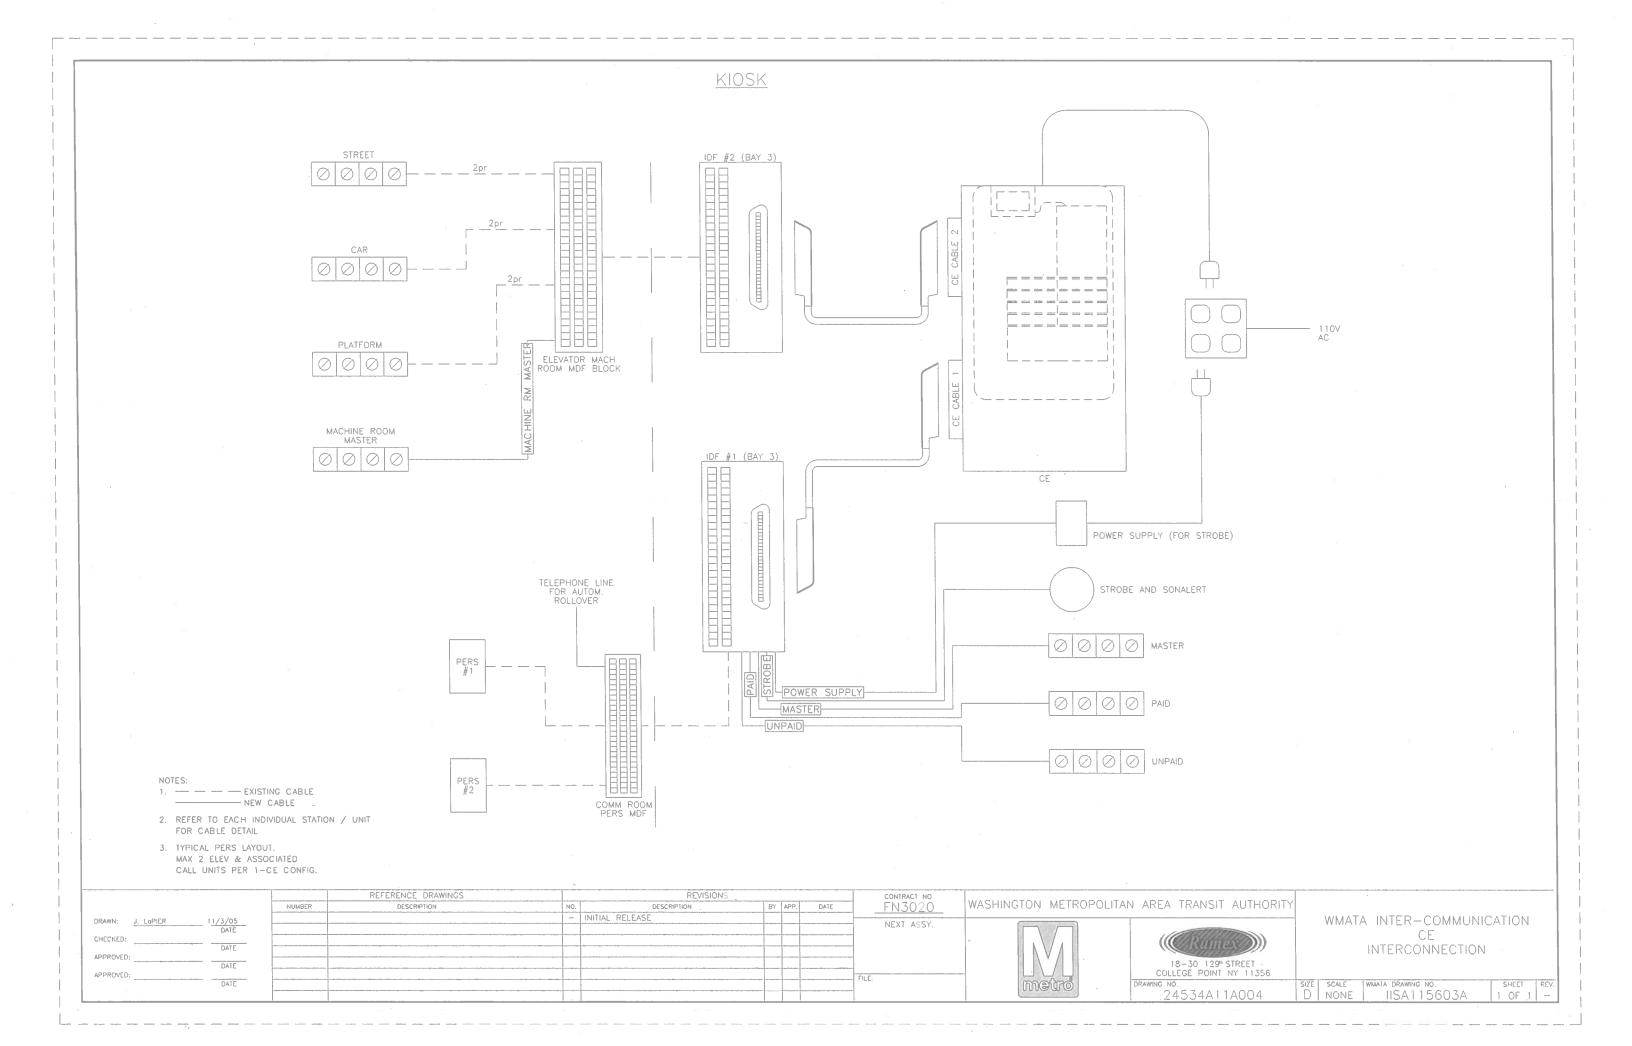

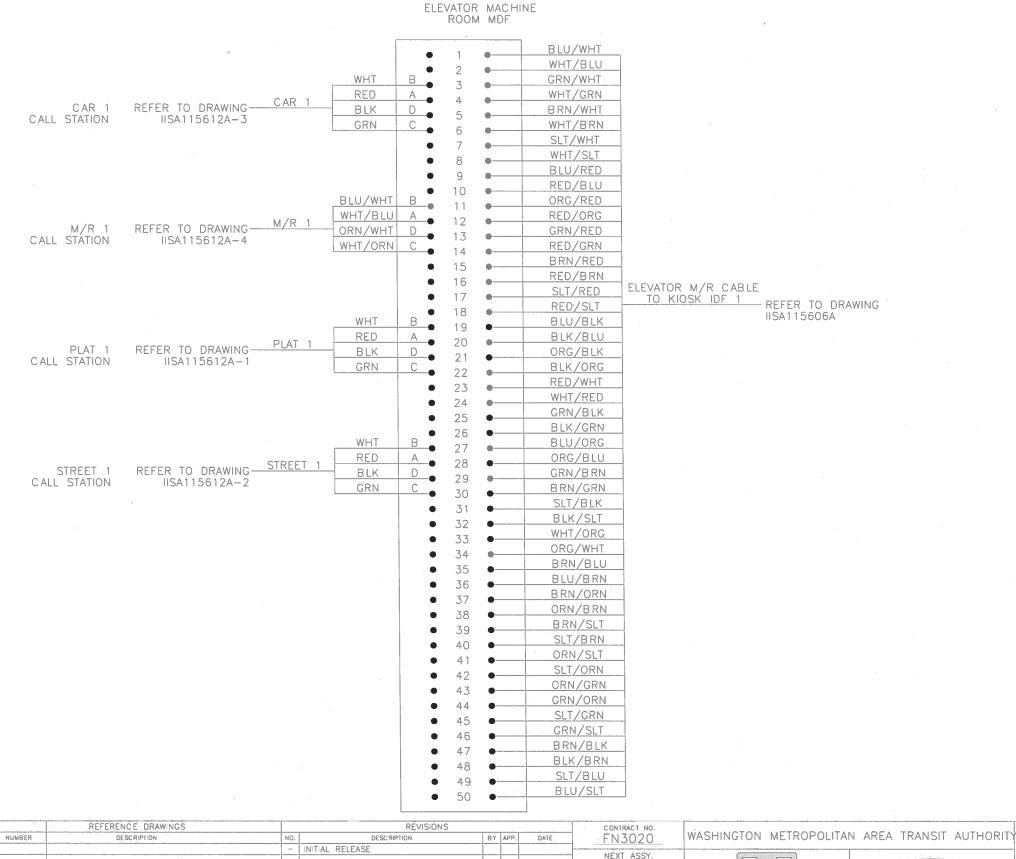

DRAWN: J. LoPIER

DATE


CHECKED:

APPROVED:

((( Ramex ))) 18-30 129h STREET COLLEGE POINT NY 11356 WMATA INTER-COMMUNICATION ELEVATOR INTERCOM WIRING INTERCONNECTIONS

DRAWING NO. 24534A11A006

SIZE SCALE WMATA DRAWING NO.
D NONE IISA115605A SHEET REV.

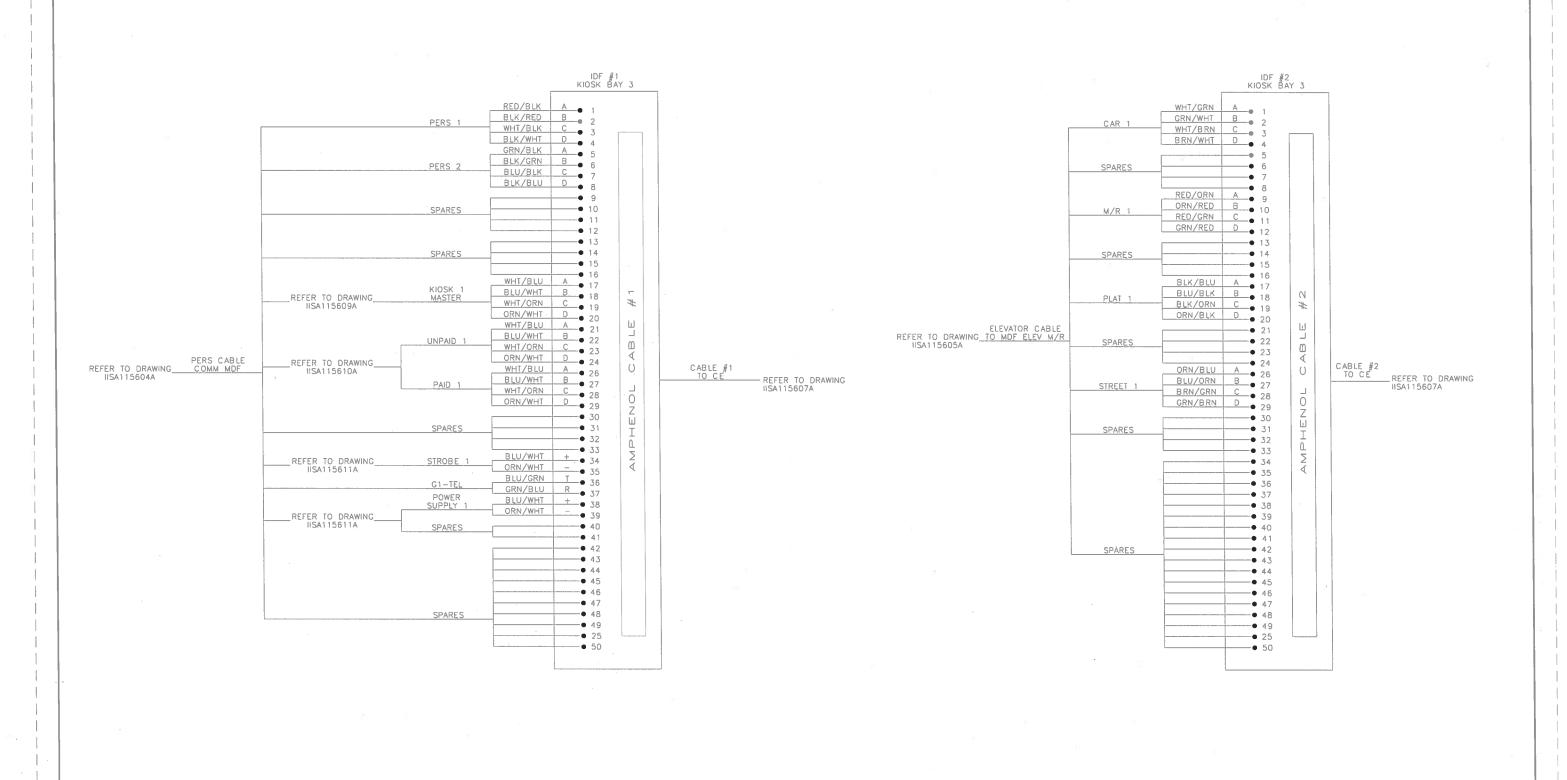

			REFERENCE DRAWINGS		RÉVISIONS			CONTRACT NO.			
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	DATE							NEXT ASST.			IDE
CHECKED:	P. 4 T. P.									(((( Ramex )))	IUF
APPROVED:	DATE									Hamos	INTERCONNECTIONS
	DATE									18-30 129" STREET	
APPROVED:								Fit F:		COLLEGE POINT NY 11356	
1.	DATE								metro	DRAWING NO.	SIZE SCALE WMATA DRAWING NO. SHEET REV
		1	<u> </u>							24534A11A007	D NONE   IISA115606A   1 OF 1 -

### CABLE #1 TO CE 1

FUNCTION	PIN #	DF #1	PIN #	SLOT #	CE SUB #		- APD
		COLOR		SLOT #	SUD #		CARD
	1	WHT/BLU	26			A	WHT/BLU
PERS 1	3	BLU/WHT	1	4	1	B C	BLU/WHT
		WHT/ORG	27	-			WHT/ORG
	4	ORG/WHT	2			D	ORG/WHT
	5	WHT/GRN	28	-		A	WHT/GRN
PERS 2	6	GRN/WHT	3	4	2	В	GRN/WHT
	7	WHT/BRN	29	_	1	С	WHT/BRN
	8	BRN/WHT	4			D	BRN/WH
	9	WHT/SLT	30	-		A	WHT/SLT
	10	SLT/WHT	5	4	3	В	SLT/WHT
	11	RED/BLU	31			С	RED/BLU
	12	BLU/RED	6			D	BLU/RED
	13	RED/ORG	32			Α	RED/ORC
	14	ORG/RED	7	4	4	В	ORG/RED
	15	RED/GRN	33	_	'	С	RED/GRN
	16	GRN/RED	8			D	GRN/RED
	17	RED/BRN	34	_		Α	RED/BRI
KIOSK 1	18	BRN/RED	9	1	1	В	BRN/REI
1170011	19	RED/SLT	35	<u>'</u>	,	С	RED/SLT
	20	SLT/RED	10			D	SLT/RED
	21	BLK/BLU	36			A	BLK/BLU
UNPAID 1	22	BLU/BLK	11	1	2	B	BLU/BL
01417410	23	BLK/ORG	37	_ '	4	С	BLK/ORG
	24	ORG/BLK	12			D	ORG/BL
	26	BLK/GRN	38			Α	BLK/GRI
PAID	27	GRN/BLK	13	1	3	В	GRN/BL
	28	B'LK/BRN	39	_ '		С	BLK/BR
	29	BRN/BLK	14			D	BRN/BL
	30	BLK/SLT	40			Α	BLK/SLT
SPARE	31	SLT/BLK	15	1	4	В	SLT/BLK
JI AIL	32	YEL/BLU	41	_ '	7	С	YEL/BLU
	33	BLU/YEL	16			D	BLU/YEL
STROBE	34	YEL/ORG	42	M/B*	N/A	CMN	YEL/ORG
JINOBE	35	ORG/YEL	17	IVI/ U	117/	S1-1	ORG/YEL
G1-TEL	36	YEL/GRN	43	Α	N/A	- 2	YEL/GRI
GI-ILL	37	GRN/YEL	18	^	IN/ A	3	GRN/YE
P/SUPPLY	38	YEL/BRN	44	M/B*	NI /A	CMN	YEL/BRI
F/30FFLT	39	BRN/YEL	19	IVI7 D	N/A	S1-2	BRN/YE
	40	YEL/SLT	45	М/В*	NI /A	S1-3	YEL/SLT
	41	SLT/YEL	20	INI / D	N/A	S1-4	SLT/YEL
	42	VIO/BLU	46				
	43	BLU/VIO	21				
	44	VIO/ORG	47				
	45	ORG/VIO	22				
	46	VIO/GRN	48	İ			
	47	GRN/VIO	23			<u> </u>	
	48	VIO/BRN	49				
	49	BRN/VIO	24				
	25	VIO/SLT	50				
	50	SLT/VIO	25				

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				M/B = MOTHERBOARD		
		REFERENCE DRAWINGS		REVISIONS		CONTRACT NO
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DDAWN				INITIAL RELEASE		
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# WASHINGTON METROPOLITAN AREA TRANSIT AUTHORITY

VIO/GRN

GRN/VIO

VIO/BRN

BRN/VIO

VIO/SLT

SLT/VIO



46

47

48

49

25

50



WMATA INTER-COMMUNICATION CE TO IDF WIRING

SIZE SCALE WMATA DRAWING NO.

D NONE IISA115607A SHEET REV.

ORG/RED 3 15 RED/GRN 33 RED/GRN 16 GRN/RED D GRN/RED RED/BRN 34 RED/BRN 18 BRN/RED BRN/RED PLAT 1 2 19 RED/SLT 35 RED/SLT 20 SLT/RED 10 SLT/RED BLK/BLU 36 BLK/BLU 22 BLU/BLK 1 1 BLU/BLK 3 23 BLK/ORG 37 BLK/ORG 24 ORG/BLK 12 D ORG/BLK 26 BLK/GRN 38 BLK/GRN 27 GRN/BLK 13 В GRN/BLK STRET 1 2 28 BLK/BRN 39 BLK/BRN 29 BRN/BLK 14 D BRN/BLK 30 BLK/SLT BLK/SLT 40 31 SLT/BLK 15 SLT/BLK 3 32 YEL/BLU YEL/BLU 41 33 BLU/YEL D BLU/YEL 16 34 YEL/ORG 35 ORG/YEL 36 YEL/GRN 43 37 GRN/YEL 18 38 YEL/BRN 44 39 BRN/YEL 19 40 YEL/SLT 45 41 SLT/YEL 20 42 VIO/BLU 46 43 BLU/VIO 21 44 VIO/ORG 47 45 ORG/VIO 22

48

23

49

24

50

25

CABLE #2 TO CE 1

26

27

28

29

4

30

31

6

32

COLOR PIN # SLOT # SUB #

2

3

2

CARD

D

D

WHT/BLU

BLU/WHT

WHT/ORG

ORG/WHT

WHT/GRN

GRN/WHT

WHT/BRN

BRN/WHT

WHT/SLT

SLT/WHT

RED/BLU

BLU/RED

RED/ORG

ORG/RED

IDF #1

WHT/BLU

BLU/WHT

WHT/ORG

ORG/WHT

WHT/GRN

GRN/WHT

WHT/BRN

BRN/WHT

WHT/SLT

SLT/WHT

RED/BLU

BLU/RED

RED/ORG

12

13

14

FUNCTION

CAR 1

M/R 1

MAIN UNIT CE #1

АВС

		REFERENCE DRAWINGS		REVISIONS			
	NUMBER	DESCRIPTION	NO.	DESCRIPTION	BY	APP.	DATE
DRAWN: J. LoPIER 11/3/05				INITIAL RELEASE			
CHECKED:						-	
DATE		· · · · · · · · · · · · · · · · · · ·					
APPROVED:							
APPROVED: DATE				***************************************		-	
DATE							

CONTRACT NO. FN3020 NEXT ASSY.

WASHINGTON METROPOLITAN AREA TRANSIT AUTHORITY

(Rumex)



Ramex

18-30 129" STREET

COLLEGE POINT NY 11356


DRAWING NO.

WMATA INTER-COMMUNICATION CENTRAL EXCHANGE UNIT LAYOUT

| SIZE | SCALE | WMATA DRAWING NO. | SHEET | REV. | | STALE | STALE | STALE | WMATA DRAWING NO. | SHEET | REV. | STALE | | STA

KIOSK

## KIOSK MASTER STATION

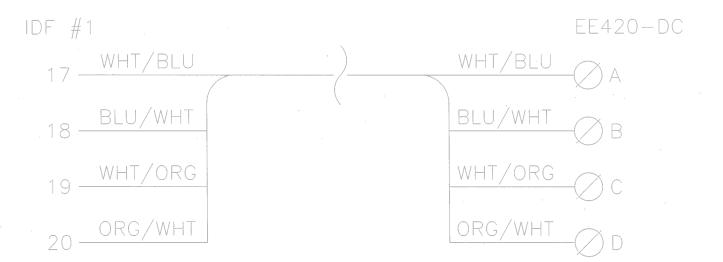

NOTES:

SCREW TERMINAL

17 — POSITION ON IDF #1

		REFERENCE DRAWINGS		REVISIONS				CONTRACT NO.
	NUMBER	DESCRIPTION	NO.	DESCRIPTION	BY	APP.	DATE	FN3020
DRAWN: J. LaPIER 11/3/05			-	INITIAL - RELEASE	1		1	NEXT ASSY.
DATE								INEAT ASST.
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DATE						1	1	


20 WA


WASHINGTON METROPOLITAN AREA TRANSIT AUTHORITY





WMATA INTER-COMMUNICATION KIOSK MASTER STATION TO CE UNIT WIRING DETAILS

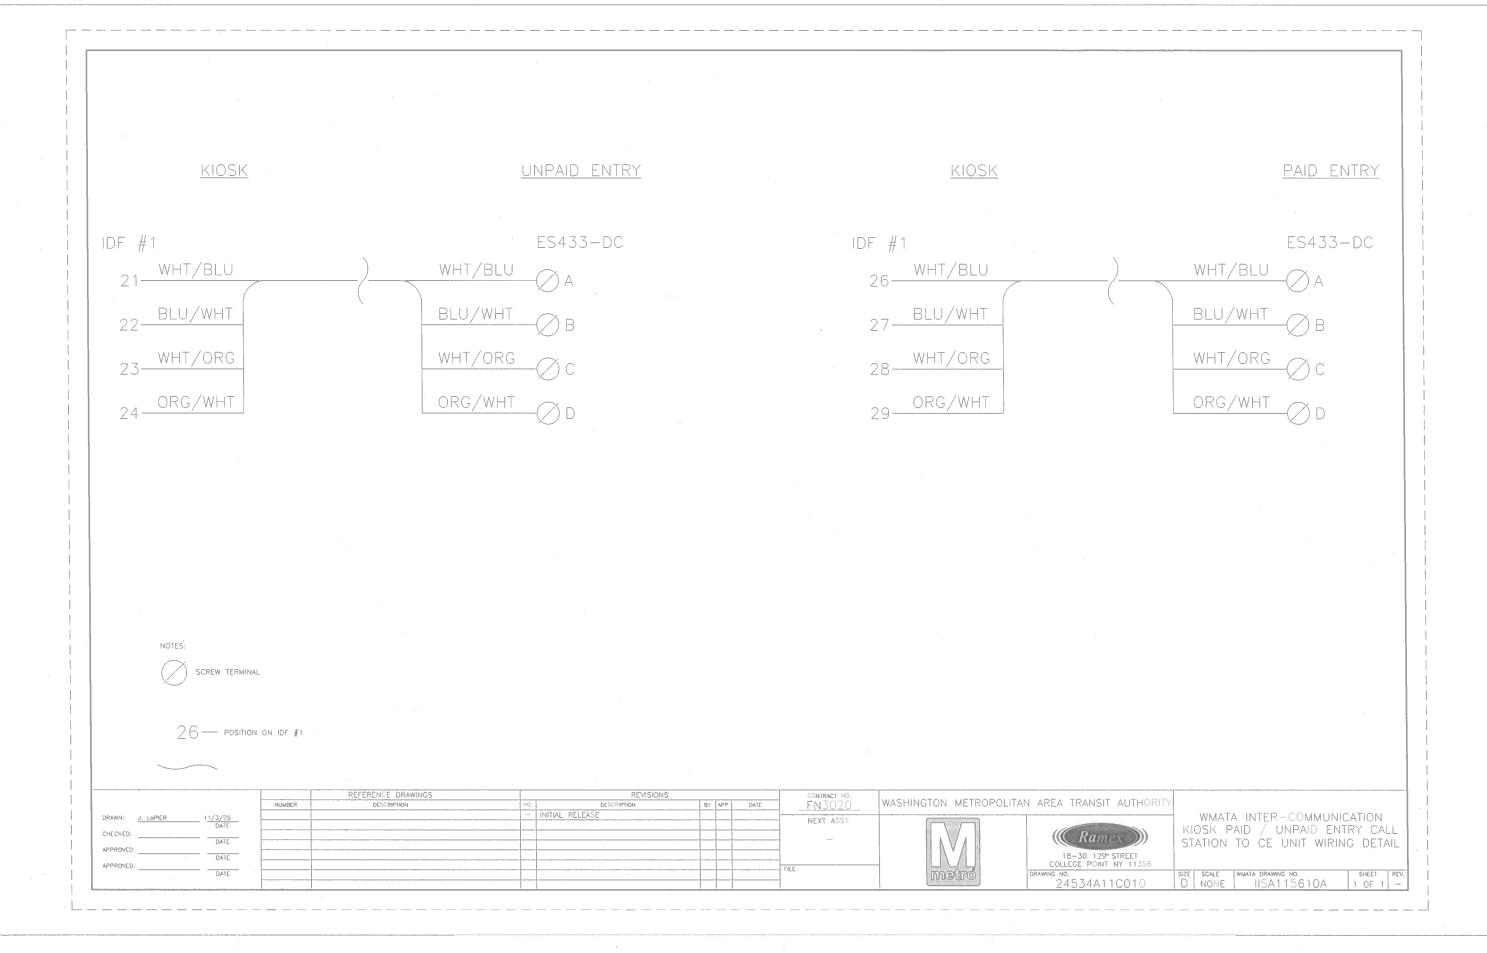

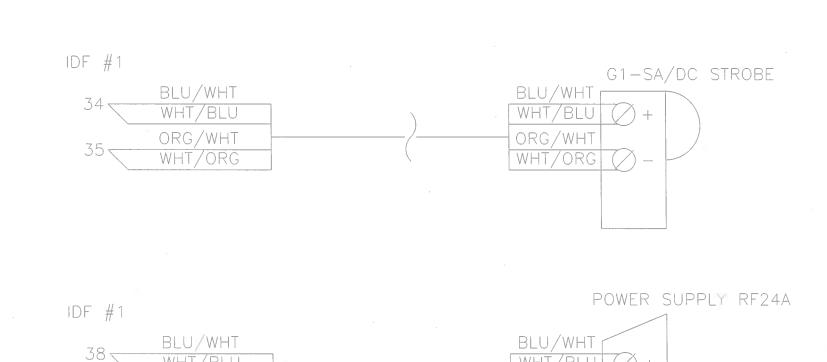

WHT/BLU () +

WHT/ORG () -

\_\_110VAC

ORG/WHT

WHT/BLU

ORG/WHT

WHT/ORG


39 <


NOTES:


SCREW TERMINAL


38 POSITION ON IDF #1


		REFERENCE DRAWINGS		. REVISIONS		CONTRACT NO.		
· .	NUMBER	DESCRIPTION	NO.	DESCRIPTION	BY APP.	PATE FN3020	WASHINGTON METROPOLITAN AREA TRANSIT AUTHORIT	Y
DRAWN: J. LoPIER 11/3/05				INITIAL RELEASE		NEXT ASSY.	Control of the Contro	WMATA INTER-COMMUNICATION
CHECKED:		PARTIES IN THE PARTIES OF THE PARTIE						STROBE AND SONALERT
DATE .								TO CE UNIT WIRING CETAIL
APPROVED: DATE							18-30 129° STREET	
APPROVED:						FM F:	COLLEGE POINT NY 11356	
DATE							DRAWING NO. 24534411C011	SIZE SCALE WMATA DRAWING NO. SHEET REV
	<u> </u>						24534ATTCUTT	D   NONE     IISA115611A   1 OF 1   -

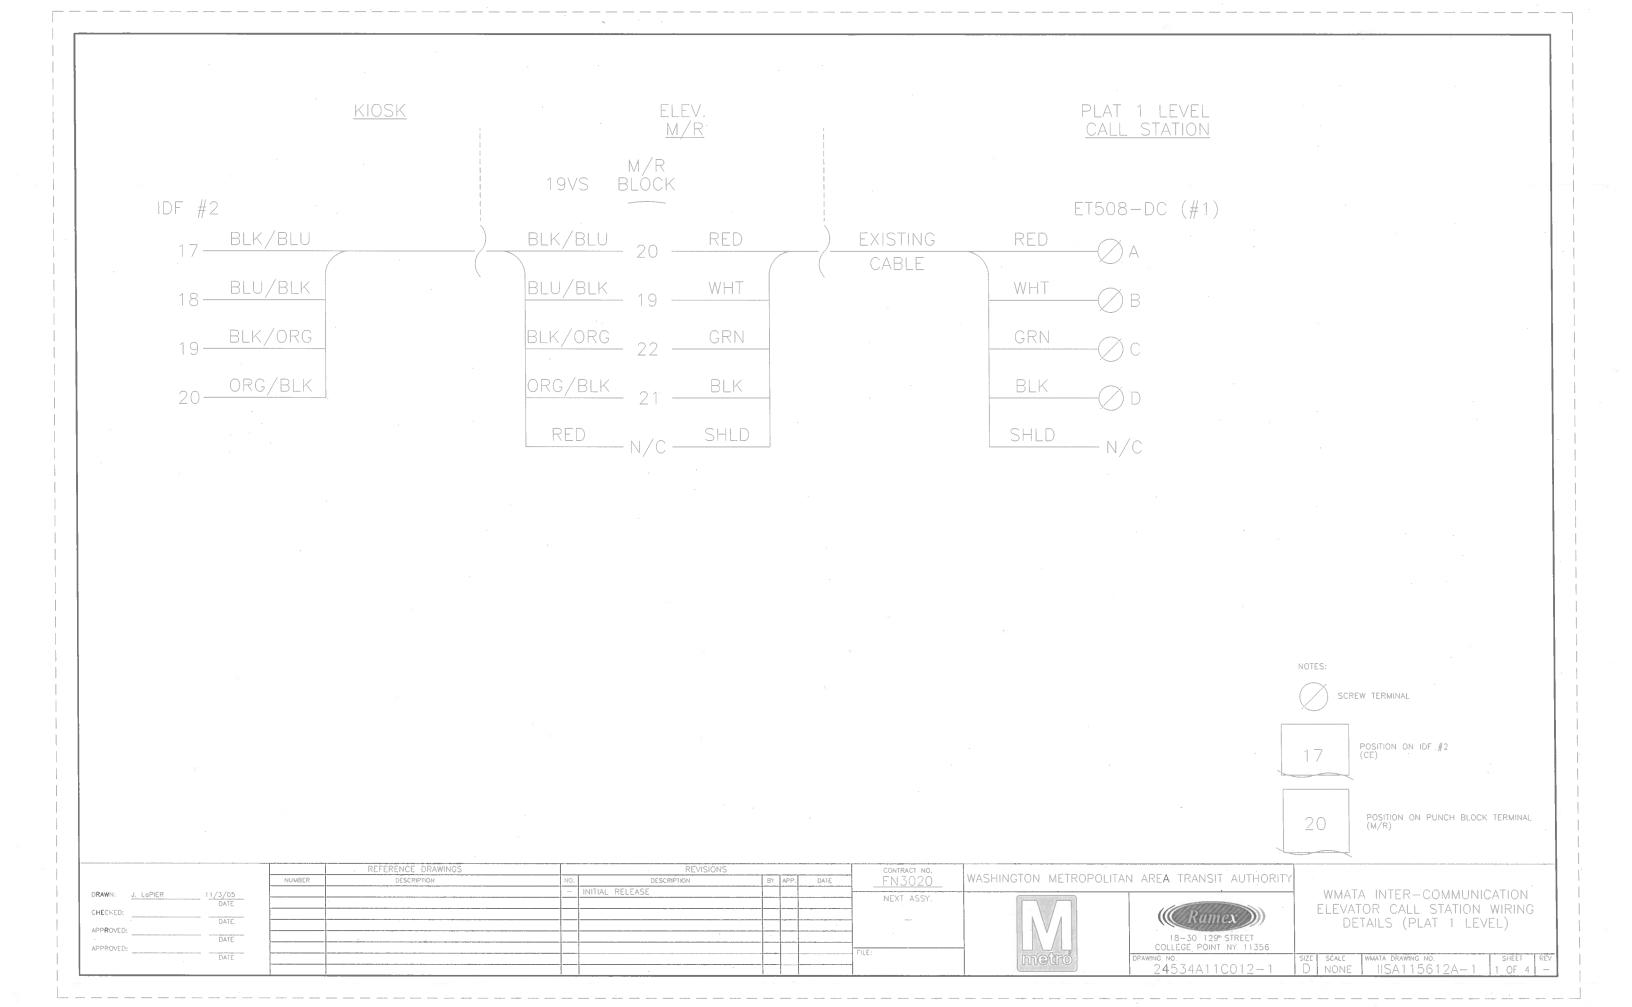


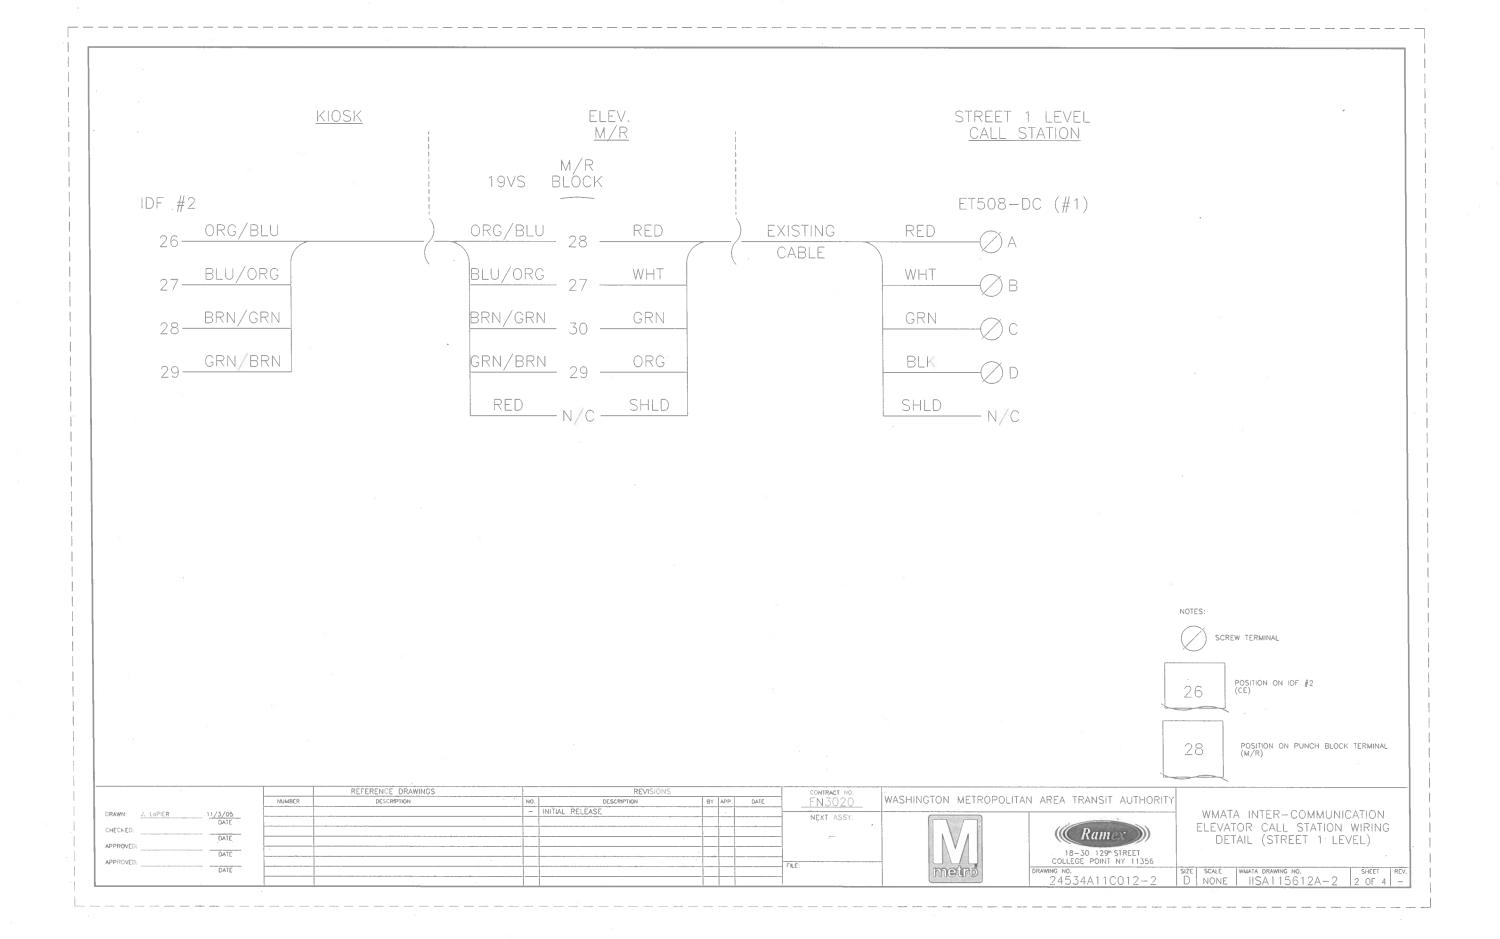

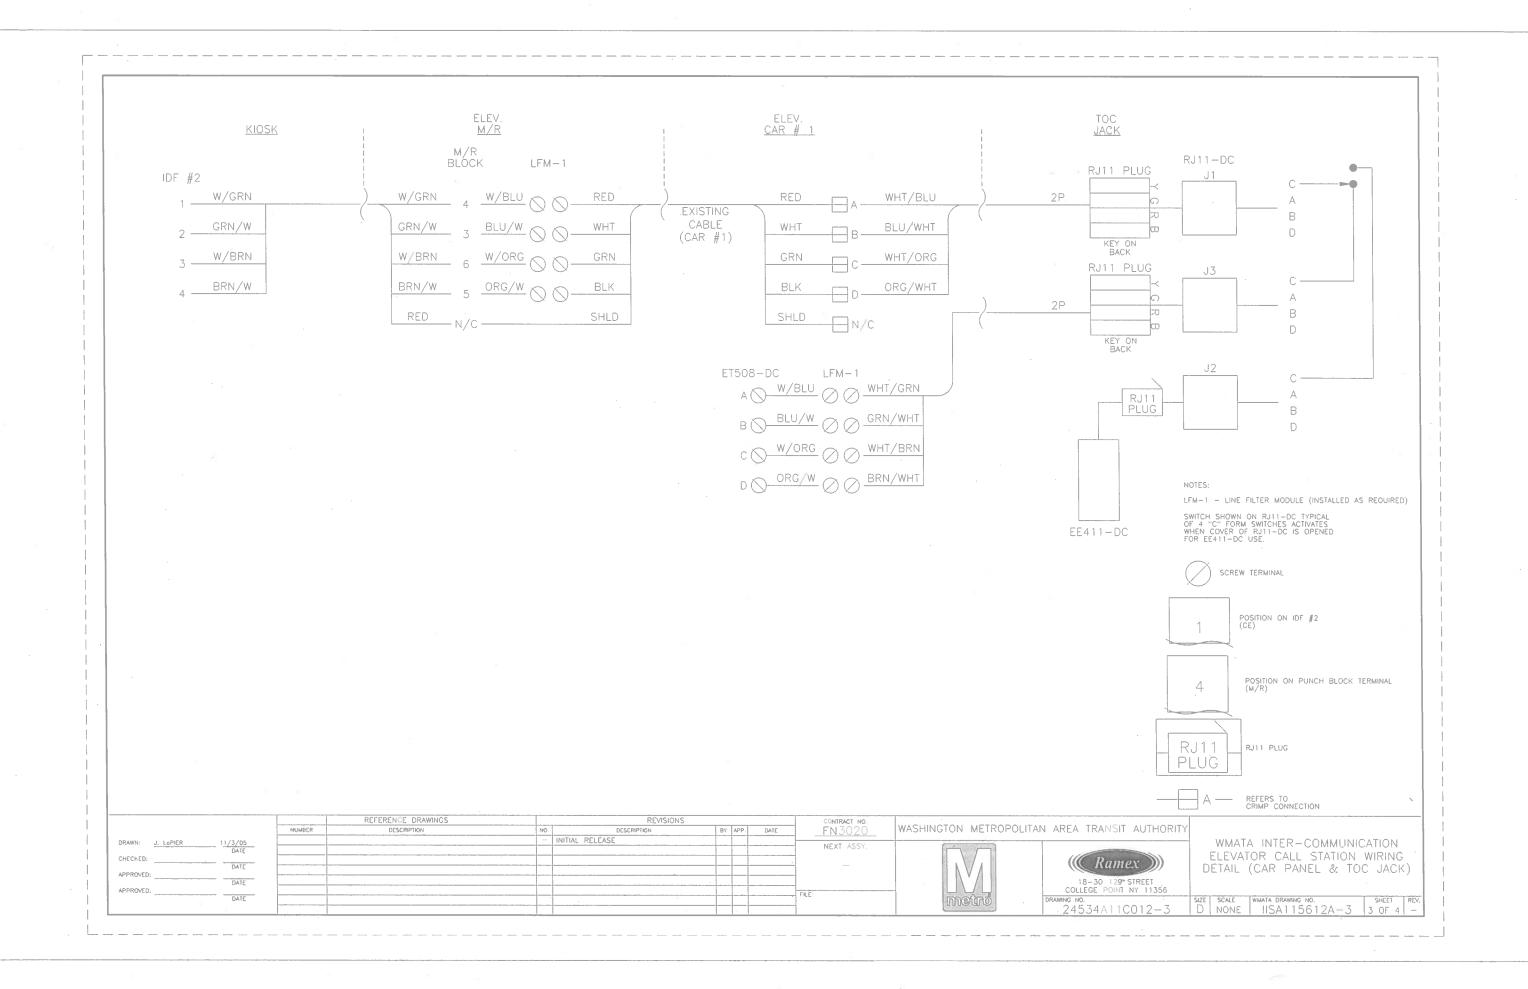

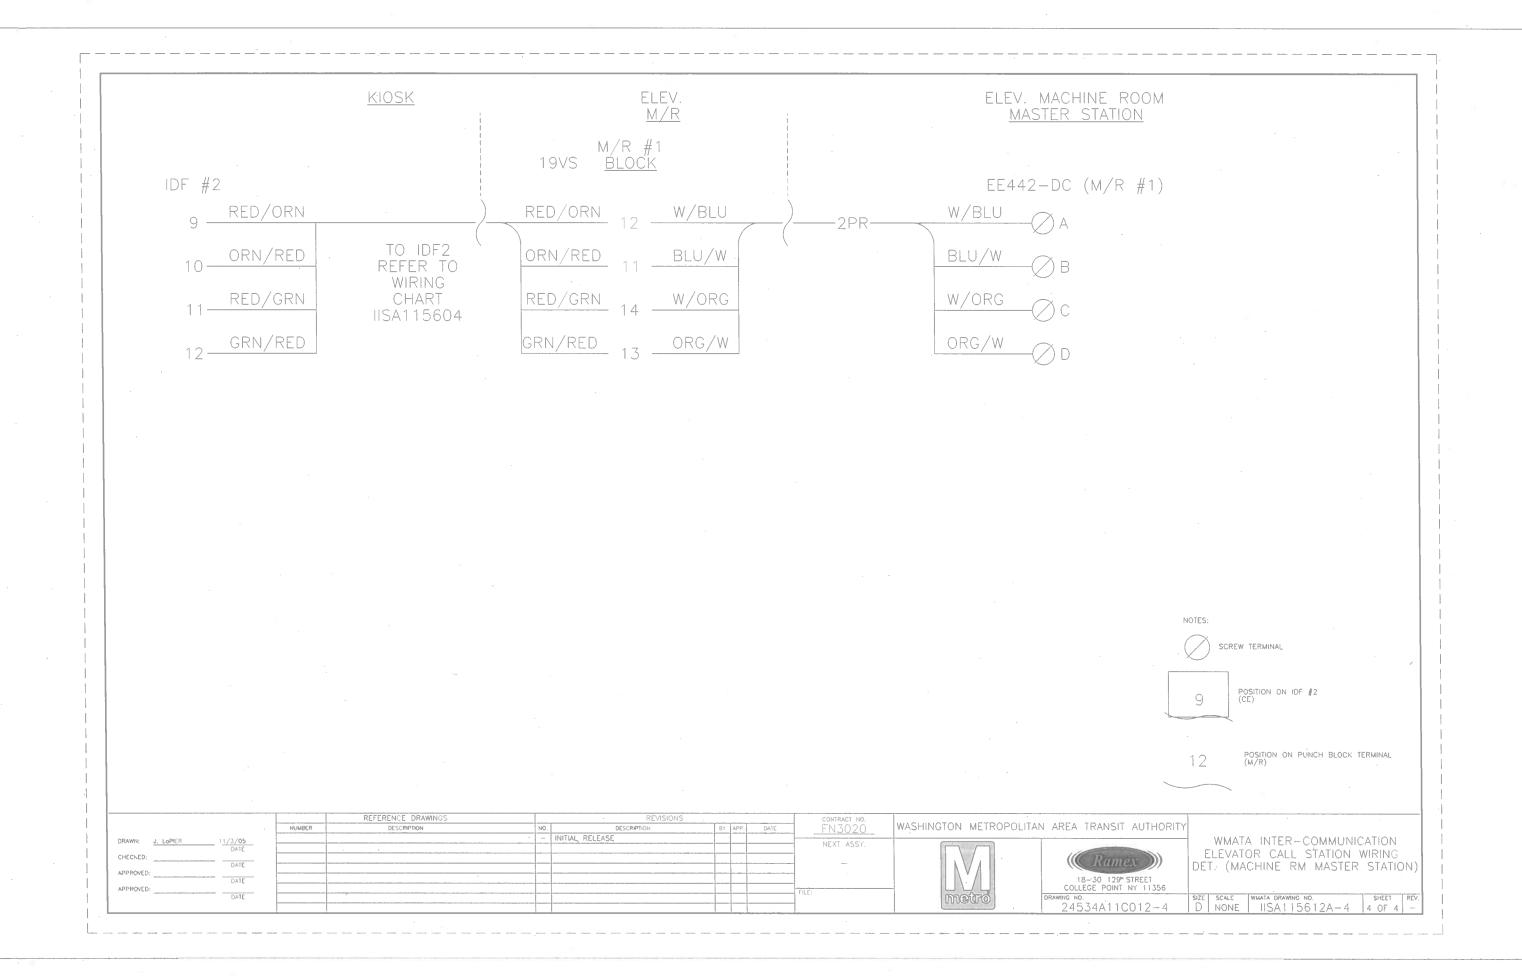

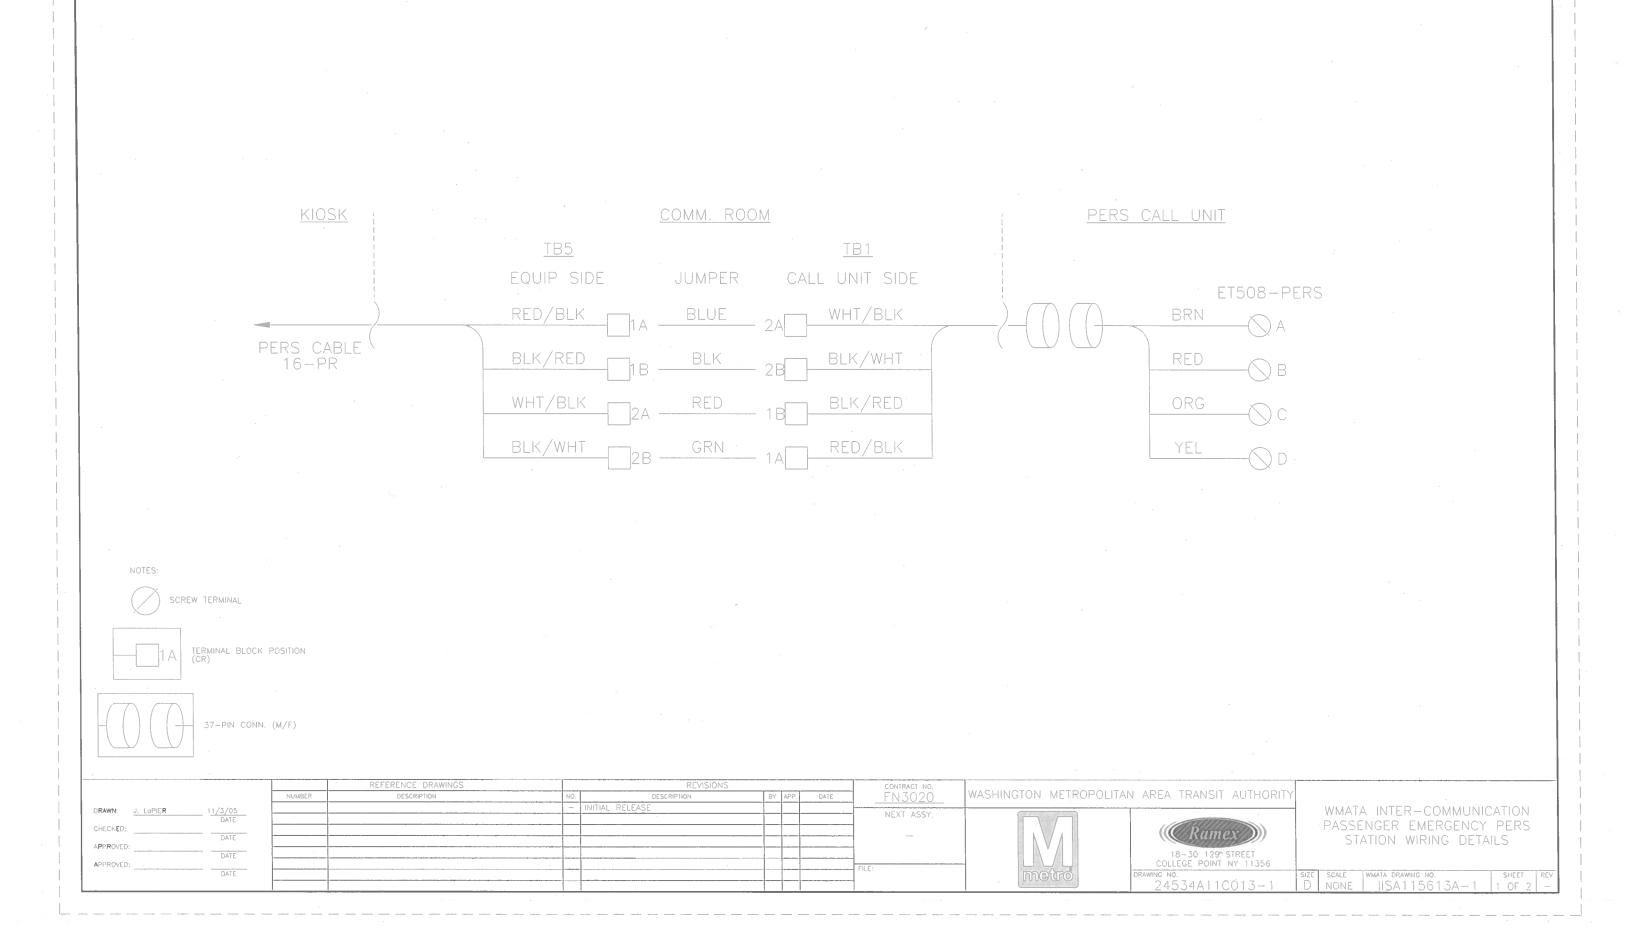

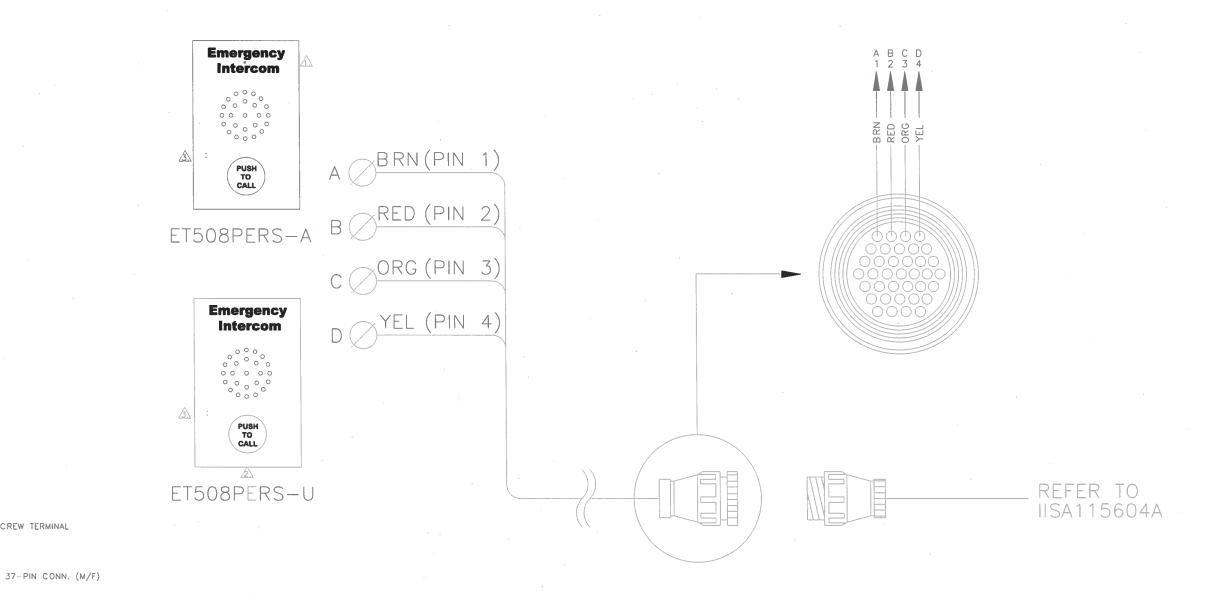

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A PART # ET508PERS-A

REFERS TO UNIT ABOVE

GROUND (MIC ON BASE)

SCREW TERMINAL


A PART # ET508PERS-U REFERS TO UNIT BELOW GROUND (MIC ON FRONT)

CALL PLACEMENT / CALL CONECTION LED

			REFERENCE DRAWINGS		REVISIONS			CONTRACT NO.			
	•	NUMBER	DESCRIPTION	NO.	DESCRIPTION	BY AP	P. DATE	FN3020_	WASHINGTON METROPOLIT	AN AREA TRANSIT AUTHORITY	
	DRAWN: J. LoPIER 11/3/05  CHECKED: DATE  APPROVED: DATE  APPROVED: DATE			- INIT(	AL RELEASE			NEXT ASSY.		((Ramex))  18-30 129 STREET  COLLEGE PONT NY 11356  DRAWING NO.	WMATA INTER—COMMUNICATION PASSENGER EMERGENCY PERS STATION WIRING DETAILS  SIZE SCALE WMATA DRAWING NO. SHEET REV.
L										24534A11C013-2	D NONE   IISA115613-2   2 OF 2 -


# WASHINGTON METROF REA TRANSIT AUTHORITY PASSENGER INFORMATICAL DISPLAY SYSTEM (PIDS) ELECTRICAL POWER PANELS

$\Box$	A	B SIGN LOCATION	C ROOM NO.	PANEL NO.	VOLTAGE	CIRCUIT NO.	G REMARKS
-	STATION STATES	MEZZANINEANINE EAST (11TH & G)	E200	EF	120	20	WALKWAY EQUIP ROOM
2	A01 METRO CENTER A01 METRO CENTER	EZZANINEANINE EAST (11TH & G)		WF	120	20	WALKWAY EQUIP ROOM
3	A01 METRO CENTER	PLATFORM (TRACK A1)	E103	EPO	480	12	AC SWITCHBOARD ROOM
5	A01 METRO CENTER	PLATFORM (TRACK A2)	W207	WHB	480	8	MECHANICAL EQUIPMENT ROOM
6	A Service of the Serv					A CONTRACTOR OF THE SECOND	
7	A02 FARRAGUT NORTH	MEZZANINEANINE NORTH	256	FARE VEND #1	120	36	AC SWITCHBOARD ROOM (NORTH MEZZANDIEANINE)
8	A02 FARRAGUT NORTH	MEZZANINEANINE CENTER	206	FARE VEND #3	. 120	35	CLEANERS ROOM
9	A02 FARRAGUT NORTH	MEZZANINEANINE SOUTH	209	SM	120	35	AC SERVICE ROOM
10	A02 FARRAGUT NORTH	PLATFORM	256	NPO	480	- 47	AC SWITCHBOARD ROOM (NORTH MEZZANINEANINE)
11		ACCOUNT CONTRACTOR OF THE STATE					
12	A03 DUPONT CIRCLE	MEZZANINEANINE NORTH	214	F1	120	24 26	AC SWITCHBOARD ROOM , AC SWITCHBOARD ROOM
13	A03 DUPONT CIRCLE A03 DUPONT CIRCLE	MEZZANINEANINE SOUTH PLATFORM (TRACK A1)	215 214	F2 T3	480	31, 33, 35	AC SWITCHBOARD ROOM
14	A03 DUPONT CIRCLE	PLATFORM (TRACK A2)	214	T3	480	32, 34, 36	AC SWITCHBOARD ROOM
15 16	200 DOT ON ON OL		4. 16.24 (1.344), 4.374 (1.44) 31. 16.26 (1.34)				
17	A04 WOODLEY PARK	PLATFORM	205	SPO3	480	6	AC SWITCHBOARD ROOM
18	A04 WOODLEY PARK	MEZZANINE	C207	F	120	26	MECHANICAL EQUIPMENT ROOM
19							
20	A05 CLEVELAND PARK	PLATFORM	216	NPO4	480	21	AC SWITCHBOARD ROOM
21	A05 CLEVELAND PARK	MEZZANINE	216	F	120	26	AC SWITCHBOARD ROOM
22		in the second second	The Balls	- 1-346 <sup>2</sup>	400	Section Section 1	
23	A06 VAN NESS	PLATFORM	203	SPO3	480	5	AC SWITCHBOARD ROOM
24	A06 VAN NESS	MEZZANINE	216	F	120	26	AC SWITCHBOARD ROOM
25	A07 TENI EXTOWN	PLATFORM	109	SPB	480	19, 21, 23	MAINTENANCE ROOM
26	A07 TENLEYTOWN A07 TENLEYTOWN	MEZZANINE	C206	MDD	120	19, 21, 23	WALLE BURNE NOOM
27	AUTIENLETIOWN	MEZZANINE	C200	WIDD	120	26	
28 29	A08 FRIENDSHIP HTS	PLATFORM	202	MNA	480	1	ELECTRICAL EQUIPMENT ROOM
30	A08 FRIENDSHIP HTS	MEZZANINE NORTH	202	MNCC	120	16	ELECTRICAL EQUIPMENT ROOM
31	A08 FRIENDSHIP HTS	MEZZANINE SOUTH	201	MSAA	120	17	MECHANICAL EQUIPMENT ROOM
32			30 Marie (304) 40		i organisada a	Paragarithe documents	
33	A09 BETHESDA	PLATFORM	209	SM	480	7	MECHANICAL EQUIPMENT ROOM
34	A09 BETHESDA	MEZZANINE	C203	F	120	29	CLEANERS ROOM
35	Jes i Agrica Maree (Ar. 1877)						MECHANICAL EQUIPMENT ROOM
36	A10 MEDICAL CENTER A10 MEDICAL CENTER	PLATFORM MEZZANINE	207	SM F	480 120	13 31	MECHANICAL EQUIPMENT ROOM  MECHANICAL EQUIPMENT ROOM
37	ATO MEDICAL CENTER	MEZZANINE	212			and the second	
38 39	A11 GROSVENOR	PLATFORM	107	SPO	480	22	AC SWITCHBOARD ROOM
40	A11 GROSVENOR	MEZZANINE	107	SF	120	16	AC SWITCHBOARD ROOM
41		A Cargo recover a colored to the Children		A STATE OF THE STA			
42	A12 WHITE FLINT	PLATFORM	107	SPO2	480	20, 22, 24	AC SWITCHBOARD ROOM
43	A12 WHITE FLINT	MEZZANINE	107	SPP	120	20	AC SWITCHBOARD ROOM
44					100		
45	A13 TWINBROOK	PLATFORM	C104	M-1 F-1	120 120	19, 21	ELECTRICAL EQUIPMENT ROOM  AC SWITCHBOARD ROOM
46	A13 TWINBROOK	MEZZANINE	101 101	(Marina a.g.	700 343 344	Parameter State of the State of	
47	Programme to the state of the s		427 2 00.323 G street 5.03 cm	100000000000000000000000000000000000000	10 Care 10 Car	100	
O L	A14 ROCKVILLE		C112	M2	480	8, 10, 12	ELECTRICAL EQUIPMENT ROOM
48	A14 ROCKVILLE A14 ROCKVILLE	PLATFORM MEZZANINE	C112 C112	M2 M1	480 120	8, 10, 12 32	<u> </u>
48 49 50	A14 ROCKVILLE	PLATFORM					ELECTRICAL EQUIPMENT ROOM
49	A14 ROCKVILLE A14 ROCKVILLE	PLATFORM MEZZANINE PLATFORM (TRACK A1)	C112	M1	120	32 24 19	ELECTRICAL EQUIPMENT ROOM  ELECTRICAL EQUIPMENT ROOM  ELECTRICAL ROOM
49 50	A14 ROCKVILLE A14 ROCKVILLE A15 SHADY GROVE A15 SHADY GROVE	PLATFORM MEZZANINE PLATFORM (TRACK A1) PLATFORM (TRACK A2)	C112 C103 C103	M1 M M	120 120 120	32 19 21	ELECTRICAL EQUIPMENT ROOM  ELECTRICAL EQUIPMENT ROOM  ELECTRICAL ROOM  ELECTRICAL ROOM
49 50 51	A14 ROCKVILLE A14 ROCKVILLE A15 SHADY GROVE A15 SHADY GROVE A15 SHADY GROVE	PLATFORM MEZZANINE  PLATFORM (TRACK A1) PLATFORM (TRACK A2) MEZZANINE	C112 C103 C103 C103	M1 M M	120 120 120 120	32 19 21 20	ELECTRICAL EQUIPMENT ROOM  ELECTRICAL EQUIPMENT ROOM  ELECTRICAL ROOM  ELECTRICAL ROOM  ELECTRICAL ROOM
49 50 51 52 53 54	A14 ROCKVILLE A14 ROCKVILLE A15 SHADY GROVE A15 SHADY GROVE A15 SHADY GROVE	PLATFORM MEZZANINE  PLATFORM (TRACK A1) PLATFORM (TRACK A2) MEZZANINE	C112 C103 C103 C103	M1 M M	120 120 120 120	32 19 21 20	ELECTRICAL EQUIPMENT ROOM  ELECTRICAL EQUIPMENT ROOM  ELECTRICAL ROOM  ELECTRICAL ROOM  ELECTRICAL ROOM
49 50 51 52 53 54 55	A14 ROCKVILLE A14 ROCKVILLE A15 SHADY GROVE A15 SHADY GROVE A15 SHADY GROVE A15 SHADY GROVE B01 GALLERY PLACE	PLATFORM MEZZANINE  PLATFORM (TRACK A1) PLATFORM (TRACK A2) MEZZANINE  MEZZANINE EAST (UPPER LEVEL)	C112 C103 C103 C103	M1 M M	120 120 120 120	32 19 21 20	ELECTRICAL EQUIPMENT ROOM  ELECTRICAL EQUIPMENT ROOM  ELECTRICAL ROOM  ELECTRICAL ROOM  ELECTRICAL ROOM
49 50 51 52 53 54 55 58	A14 ROCKVILLE A14 ROCKVILLE A15 SHADY GROVE A15 SHADY GROVE A15 SHADY GROVE	PLATFORM MEZZANINE  PLATFORM (TRACK A1) PLATFORM (TRACK A2) MEZZANINE	C112 C103 C103 C103 C103	M1 M M M	120 120 120 120 120	32 19 21 20 35	ELECTRICAL EQUIPMENT ROOM  ELECTRICAL EQUIPMENT ROOM  ELECTRICAL ROOM  ELECTRICAL ROOM  ELECTRICAL ROOM  ELECTRICAL ROOM
49 50 51 52 53 54 55	A14 ROCKVILLE A14 ROCKVILLE A15 SHADY GROVE A15 SHADY GROVE A15 SHADY GROVE B01 GALLERY PLACE B01 GALLERY PLACE	PLATFORM MEZZANINE  PLATFORM (TRACK A1) PLATFORM (TRACK A2) MEZZANINE  MEZZANINE EAST (UPPER LEVEL) MEZZANINE EAST (LOWER LEVEL)	C112 C103 C103 C103 C103 E206 E206	M1 M M M AFGE AFCW	120 120 120 120 120	32 19 21 20 35 37	ELECTRICAL EQUIPMENT ROOM  ELECTRICAL EQUIPMENT ROOM  ELECTRICAL ROOM  ELECTRICAL ROOM  ELECTRICAL ROOM  ELECTRICAL ROOM  ELECTRICAL ROOM  ELECTRICAL ROOM
49 50 51 52 53 54 55 56 57	A14 ROCKVILLE  A14 ROCKVILLE  A15 SHADY GROVE  A15 SHADY GROVE  A15 SHADY GROVE  B01 GALLERY PLACE  B01 GALLERY PLACE  B01 GALLERY PLACE	PLATFORM MEZZANINE  PLATFORM (TRACK A1) PLATFORM (TRACK A2) MEZZANINE  MEZZANINE EAST (UPPER LEVEL) MEZZANINE EAST (LOWER LEVEL) MEZZANINE WEST PLATFORM (TRACK B1) PLATFORM (TRACK B2)	C112 C103 C103 C103 C103 E206 E206 W106	M1 M M M AFCE AFCW NWPP NWPA NWPA	120 120 120 120 120 120 120 120 480 480	32 19 21 20 35 37 12 1, 3, 5 7, 9, 11	ELECTRICAL EQUIPMENT ROOM  ELECTRICAL EQUIPMENT ROOM  ELECTRICAL ROOM  ELECTRICAL ROOM  ELECTRICAL ROOM  ELECTRICAL ROOM  ELECTRICAL ROOM  MECHANICAL EQUIPMENT ROOM  MECHANICAL EQUIPMENT ROOM  MECHANICAL EQUIPMENT ROOM
49 50 51 52 53 54 55 56 57 58	A14 ROCKVILLE  A14 ROCKVILLE  A15 SHADY GROVE  A15 SHADY GROVE  A15 SHADY GROVE  B01 GALLERY PLACE	PLATFORM MEZZANINE  PLATFORM (TRACK A1) PLATFORM (TRACK A2) MEZZANINE  MEZZANINE  MEZZANINE EAST (UPPER LEVEL) MEZZANINE EAST (LOWER LEVEL) MEZZANINE WEST PLATFORM (TRACK B1)	C112 C103 C103 C103 C103 E206 E206 W106 W106 W106	M1 M M M AFCE AFCW NWPP NWPA NWPA	120 120 120 120 120 120 120 120 480 480	32 19 21 20 35 37 12 1, 3, 5 7, 9, 11	ELECTRICAL EQUIPMENT ROOM  ELECTRICAL EQUIPMENT ROOM  ELECTRICAL ROOM  ELECTRICAL ROOM  ELECTRICAL ROOM  ELECTRICAL ROOM  ELECTRICAL ROOM  MECHANICAL EQUIPMENT ROOM  MECHANICAL EQUIPMENT ROOM
49 50 51 52 53 54 55 56 57 58 59	A14 ROCKVILLE  A14 ROCKVILLE  A15 SHADY GROVE  A15 SHADY GROVE  A15 SHADY GROVE  A15 SHADY GROVE  B01 GALLERY PLACE	PLATFORM MEZZANINE  PLATFORM (TRACK A1) PLATFORM (TRACK A2) MEZZANINE  MEZZANINE  MEZZANINE EAST (UPPER LEVEL) MEZZANINE EAST (LOWER LEVEL) MEZZANINE WEST PLATFORM (TRACK B1) PLATFORM (TRACK B2)	C112 C103 C103 C103 C103 E206 E206 W106 W106 W106	M1 M M M AFCE AFCW NWPP NWPA NWPA AFCE	120 120 120 120 120 120 120 120 480 480	32 19 21 20 35 37 12 1, 3, 5 7, 9, 11	ELECTRICAL EQUIPMENT ROOM  ELECTRICAL EQUIPMENT ROOM  ELECTRICAL ROOM  ELECTRICAL ROOM  ELECTRICAL ROOM  ELECTRICAL ROOM  ELECTRICAL ROOM  MECHANICAL EQUIPMENT ROOM  MECHANICAL EQUIPMENT ROOM  MECHANICAL EQUIPMENT ROOM  MECHANICAL EQUIPMENT ROOM
49 50 51 52 53 54 55 56 57 58 59 60 61 62	A14 ROCKVILLE  A14 ROCKVILLE  A15 SHADY GROVE  A15 SHADY GROVE  A15 SHADY GROVE  A15 SHADY GROVE  B01 GALLERY PLACE	PLATFORM MEZZANINE  PLATFORM (TRACK A1) PLATFORM (TRACK A2) MEZZANINE  MEZZANINE  MEZZANINE EAST (UPPER LEVEL) MEZZANINE EAST (LOWER LEVEL) MEZZANINE WEST PLATFORM (TRACK B1) PLATFORM (TRACK B2)  MEZZANINE EAST MEZZANINE WEST	C112 C103 C103 C103 C103 E206 E206 W106 W108 W108 C103	M1 M M M AFCE AFCW NWPP NWPA NWPA AFCE AFCE AFCW	120 120 120 120 120 120 120 480 480 480	32 19 21 20 35 37 12 1, 3, 5 7, 9, 11	ELECTRICAL EQUIPMENT ROOM  ELECTRICAL EQUIPMENT ROOM  ELECTRICAL ROOM  ELECTRICAL ROOM  ELECTRICAL ROOM  ELECTRICAL ROOM  ELECTRICAL ROOM  MECHANICAL EQUIPMENT ROOM
49 50 51 52 53 54 55 56 57 58 59 60 61 62 63	A14 ROCKVILLE  A14 ROCKVILLE  A15 SHADY GROVE  A15 SHADY GROVE  A15 SHADY GROVE  A15 SHADY GROVE  B01 GALLERY PLACE  B02 JUDICIARY SQUARE  B02 JUDICIARY SQUARE  B02 JUDICIARY SQUARE	PLATFORM MEZZANINE  PLATFORM (TRACK A1) PLATFORM (TRACK A2) MEZZANINE  MEZZANINE  MEZZANINE EAST (UPPER LEVEL) MEZZANINE EAST (LOWER LEVEL) MEZZANINE WEST PLATFORM (TRACK B1) PLATFORM (TRACK B2)  MEZZANINE EAST MEZZANINE WEST PLATFORM (TRACK B1)	C112 C103 C103 C103 C103 E206 E206 W106 W106 W106 204 205 103	M1 M M M M AFCE AFCW NWPP NWPA NWPA AFCE AFCW SWBP	120 120 120 120 120 120 120 480 480 120 120 120	32 19 21 20 35 37 12 1, 3, 5 7, 9, 11	ELECTRICAL EQUIPMENT ROOM  ELECTRICAL EQUIPMENT ROOM  ELECTRICAL ROOM  ELECTRICAL ROOM  ELECTRICAL ROOM  ELECTRICAL ROOM  ELECTRICAL ROOM  MECHANICAL EQUIPMENT ROOM  MECHANICAL EQUIPMENT ROOM  MECHANICAL EQUIPMENT ROOM  MECHANICAL EQUIPMENT ROOM
49 50 51 52 53 54 55 56 57 58 60 61 62 63 64	A14 ROCKVILLE  A14 ROCKVILLE  A15 SHADY GROVE  A15 SHADY GROVE  A15 SHADY GROVE  A15 SHADY GROVE  B01 GALLERY PLACE  B02 JUDICIARY SQUARE  B02 JUDICIARY SQUARE  B02 JUDICIARY SQUARE  B02 JUDICIARY SQUARE	PLATFORM MEZZANINE  PLATFORM (TRACK A1) PLATFORM (TRACK A2) MEZZANINE  MEZZANINE  MEZZANINE EAST (UPPER LEVEL) MEZZANINE EAST (LOWER LEVEL) MEZZANINE WEST PLATFORM (TRACK B1) PLATFORM (TRACK B2)  MEZZANINE EAST MEZZANINE WEST PLATFORM (TRACK B1) PLATFORM (TRACK B1) PLATFORM (TRACK B2)	C112 C103 C103 C103 C103 E206 E206 W106 W108 W108 C103	M1 M M M M AFCE AFCW NWPP NWPA NWPA AFCE AFCW SWBP NWPA	120 120 120 120 120 120 120 480 480 120 120 120 480	32 19 21 20 35 37 12 1, 3, 5 7, 9, 11	ELECTRICAL EQUIPMENT ROOM  ELECTRICAL EQUIPMENT ROOM  ELECTRICAL ROOM  ELECTRICAL ROOM  ELECTRICAL ROOM  ELECTRICAL ROOM  ELECTRICAL ROOM  MECHANICAL EQUIPMENT ROOM
49 50 51 52 53 54 55 56 57 58 59 60 61 62 63 64 65	A14 ROCKVILLE  A14 ROCKVILLE  A15 SHADY GROVE  A15 SHADY GROVE  A15 SHADY GROVE  A15 SHADY GROVE  B01 GALLERY PLACE  B02 JUDICIARY SQUARE  B02 JUDICIARY SQUARE  B02 JUDICIARY SQUARE	PLATFORM MEZZANINE  PLATFORM (TRACK A1) PLATFORM (TRACK A2) MEZZANINE  MEZZANINE  MEZZANINE EAST (UPPER LEVEL) MEZZANINE EAST (LOWER LEVEL) MEZZANINE WEST PLATFORM (TRACK B1) PLATFORM (TRACK B2)  MEZZANINE EAST MEZZANINE WEST PLATFORM (TRACK B1)	C112 C103 C103 C103 C103 E206 E206 W106 W106 W106 C103 C103 C103 C103 C103 C103 C103 C103	M1 M M M M AFCE AFCW NWPP NWPA NWPA AFCE AFCW SWBP	120 120 120 120 120 120 120 480 480 120 120 120	32 19 21 20 35 37 12 1, 3, 5 7, 9, 11 23 23 7, 9, 11 8, 10, 12	ELECTRICAL EQUIPMENT ROOM  ELECTRICAL EQUIPMENT ROOM  ELECTRICAL ROOM  ELECTRICAL ROOM  ELECTRICAL ROOM  ELECTRICAL ROOM  ELECTRICAL ROOM  MECHANICAL EQUIPMENT ROOM
49 50 51 52 53 54 55 56 57 58 60 61 62 63 64	A14 ROCKVILLE  A14 ROCKVILLE  A15 SHADY GROVE  A15 SHADY GROVE  A15 SHADY GROVE  A15 SHADY GROVE  B01 GALLERY PLACE  B02 JUDICIARY SQUARE	PLATFORM MEZZANINE  PLATFORM (TRACK A1) PLATFORM (TRACK A2) MEZZANINE  MEZZANINE  MEZZANINE EAST (UPPER LEVEL) MEZZANINE EAST (LOWER LEVEL) MEZZANINE WEST PLATFORM (TRACK B1) PLATFORM (TRACK B2)  MEZZANINE EAST MEZZANINE WEST PLATFORM (TRACK B1) PLATFORM (TRACK B2)	C112 C103 C103 C103 C103 E206 E206 W106 W106 W106 C103 C103 C103 C103 C103 C103 C103 C103	M1 M M M M AFCE AFCW NWPP NWPA NWPA AFCE AFCW SWBP NWPA	120 120 120 120 120 120 120 480 480 480 120 120 480 480	32 19 21 20 35 37 12 1, 3, 5 7, 9, 11 23 23 23 7, 9, 11 8, 10, 12	ELECTRICAL EQUIPMENT ROOM  ELECTRICAL EQUIPMENT ROOM  ELECTRICAL ROOM  ELECTRICAL ROOM  ELECTRICAL ROOM  ELECTRICAL ROOM  ELECTRICAL ROOM  MECHANICAL EQUIPMENT ROOM  AC SWITCHBOARD ROOM
49 50 51 52 53 54 55 56 57 58 59 60 61 62 63 64 65 66	A14 ROCKVILLE  A14 ROCKVILLE  A15 SHADY GROVE  A15 SHADY GROVE  A15 SHADY GROVE  A15 SHADY GROVE  B01 GALLERY PLACE  B02 JUDICIARY SQUARE  B03 UNION STATION	PLATFORM MEZZANINE  PLATFORM (TRACK A1) PLATFORM (TRACK A2) MEZZANINE  MEZZANINE  MEZZANINE EAST (UPPER LEVEL) MEZZANINE EAST (LOWER LEVEL) MEZZANINE WEST PLATFORM (TRACK B1) PLATFORM (TRACK B2)  MEZZANINE EAST MEZZANINE WEST PLATFORM (TRACK B1) PLATFORM (TRACK B2)  PLATFORM (TRACK B2)	C112 C103 C103 C103 C103 E206 E206 W106 W106 W106 C103 C103 C103 C103 C103 C103 C103 C103	M1 M M M M AFCE AFCW NWPP NWPA NWPA SPO1	120 120 120 120 120 120 120 480 480 480 480 480 480	32 19 21 20 35 37 12 1, 3, 5 7, 9, 11 23 23 23 7, 9, 11 8, 10, 12	ELECTRICAL EQUIPMENT ROOM  ELECTRICAL EQUIPMENT ROOM  ELECTRICAL ROOM  ELECTRICAL ROOM  ELECTRICAL ROOM  ELECTRICAL ROOM  ELECTRICAL ROOM  MECHANICAL EQUIPMENT ROOM  AC SWITCHBOARD ROOM  AC SWITCHBOARD ROOM  MECH EQUIP (COMM, PART'S OFFICE)
50 51 52 53 54 55 56 57 58 60 61 62 63 64 65 66 67	A14 ROCKVILLE  A15 SHADY GROVE  B01 GALLERY PLACE  B02 JUDICIARY SQUARE  B03 JUDICIARY SQUARE	PLATFORM MEZZANINE  PLATFORM (TRACK A1) PLATFORM (TRACK A2) MEZZANINE  MEZZANINE  MEZZANINE EAST (UPPER LEVEL) MEZZANINE EAST (LOWER LEVEL) MEZZANINE WEST PLATFORM (TRACK B1) PLATFORM (TRACK B2)  MEZZANINE WEST MEZZANINE WEST PLATFORM (TRACK B1) PLATFORM (TRACK B1) PLATFORM (TRACK B2)  PLATFORM (TRACK B2)	C112 C103 C103 C103 C103 E206 E206 W106 W108 W108 C103 C103 C103 C103 C103 C103 C103 C103	M1 M M M M AFCE AFCW NWPP NWPA NWPA SP01 SP01 SP01 NMF-2 F-2	120 120 120 120 120 120 120 120 120 120	32 19 21 20 35 37 12 1, 3, 5 7, 9, 11 23 23 23 7, 9, 11 8, 10, 12	ELECTRICAL EQUIPMENT ROOM  ELECTRICAL EQUIPMENT ROOM  ELECTRICAL ROOM  ELECTRICAL ROOM  ELECTRICAL ROOM  ELECTRICAL ROOM  ELECTRICAL ROOM  MECHANICAL EQUIPMENT ROOM  AC SWITCHBOARD ROOM  AC SWITCHBOARD ROOM  MECH EQUIP (COMM, PART'S OFFICE)  WALKWAY EQUIPMENT ROOI
50 51 52 53 54 55 56 57 58 60 61 62 63 64 65 66 67	A14 ROCKVILLE  A14 ROCKVILLE  A15 SHADY GROVE  B01 GALLERY PLACE  B01 GALLERY PLACE  B01 GALLERY PLACE  B01 GALLERY PLACE  B02 JUDICIARY SQUARE  B03 JUDICIARY SQUARE	PLATFORM MEZZANINE  PLATFORM (TRACK A1) PLATFORM (TRACK A2) MEZZANINE  MEZZANINE  MEZZANINE EAST (UPPER LEVEL) MEZZANINE EAST (LOWER LEVEL) MEZZANINE WEST PLATFORM (TRACK B1) PLATFORM (TRACK B2)  MEZZANINE WEST PLATFORM (TRACK B1) PLATFORM (TRACK B1) PLATFORM (TRACK B2)  PLATFORM (TRACK B2)  PLATFORM (TRACK B2)	C112 C103 C103 C103 C103 E206 E206 W106 W106 W106  W108 103 113 109 109 214 C200	M1  M M M M M M AFCE AFCW NWPP NWPA NWPA SPO1 SPO1 SPO1 NMF-2 F-2	120 120 120 120 120 120 120 120 120 120	32 19 21 20 35 37 12 1, 3, 5 7, 9, 11 23 23 23 7, 9, 11 8, 10, 12 1 9 31 43	ELECTRICAL EQUIPMENT ROOM  ELECTRICAL EQUIPMENT ROOM  ELECTRICAL ROOM  ELECTRICAL ROOM  ELECTRICAL ROOM  ELECTRICAL ROOM  ELECTRICAL ROOM  MECHANICAL EQUIPMENT ROOM  AC SWITCHBOARD ROOM  MECH EQUIP (COMM, PART'S OFFICE)  WALKWAY EQUIPMENT ROOM
50 51 52 53 54 55 56 57 58 60 61 62 63 64 65 66 67 68 89 70 71	A14 ROCKVILLE  A14 ROCKVILLE  A15 SHADY GROVE  B01 GALLERY PLACE  B02 JUDICIARY SQUARE  B03 UNION STATION	PLATFORM MEZZANINE  PLATFORM (TRACK A1) PLATFORM (TRACK A2) MEZZANINE  MEZZANINE  MEZZANINE EAST (UPPER LEVEL) MEZZANINE EAST (LOWER LEVEL) MEZZANINE WEST PLATFORM (TRACK B1) PLATFORM (TRACK B2)  MEZZANINE EAST MEZZANINE WEST PLATFORM (TRACK B1) PLATFORM (TRACK B2)  PLATFORM (TDI SIGN) MEZZANINE NORTH MEZZANINE CENTER	C112  C103  C103  C103  C103  E206  E206  W106  W106  W106  W106  103  113  109  109  214  C200	M1 M M M M M AFCE AFCW NWPP NWPA NWPA SP01 SP01 SP01 NMF-2 F-2 PO	120 120 120 120 120 120 120 120 120 120	32 19 21 20 35 37 12 1, 3, 5 7, 9, 11 23 23 23 7, 9, 11 8, 10, 12 1 9 31 43 37, 39, 41	ELECTRICAL EQUIPMENT ROOM  ELECTRICAL EQUIPMENT ROOM  ELECTRICAL ROOM  ELECTRICAL ROOM  ELECTRICAL ROOM  ELECTRICAL ROOM  ELECTRICAL ROOM  MECHANICAL EQUIPMENT ROOM  AC SWITCHBOARD ROOM  MECH EQUIP (COMM, PART'S OFFICE)  WALKWAY EQUIPMENT ROOM  AC SWITCHBOARD ROOM
50 51 52 53 54 55 58 59 60 61 62 63 64 65 66 67 68 69 70 71 72	A14 ROCKVILLE  A14 ROCKVILLE  A15 SHADY GROVE  B01 GALLERY PLACE  B02 JUDICIARY SQUARE  B02 JUDICIARY SQUARE  B02 JUDICIARY SQUARE  B02 JUDICIARY SQUARE  B03 JUDICIARY SQUARE  B04 JUDICIARY SQUARE  B05 JUDICIARY SQUARE  B06 JUDICIARY SQUARE  B07 JUDICIARY SQUARE  B08 JUDICIARY SQUARE  B09 JUDICIARY SQUARE	PLATFORM MEZZANINE  PLATFORM (TRACK A1) PLATFORM (TRACK A2) MEZZANINE  MEZZANINE  MEZZANINE EAST (UPPER LEVEL) MEZZANINE EAST (LOWER LEVEL) MEZZANINE WEST PLATFORM (TRACK B1) PLATFORM (TRACK B2)  MEZZANINE EAST MEZZANINE WEST PLATFORM (TRACK B1) PLATFORM (TRACK B1) PLATFORM (TRACK B2)  PLATFORM (TRACK B2)  PLATFORM (TRACK B2)  PLATFORM (TRACK B2)  PLATFORM (TDI SIGN) MEZZANINE NORTH MEZZANINE CENTER  PLATFORM MEZZANINE	C112  C103  C103  C103  C103  E206  E206  W106  W106  W106  W106  204  205  103  113  109  109  214  C200	M1  M M M M M M AFCE AFCW NWPP NWPA NWPA SP01 SP01 SP01 NMF-2 F-2 P0 PP	120 120 120 120 120 120 120 120 120 120	32 19 21 20 35 37 12 1, 3, 5 7, 9, 11 8, 10, 12 1 9 31 43 37, 39, 41 33	ELECTRICAL EQUIPMENT ROOM  ELECTRICAL EQUIPMENT ROOM  ELECTRICAL ROOM  ELECTRICAL ROOM  ELECTRICAL ROOM  ELECTRICAL ROOM  ELECTRICAL ROOM  MECHANICAL EQUIPMENT ROOM  AC SWITCHBOARD ROOM  MECH EQUIP (COMM, PART'S OFFICE)  WALKWAY EQUIPMENT ROOM  AC SWITCHBOARD ROOM  AC SWITCHBOARD ROOM  AC SWITCHBOARD ROOM  AC SWITCHBOARD ROOM
50 51 52 53 54 55 58 59 60 61 62 63 64 65 66 67 68 89 70 71 72 73	A14 ROCKVILLE  A14 ROCKVILLE  A15 SHADY GROVE  B01 GALLERY PLACE  B02 JUDICIARY SQUARE  B03 JUDICIARY SQUARE  B04 JUDICIARY SQUARE  B05 JUDICIARY SQUARE  B06 JUDICIARY SQUARE  B07 JUDICIARY SQUARE  B08 JUDICIARY SQUARE  B09 JUDICIARY SQUARE	PLATFORM MEZZANINE  PLATFORM (TRACK A1) PLATFORM (TRACK A2) MEZZANINE  MEZZANINE  MEZZANINE EAST (UPPER LEVEL) MEZZANINE EAST (LOWER LEVEL) MEZZANINE WEST PLATFORM (TRACK B1) PLATFORM (TRACK B2)  MEZZANINE EAST MEZZANINE WEST PLATFORM (TRACK B1) PLATFORM (TRACK B1) PLATFORM (TRACK B2)  PLATFORM (TRACK B2)  PLATFORM (TRACK B2)  PLATFORM (TRACK B2)  PLATFORM (TSI SIGN) MEZZANINE NORTH MEZZANINE CENTER  PLATFORM MEZZANINE	C112 C103 C103 C103 C103 C103 E206 E206 W106 W108 W108 W108  103 113 109 109 214 C200	M1  M M M M M AFCE AFCW NWPP NWPA NWPA SP01 SP01 SP01 NMF-2 F-2 P0 PP	120 120 120 120 120 120 120 120 120 120	32 19 21 20 35 37 12 1, 3, 5 7, 9, 11 8, 10, 12 1 9 31 43 37, 39, 41 33	ELECTRICAL EQUIPMENT ROOM  ELECTRICAL EQUIPMENT ROOM  ELECTRICAL ROOM  ELECTRICAL ROOM  ELECTRICAL ROOM  ELECTRICAL ROOM  ELECTRICAL ROOM  MECHANICAL EQUIPMENT ROOM  AC SWITCHBOARD ROOM  MECH EQUIP (COMM, PART'S OFFICE)  WALKWAY EQUIPMENT ROOM  AC SWITCHBOARD ROOM  AC SWITCHBOARD ROOM  AC SWITCHBOARD ROOM
50 51 52 53 54 55 56 57 58 59 60 61 62 63 64 65 66 67 68 89 70 71 72 73	A14 ROCKVILLE  A14 ROCKVILLE  A15 SHADY GROVE  B01 GALLERY PLACE  B02 JUDICIARY SQUARE  B03 JUDICIARY SQUARE  B04 JUDICIARY SQUARE  B05 JUDICIARY SQUARE  B06 UNION STATION  B07 UNION STATION  B08 UNION STATION  B08 UNION STATION  B09 UNION STATION	PLATFORM MEZZANINE  PLATFORM (TRACK A1) PLATFORM (TRACK A2) MEZZANINE  MEZZANINE  MEZZANINE EAST (UPPER LEVEL) MEZZANINE EAST (LOWER LEVEL) MEZZANINE WEST PLATFORM (TRACK B1) PLATFORM (TRACK B2)  MEZZANINE EAST MEZZANINE WEST PLATFORM (TRACK B1) PLATFORM (TRACK B1) PLATFORM (TRACK B2)  PLATFORM (TDI SIGN) MEZZANINE NORTH MEZZANINE CENTER  PLATFORM MEZZANINE PLATFORM	C112 C103 C103 C103 C103 C103 E206 E206 W106 W108 W108 W108 U108 U109 109 109 214 C200 101 101 C106	M1  M M M M M M AFCE AFCW NWPP NWPA NWPA SP01 SP01 SP01 NMF-2 F-2 P0 PP	120 120 120 120 120 120 120 120 120 120	32 19 21 20 35 37 12 1, 3, 5 7, 9, 11 23 23 23 7, 9, 11 8, 10, 12 1 9 31 43 37, 39, 41 33	ELECTRICAL EQUIPMENT ROOM  ELECTRICAL EQUIPMENT ROOM  ELECTRICAL ROOM  ELECTRICAL ROOM  ELECTRICAL ROOM  ELECTRICAL ROOM  ELECTRICAL ROOM  MECHANICAL EQUIPMENT ROOM  AC SWITCHBOARD ROOM  AC SWITCHBOARD ROOM  MECH EQUIP (COMM, PART'S OFFICE)  WALKWAY EQUIPMENT ROOM  AC SWITCHBOARD ROOM  AC SWITCHBOARD ROOM  AC SWITCHBOARD ROOM  AC SWITCHBOARD ROOM
50 51 52 53 54 55 56 57 58 59 60 61 62 63 64 65 66 67 68 69 70 71 72 73 74 75	A14 ROCKVILLE  A15 SHADY GROVE  B01 GALLERY PLACE  B02 JUDICIARY SQUARE  B02 JUDICIARY SQUARE  B02 JUDICIARY SQUARE  B02 JUDICIARY SQUARE  B03 UNION STATION  B03 UNION STATION  B03 UNION STATION  B04 RHODE ISLAND  B05 BROOKLAND	PLATFORM MEZZANINE  PLATFORM (TRACK A1) PLATFORM (TRACK A2) MEZZANINE  MEZZANINE  MEZZANINE EAST (UPPER LEVEL) MEZZANINE EAST (LOWER LEVEL) MEZZANINE WEST PLATFORM (TRACK B1) PLATFORM (TRACK B2)  MEZZANINE EAST MEZZANINE WEST PLATFORM (TRACK B1) PLATFORM (TRACK B1) PLATFORM (TRACK B2)  PLATFORM (TRACK B2)  PLATFORM (TRACK B2)  PLATFORM (TRACK B2)  PLATFORM (TSI SIGN) MEZZANINE NORTH MEZZANINE CENTER  PLATFORM MEZZANINE  PLATFORM MEZZANINE	C112 C103 C103 C103 C103 C103 E206 E206 W106 W108 W108 W108  103 113 109 109 214 C200	M1 M M M M M AFCE AFCW NWPP NWPA NWPA SPO1 SPO1 SPO1 SPO1 NMF-2 F-2 PO PP	120 120 120 120 120 120 120 120 120 120	32 19 21 20 35 37 12 1, 3, 5 7, 9, 11 8, 10, 12 1 9 31 43 37, 39, 41 33 7, 9, 11	ELECTRICAL EQUIPMENT ROOM  ELECTRICAL EQUIPMENT ROOM  ELECTRICAL ROOM  ELECTRICAL ROOM  ELECTRICAL ROOM  ELECTRICAL ROOM  ELECTRICAL ROOM  MECHANICAL EQUIPMENT ROOM  AC SWITCHBOARD ROOM  AC SWITCHBOARD ROOM  MECH EQUIP (COMM, PART'S OFFICE)  WALKWAY EQUIPMENT ROOM  AC SWITCHBOARD ROOM
50 51 52 53 54 55 58 59 60 61 62 63 64 65 68 67 68 89 70 71 72 73 74 75	A14 ROCKVILLE  A14 ROCKVILLE  A15 SHADY GROVE  B01 GALLERY PLACE  B02 JUDICIARY SQUARE  B03 JUDICIARY SQUARE  B04 JUDICIARY SQUARE  B05 JUDICIARY SQUARE  B06 UNION STATION  B07 UNION STATION  B08 UNION STATION  B08 UNION STATION  B09 UNION STATION	PLATFORM MEZZANINE  PLATFORM (TRACK A1) PLATFORM (TRACK A2) MEZZANINE  MEZZANINE  MEZZANINE EAST (UPPER LEVEL) MEZZANINE EAST (LOWER LEVEL) MEZZANINE WEST PLATFORM (TRACK B1) PLATFORM (TRACK B2)  MEZZANINE EAST MEZZANINE WEST PLATFORM (TRACK B1) PLATFORM (TRACK B1) PLATFORM (TRACK B2)  PLATFORM (TDI SIGN) MEZZANINE NORTH MEZZANINE CENTER  PLATFORM MEZZANINE PLATFORM	C112 C103 C103 C103 C103 C103 E206 E206 W106 W108 W108 W108 U108 U109 109 109 214 C200 101 101 C106	M1  M M M M M AFCE AFCW NWPP NWPA NWPA AFCE AFCW SWBP NWPA SPO1 SPO1 SPO1 NMF-2 F-2 PO PP LP-MH LP-F	120 120 120 120 120 120 120 120 120 120	32 19 21 20 35 37 12 1, 3, 5 7, 9, 11 8, 10, 12 1 9 31 43 37, 39, 41 33 7, 9, 11 28	ELECTRICAL EQUIPMENT ROOM  ELECTRICAL EQUIPMENT ROOM  ELECTRICAL ROOM  ELECTRICAL ROOM  ELECTRICAL ROOM  ELECTRICAL ROOM  ELECTRICAL ROOM  MECHANICAL EQUIPMENT ROOM  AC SWITCHBOARD ROOM  MECH EQUIP (COMM, PART'S OFFICE)  WALKWAY EQUIPMENT ROOM  AC SWITCHBOARD ROOM  AC SWITCHBOARD ROOM  AC SWITCHBOARD ROOM  AC SWITCHBOARD ROOM  ELECTRICAL EQUIPMENT ROOM  ELECTRICAL EQUIPMENT ROOM  ELECTRICAL EQUIPMENT ROOM
50 51 52 53 54 55 58 59 60 61 62 63 64 65 66 67 68 69 70 71 72 73 74 75 76	A14 ROCKVILLE  A15 SHADY GROVE  B01 GALLERY PLACE  B01 GALLERY PLACE  B01 GALLERY PLACE  B01 GALLERY PLACE  B02 JUDICIARY SQUARE  B03 UNION STATION  B03 UNION STATION  B03 UNION STATION  B04 RHODE ISLAND  B05 BROOKLAND  B05 BROOKLAND	PLATFORM MEZZANINE  PLATFORM (TRACK A1) PLATFORM (TRACK A2) MEZZANINE  MEZZANINE  MEZZANINE EAST (UPPER LEVEL) MEZZANINE EAST (LOWER LEVEL) MEZZANINE WEST PLATFORM (TRACK B1) PLATFORM (TRACK B2)  MEZZANINE EAST MEZZANINE WEST PLATFORM (TRACK B1) PLATFORM (TRACK B1) PLATFORM (TRACK B2)  PLATFORM (TRACK B2)  PLATFORM (TRACK B2)  PLATFORM (TSI SIGN) MEZZANINE NORTH MEZZANINE CENTER  PLATFORM MEZZANINE  PLATFORM MEZZANINE	C112  C103  C103  C103  C103  E206  E206  W106  W106  W106  W106  204  205  103  113  109  109  214  C200  101  101  101  C106  C106	M1 M M M M M M M AFCE AFCW NWPP NWPA NWPA SP01 SP01 SP01 SP01 NMF-2 F-2 P0 PP LP-MH LP-F	120 120 120 120 120 120 120 120 120 120	32 19 21 20 35 37 12 1, 3, 5 7, 9, 11 8, 10, 12 1 9 31 43 37, 39, 41 33 7, 9, 11 28	ELECTRICAL EQUIPMENT ROOM  ELECTRICAL EQUIPMENT ROOM  ELECTRICAL ROOM  ELECTRICAL ROOM  ELECTRICAL ROOM  ELECTRICAL ROOM  ELECTRICAL ROOM  MECHANICAL EQUIPMENT ROOM  AC SWITCHBOARD ROOM  MECH EQUIP (COMM, PART'S OFFICE)  WALKWAY EQUIPMENT ROOM  AC SWITCHBOARD ROOM  AC SWITCHBOARD ROOM  AC SWITCHBOARD ROOM  ELECTRICAL EQUIPMENT ROOM  ELECTRICAL EQUIPMENT ROOM
50 51 52 53 54 55 58 59 60 61 62 63 64 65 68 67 68 89 70 71 72 73 74 75	A14 ROCKVILLE  A15 SHADY GROVE  B01 GALLERY PLACE  B02 JUDICIARY SQUARE  B03 UNION STATION  B03 UNION STATION  B03 UNION STATION  B04 RHODE ISLAND  B05 BROOKLAND  B05 BROOKLAND  B06 FORT TOTTEN	PLATFORM MEZZANINE  PLATFORM (TRACK A1) PLATFORM (TRACK A2) MEZZANINE  MEZZANINE  MEZZANINE EAST (UPPER LEVEL) MEZZANINE EAST (LOWER LEVEL) MEZZANINE WEST PLATFORM (TRACK B1) PLATFORM (TRACK B2)  MEZZANINE EAST MEZZANINE WEST PLATFORM (TRACK B1) PLATFORM (TRACK B1) PLATFORM (TRACK B2)  PLATFORM (TRACK B2)  PLATFORM (TOI SIGN) MEZZANINE NORTH MEZZANINE CENTER  PLATFORM MEZZANINE  PLATFORM MEZZANINE  PLATFORM MEZZANINE  PLATFORM MEZZANINE	C112 C103 C103 C103 C103 C103 E206 E206 W106 W106 W106 W108 204 205 103 113 109 109 214 C200 101 101 101 C106 C106 C100	M1  M M M M M AFCE AFCW NWPP NWPA NWPA NWPA SPO1 SPO1 SPO1 SPO1 PP LP-MH LP-F LP-FF LP-FF	120 120 120 120 120 120 120 120 120 120	32 19 21 20 35 37 12 1, 3, 5 7, 9, 11 8, 10, 12 1 9 31 43 37, 39, 41 33 7, 9, 11 28	ELECTRICAL EQUIPMENT ROOM  ELECTRICAL EQUIPMENT ROOM  ELECTRICAL ROOM  ELECTRICAL ROOM  ELECTRICAL ROOM  ELECTRICAL ROOM  ELECTRICAL ROOM  ELECTRICAL ROOM  MECHANICAL EQUIPMENT ROOM  AC SWITCHBOARD ROOM  ELECTRICAL EQUIPMENT ROOM
50 51 52 53 54 55 58 59 60 61 62 63 64 65 66 67 68 89 70 71 72 73 74 75 76	A14 ROCKVILLE  A15 SHADY GROVE  B01 GALLERY PLACE  B02 JUDICIARY SQUARE  B03 JUDICIARY SQUARE  B03 JUDICIARY SQUARE  B04 JUDICIARY SQUARE  B05 JUDICIARY SQUARE  B04 JUDICIARY SQUARE  B05 JUDICIARY SQUARE  B06 FORT TOTTEN  B06 FORT TOTTEN  B06 FORT TOTTEN	PLATFORM MEZZANINE  PLATFORM (TRACK A1) PLATFORM (TRACK A2) MEZZANINE  MEZZANINE  MEZZANINE EAST (UPPER LEVEL) MEZZANINE EAST (LOWER LEVEL) MEZZANINE WEST PLATFORM (TRACK B1) PLATFORM (TRACK B2)  MEZZANINE EAST MEZZANINE WEST PLATFORM (TRACK B1) PLATFORM (TRACK B2)  PLATFORM (TRACK B2)  PLATFORM (TRACK B2)  PLATFORM (TSI SIGN) MEZZANINE NORTH MEZZANINE CENTER  PLATFORM MEZZANINE  PLATFORM MEZZANINE  PLATFORM MEZZANINE  PLATFORM MEZZANINE  PLATFORM MEZZANINE	C112 C103 C103 C103 C103 C103 E206 E206 W106 W106 W106 W106  204 205 103 113 109 109 214 C200 101 101 C106 C106 C100	M1  M M M M M AFCE AFCW NWPP NWPA NWPA NWPA SPO1 SPO1 SPO1 SPO1 PP LP-MH LP-F LP-FF LP-FF	120 120 120 120 120 120 120 120 120 120	32 19 21 20 35 37 12 1, 3, 5 7, 9, 11 8, 10, 12 1 9 31 43 37, 39, 41 33 7, 9, 11 28	ELECTRICAL EQUIPMENT ROOM  ELECTRICAL ROOM  ELECTRICAL ROOM  ELECTRICAL ROOM  ELECTRICAL ROOM  ELECTRICAL ROOM  ELECTRICAL ROOM  MECHANICAL EQUIPMENT ROOM  AC SWITCHBOARD ROOM  MECH EQUIP (COMM, PART'S OFFICE)  WALKWAY EQUIPMENT ROOM  AC SWITCHBOARD ROOM  AC SWITCHBOARD ROOM  ELECTRICAL EQUIPMENT ROOM
50 51 52 53 54 55 56 57 58 60 61 62 63 64 65 68 69 70 71 72 73 74 75 76 77 78	A14 ROCKVILLE  A15 SHADY GROVE  B01 GALLERY PLACE  B02 JUDICIARY SQUARE  B02 JUDICIARY SQUARE  B02 JUDICIARY SQUARE  B02 JUDICIARY SQUARE  B03 JUDICIARY SQUARE  B04 JUDICIARY SQUARE  B05 JUDICIARY SQUARE  B06 FORT TOTTEN  B06 FORT TOTTEN  B06 FORT TOTTEN  B06 FORT TOTTEN	PLATFORM MEZZANINE  PLATFORM (TRACK A1) PLATFORM (TRACK A2) MEZZANINE  MEZZANINE  MEZZANINE EAST (UPPER LEVEL) MEZZANINE EAST (LOWER LEVEL) MEZZANINE WEST PLATFORM (TRACK B1) PLATFORM (TRACK B2)  MEZZANINE EAST MEZZANINE WEST PLATFORM (TRACK B1) PLATFORM (TRACK B2)  PLATFORM (TRACK B2)  PLATFORM (TOI SIGN) PLATFORM (TSI SIGN) MEZZANINE NORTH MEZZANINE CENTER  PLATFORM MEZZANINE  PLATFORM MEZZANINE  PLATFORM MEZZANINE  PLATFORM MEZZANINE  PLATFORM MEZZANINE	C112 C103 C103 C103 C103 C103 E206 E206 W106 W108 W108 W108 W109 204 205 103 113 109 109 214 C200 101 101 C106 C106 C100 C100 C100	M1  M M M M M M AFCE AFCW NWPP NWPA NWPA SPO1 SPO1 SPO1 NMF-2 F-2 PO PP LP-MH LP-F LP-FF LP-FF LP-FF LP-FF	120 120 120 120 120 120 120 120 120 120	32 19 21 20 35 37 12 1, 3, 5 7, 9, 11 8, 10, 12 1 9 31 43 37, 39, 41 33 7, 9, 11 28	ELECTRICAL EQUIPMENT ROOM  ELECTRICAL ROOM  MECHANICAL EQUIPMENT ROOM  AC SWITCHBOARD ROOM  AC SWITCHBOARD ROOM  AC SWITCHBOARD ROOM  AC SWITCHBOARD ROOM  ELECTRICAL EQUIPMENT ROOM
50 51 52 53 54 55 56 57 58 60 61 62 63 64 65 66 67 68 89 70 71 72 73 74 75 76 77 88 89	A14 ROCKVILLE  A15 SHADY GROVE  B01 GALLERY PLACE  B01 GALLERY PLACE  B01 GALLERY PLACE  B01 GALLERY PLACE  B02 JUDICIARY SQUARE  B03 UNION STATION  B03 UNION STATION  B03 UNION STATION  B04 RHODE ISLAND  B05 BROOKLAND  B05 BROOKLAND  B06 FORT TOTTEN  B06 FORT TOTTEN  B06 FORT TOTTEN  B07 TAKOMA  B07 TAKOMA	PLATFORM MEZZANINE  PLATFORM (TRACK A1) PLATFORM (TRACK A2) MEZZANINE  MEZZANINE EAST (UPPER LEVEL) MEZZANINE EAST (LOWER LEVEL) MEZZANINE WEST PLATFORM (TRACK B1) PLATFORM (TRACK B2)  MEZZANINE EAST MEZZANINE WEST PLATFORM (TRACK B1) PLATFORM (TRACK B2)  PLATFORM (TRACK B2)  PLATFORM (TOI SIGN) PLATFORM (TSI SIGN) MEZZANINE NORTH MEZZANINE CENTER  PLATFORM MEZZANINE  PLATFORM MEZZANINE  PLATFORM MEZZANINE  PLATFORM (TRACK B1) PLATFORM (TRACK B2) MEZZANINE  PLATFORM (TRACK B2) MEZZANINE	C112 C103 C103 C103 C103 C103 C103 E206 E206 W106 W106 W106 W106  204 205 103 113 109 109 214 C200 101 101 101 C106 C106 C100 C100 C100	M1 M M M M M M AFCE AFCW NWPP NWPA NWPA AFCE AFCW SWBP NWPA SP01 SP01 SP01 NMF-2 F-2 PO PP LP-MH LP-F LP-FF LP-FF LP-FF LP-FF	120 120 120 120 120 120 120 120 120 120	32 19 21 20 35 37 12 1, 3, 5 7, 9, 11  23 23 7, 9, 11 8, 10, 12  1 9 31 43  37, 39, 41 33  37, 9, 11 28  4 6 8	ELECTRICAL EQUIPMENT ROOM  ELECTRICAL ROOM  MECHANICAL EQUIPMENT ROOM  AC SWITCHBOARD ROOM  AC SWITCHBOARD ROOM  MECH EQUIP (COMM, PART'S OFFICE)  WALKWAY EQUIPMENT ROOM  ELECTRICAL EQUIPMENT ROOM  WALKWAY EQUIP ROOM  WALKWAY EQUIP ROOM  WALKWAY EQUIP ROOM
50 51 52 53 54 55 58 59 60 61 62 63 64 65 66 67 68 69 70 71 72 73 74 75 76 77 78 80 81 82 83	A14 ROCKVILLE  A15 SHADY GROVE  B01 GALLERY PLACE  B02 JUDICIARY SQUARE  B02 JUDICIARY SQUARE  B02 JUDICIARY SQUARE  B02 JUDICIARY SQUARE  B03 UNION STATION  B03 UNION STATION  B03 UNION STATION  B04 RHODE ISLAND  B05 BROOKLAND  B05 BROOKLAND  B06 FORT TOTTEN  B06 FORT TOTTEN  B06 FORT TOTTEN  B07 TAKOMA  B07 TAKOMA	PLATFORM MEZZANINE  PLATFORM (TRACK A1) PLATFORM (TRACK A2) MEZZANINE  MEZZANINE EAST (UPPER LEVEL) MEZZANINE EAST (LOWER LEVEL) MEZZANINE WEST PLATFORM (TRACK B1) PLATFORM (TRACK B2)  MEZZANINE EAST MEZZANINE WEST PLATFORM (TRACK B1) PLATFORM (TRACK B2)  PLATFORM (TRACK B2)  PLATFORM (TSI SIGN) MEZZANINE NORTH MEZZANINE CENTER  PLATFORM MEZZANINE  PLATFORM MEZZANINE  PLATFORM MEZZANINE  PLATFORM MEZZANINE  PLATFORM MEZZANINE  PLATFORM MEZZANINE  PLATFORM (TRACK B1) PLATFORM (TRACK B2) MEZZANINE	C112 C103 C103 C103 C103 C103 E206 E206 W106 W106 W106 W106 W108 U109 109 214 C200 101 101 C106 C100 C100 C100 C100 C100	M1 M M M M M AFCE AFCW NWPP NWPA NWPA NWPA SPO1 SPO1 SPO1 SPO1 PP LP-MH LP-F LP-FF LP-FF LP-FF LP-FF LP-FF	120 120 120 120 120 120 120 120 120 120	32 19 21 20 35 37 12 1, 3, 5 7, 9, 11 23 23 23 7, 9, 11 8, 10, 12 1 9 31 43 37, 39, 41 33 7, 9, 11 28 4 6 8	ELECTRICAL EQUIPMENT ROOM  ELECTRICAL ROOM  ELECTRICAL ROOM  ELECTRICAL ROOM  ELECTRICAL ROOM  ELECTRICAL ROOM  ELECTRICAL ROOM  MECHANICAL EQUIPMENT ROOM  AC SWITCHBOARD ROOM  ELECTRICAL EQUIPMENT ROOM  WALKWAY EQUIP ROOM
50 51 52 53 54 55 58 59 60 61 62 63 64 65 66 67 68 89 70 71 72 73 74 75 76 77 78 80 81 82 83 84	A14 ROCKVILLE  A15 SHADY GROVE  B01 GALLERY PLACE  B02 JUDICIARY SQUARE  B02 JUDICIARY SQUARE  B02 JUDICIARY SQUARE  B02 JUDICIARY SQUARE  B03 UNION STATION  B03 UNION STATION  B03 UNION STATION  B04 RHODE ISLAND  B05 BROOKLAND  B06 FORT TOTTEN  B06 FORT TOTTEN  B06 FORT TOTTEN  B07 TAKOMA  B07 TAKOMA  B08 SILVER SPRING	PLATFORM MEZZANINE  PLATFORM (TRACK A1) PLATFORM (TRACK A2) MEZZANINE  MEZZANINE  MEZZANINE EAST (UPPER LEVEL) MEZZANINE EAST (LOWER LEVEL) MEZZANINE WEST PLATFORM (TRACK B1) PLATFORM (TRACK B2)  MEZZANINE EAST MEZZANINE WEST PLATFORM (TRACK B1) PLATFORM (TRACK B2)  PLATFORM (TRACK B2)  PLATFORM (TSI SIGN) MEZZANINE NORTH MEZZANINE CENTER  PLATFORM MEZZANINE  PLATFORM MEZZANINE  PLATFORM MEZZANINE  PLATFORM (TRACK B1) PLATFORM (TRACK B2)  MEZZANINE  PLATFORM (TRACK B1) PLATFORM (TRACK B2) MEZZANINE	C112 C103 C103 C103 C103 C103 E206 E206 W106 W108 W108 W108 W108  204 205 103 113 109 109 214 C200 101 101 C108 C100 C100 C100 C100 C100	M1 M M M M M AFCE AFCW NWPP NWPA NWPA NWPA SPO1 SPO1 SPO1 NMF-2 F-2 PO PP LP-MH LP-F LP-FF LP-FF LP-FF LP-FF LP-FF LP-FF LP-FF LP-FF	120 120 120 120 120 120 120 120 120 120	32 19 21 20 35 37 12 1, 3, 5 7, 9, 11 23 23 23 7, 9, 11 8, 10, 12 1 9 31 43 37, 39, 41 33 7, 9, 11 28 4 6 8 7, 9, 11 24 22	ELECTRICAL EQUIPMENT ROOM  ELECTRICAL EQUIPMENT ROOM  ELECTRICAL ROOM  ELECTRICAL ROOM  ELECTRICAL ROOM  ELECTRICAL ROOM  ELECTRICAL ROOM  MECHANICAL EQUIPMENT ROOM  AC SWITCHBOARD ROOM  AC SWITCHBOARD ROOM  MECH EQUIP (COMM, PART'S OFFICE)  WALKWAY EQUIPMENT ROOM  ELECTRICAL EQUIPMENT ROOM  WALKWAY EQUIP ROOM  WALKWAY EQUIP ROOM  WALKWAY EQUIP ROOM  ELECTRICAL EQUIPMENT ROOM
50 51 52 53 54 55 58 59 60 61 62 63 64 65 66 67 68 69 70 71 72 73 74 75 76 77 78 80 81 82 83	A14 ROCKVILLE  A15 SHADY GROVE  B01 GALLERY PLACE  B02 JUDICIARY SQUARE  B03 UNION STATION  B03 UNION STATION  B03 UNION STATION  B04 RHODE ISLAND  B05 BROOKLAND  B06 FORT TOTTEN  B06 FORT TOTTEN  B06 FORT TOTTEN  B07 TAKOMA  B07 TAKOMA  B08 SILVER SPRING  B08 SILVER SPRING  B08 SILVER SPRING	PLATFORM MEZZANINE  PLATFORM (TRACK A1) PLATFORM (TRACK A2) MEZZANINE  MEZZANINE EAST (UPPER LEVEL) MEZZANINE EAST (LOWER LEVEL) MEZZANINE WEST PLATFORM (TRACK B1) PLATFORM (TRACK B2)  MEZZANINE EAST MEZZANINE WEST PLATFORM (TRACK B1) PLATFORM (TRACK B2)  PLATFORM (TRACK B2)  PLATFORM (TSI SIGN) MEZZANINE NORTH MEZZANINE CENTER  PLATFORM MEZZANINE  PLATFORM MEZZANINE  PLATFORM MEZZANINE  PLATFORM MEZZANINE  PLATFORM MEZZANINE  PLATFORM MEZZANINE  PLATFORM (TRACK B1) PLATFORM (TRACK B2) MEZZANINE	C112 C103 C103 C103 C103 C103 E206 E206 W106 W106 W106 W106 W108 U109 109 214 C200 101 101 C106 C100 C100 C100 C100 C100	M1 M M M M M AFCE AFCW NWPP NWPA NWPA NWPA SPO1 SPO1 SPO1 SPO1 PP LP-MH LP-F LP-FF LP-FF LP-FF LP-FF LP-FF	120 120 120 120 120 120 120 120 120 120	32 19 21 20 35 37 12 1, 3, 5 7, 9, 11 23 23 23 7, 9, 11 8, 10, 12 1 9 31 43 37, 39, 41 33 7, 9, 11 28 4 6 8	ELECTRICAL EQUIPMENT ROOM  ELECTRICAL ROOM  ELECTRICAL ROOM  ELECTRICAL ROOM  ELECTRICAL ROOM  ELECTRICAL ROOM  ELECTRICAL ROOM  MECHANICAL EQUIPMENT ROOM  AC SWITCHBOARD ROOM  ELECTRICAL EQUIPMENT ROOM  WALKWAY EQUIP ROOM

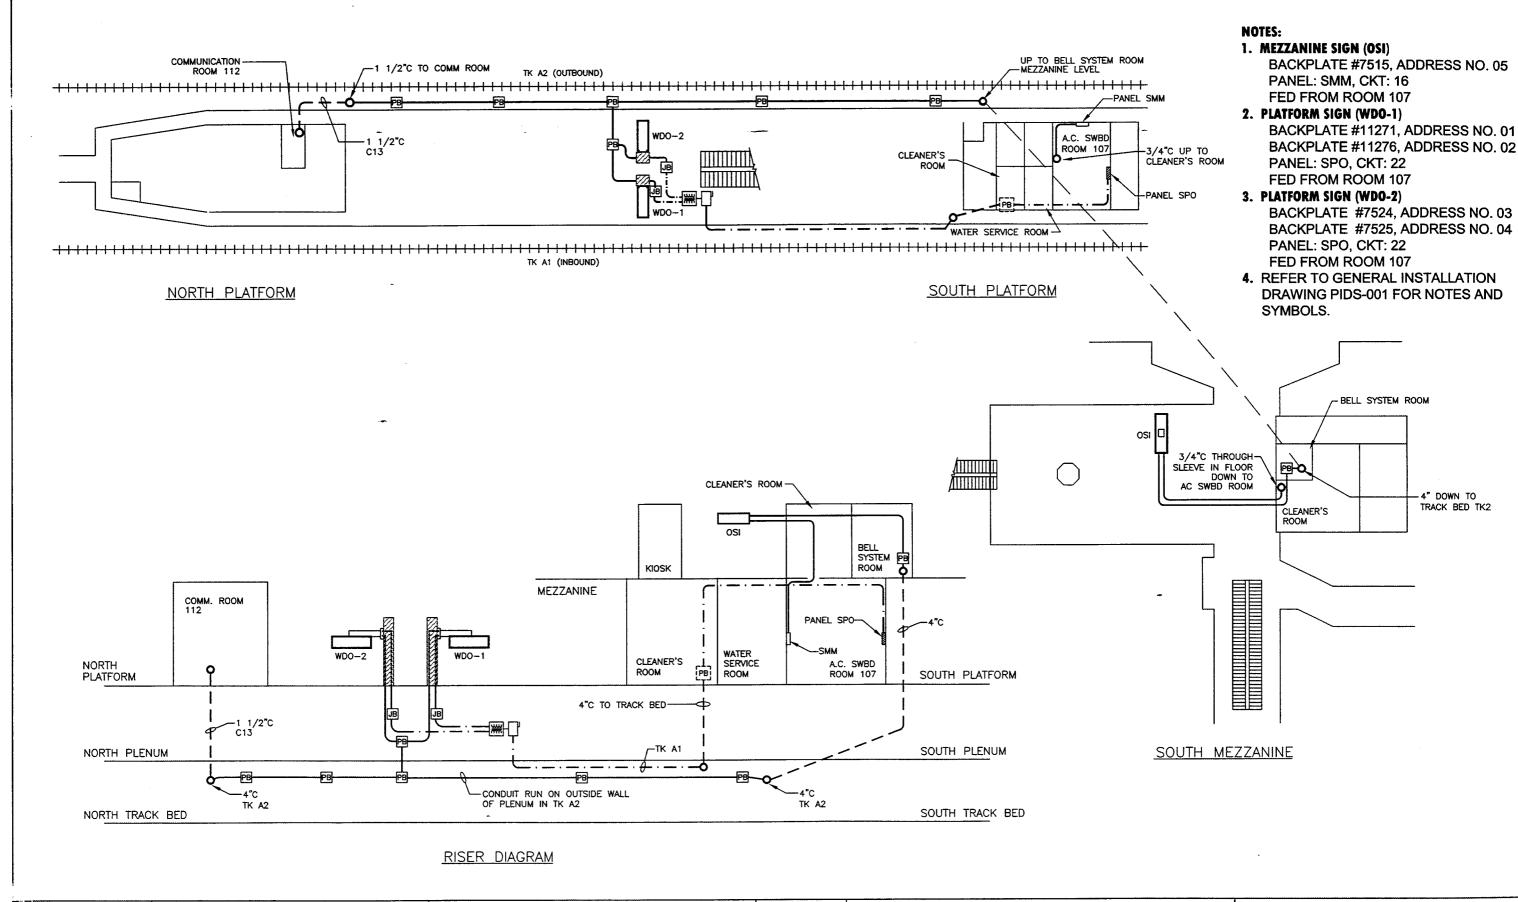


### REVISIONS REFERENCE DRAWINGS CONTRACT NO. WASHINGTON METROPOLITAN AREA TRANSIT AUTHORITY GROSVENOR STATION (A11) BY APP. DATE TW JR 1/01 IFB FF-170/TGB DESCRIPTION NUMBER NO. 1 AS BUILT CHECKED H. CRAFT STATION LAYOUT & RISER DIAGRAM APPROVED T. WATSON 6/00 DATE **INOVA** (PASSENGER INFORMATION DISPLAY SYSTEM) NEXT ASSY. APPROVED J. ROGERS 6/00 DATE SIZE SCALE DRAWING NO. D NONE PIDS-A11 Walker Seal Companies, Inc.


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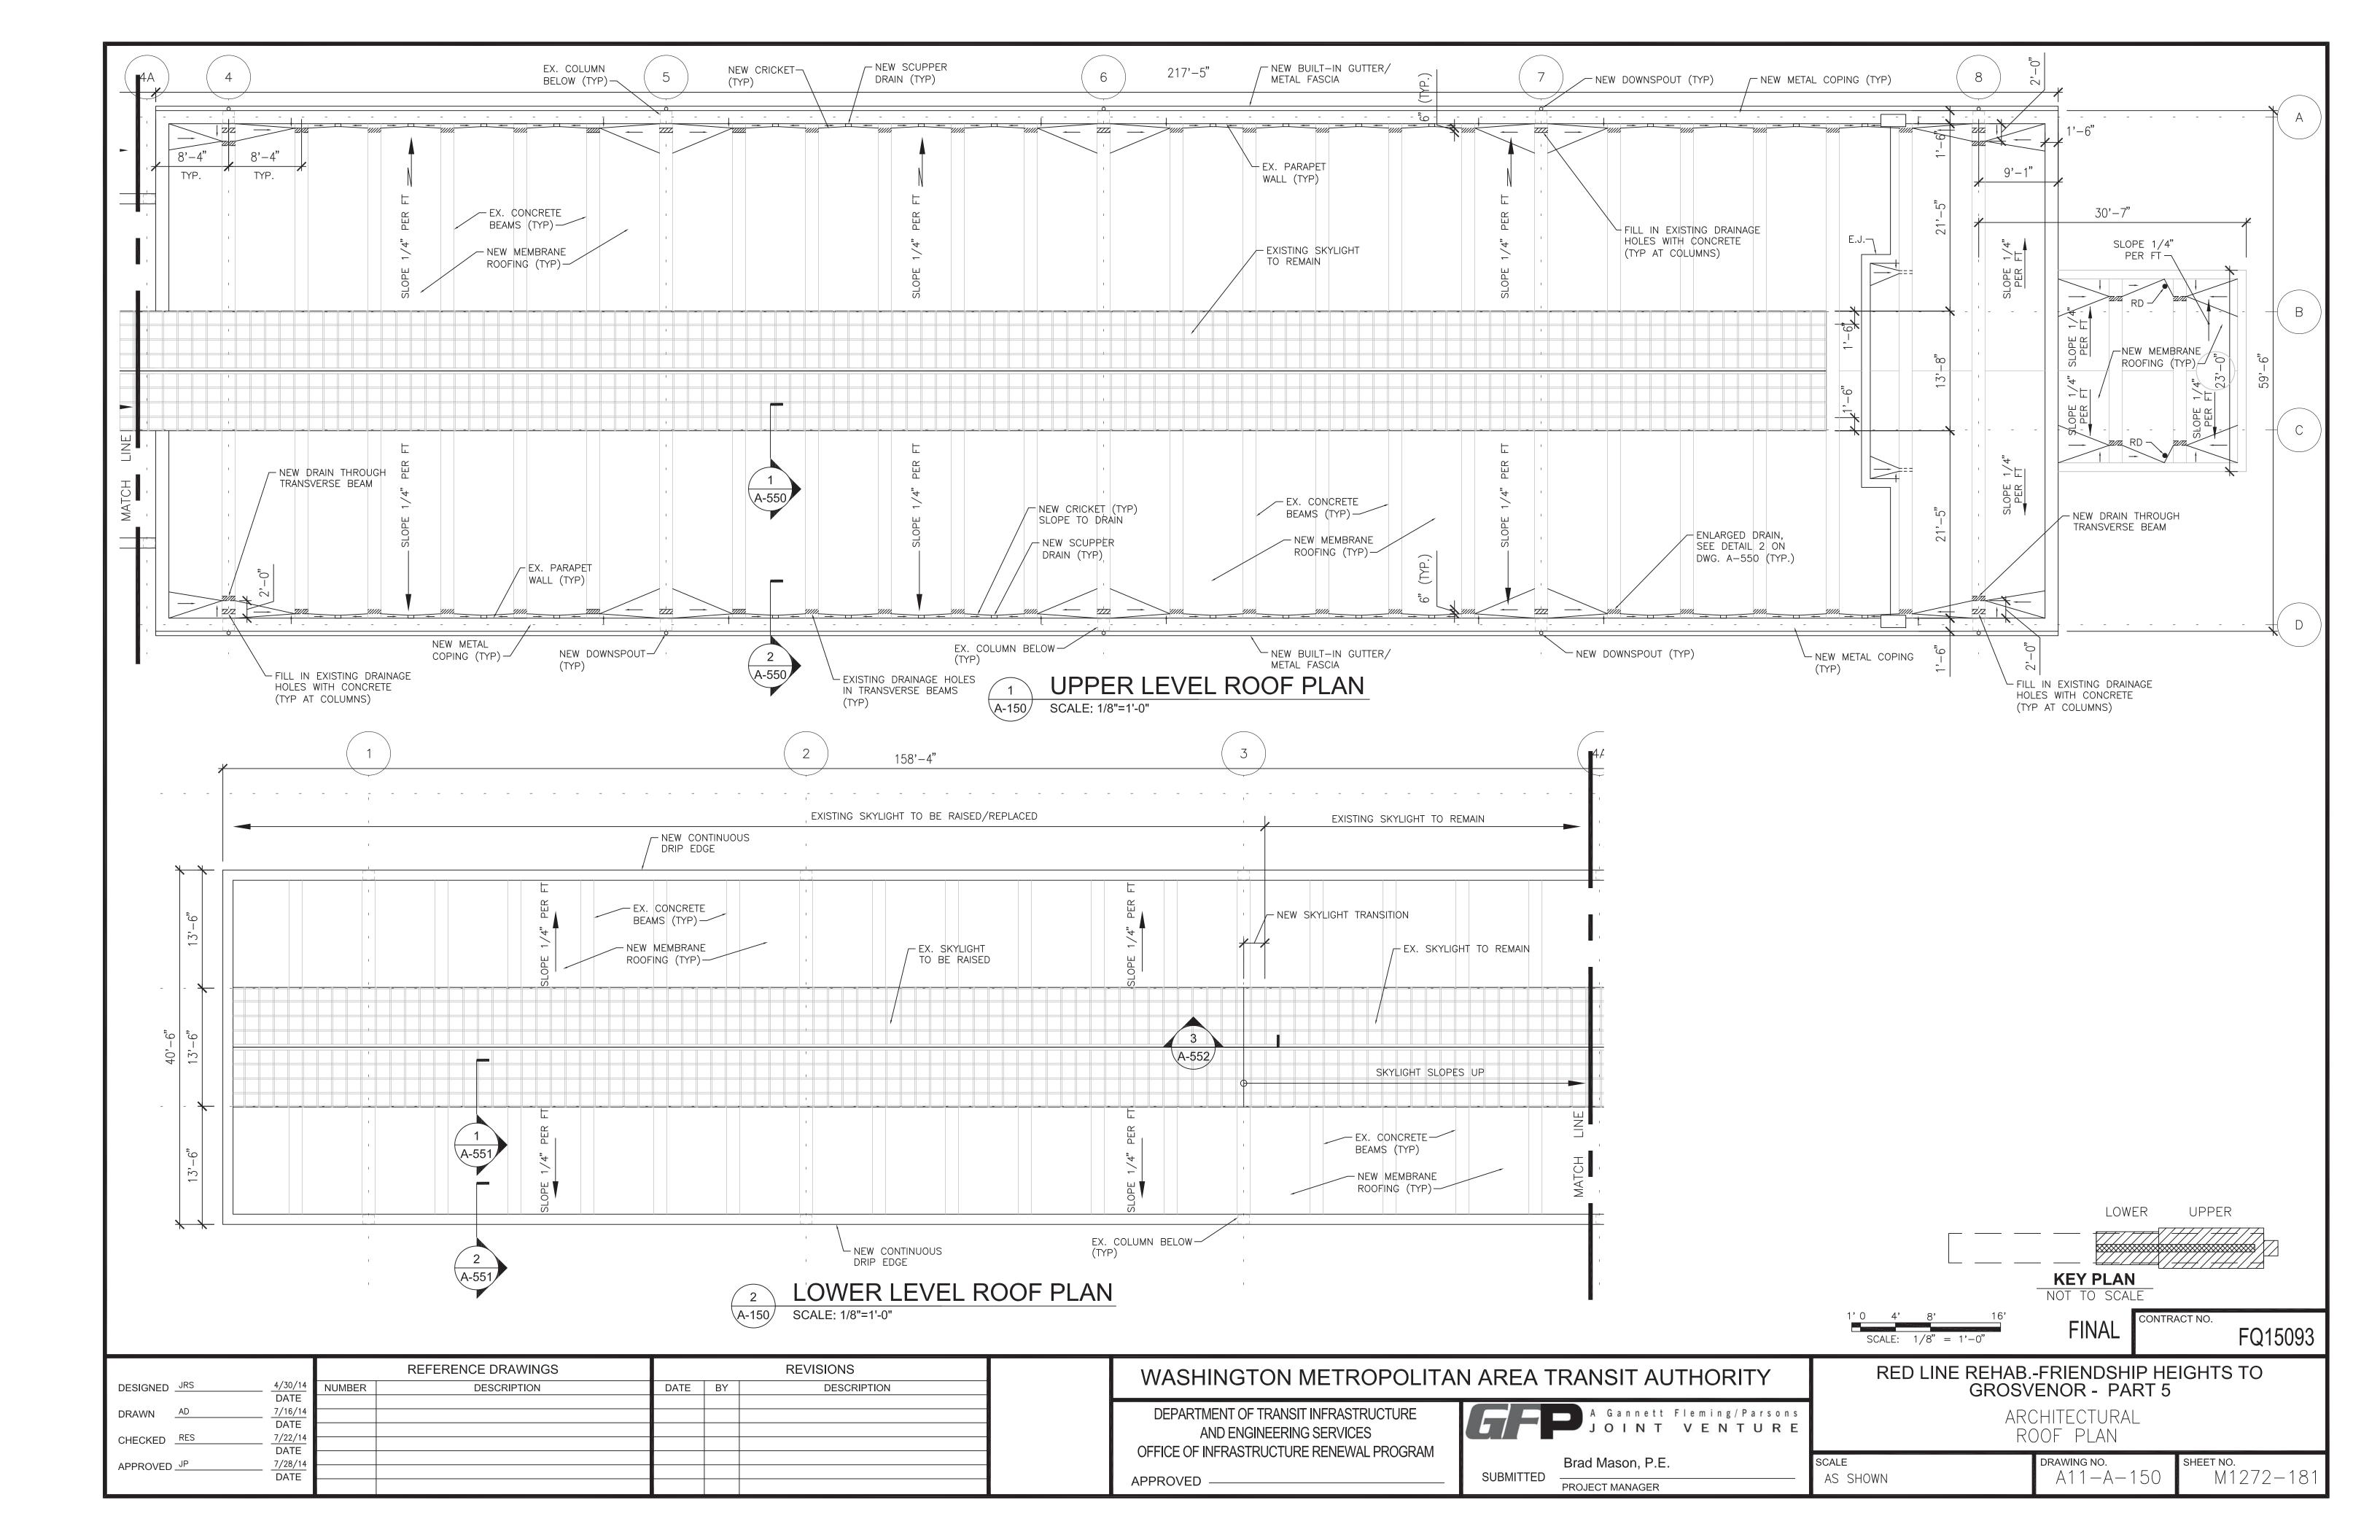


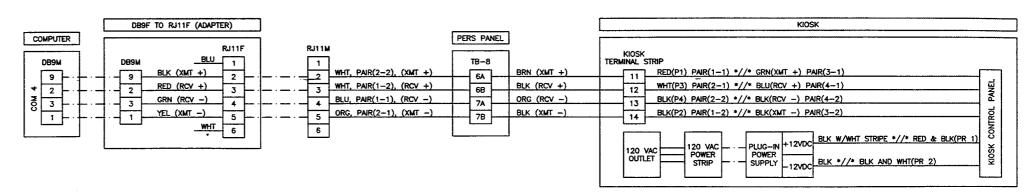
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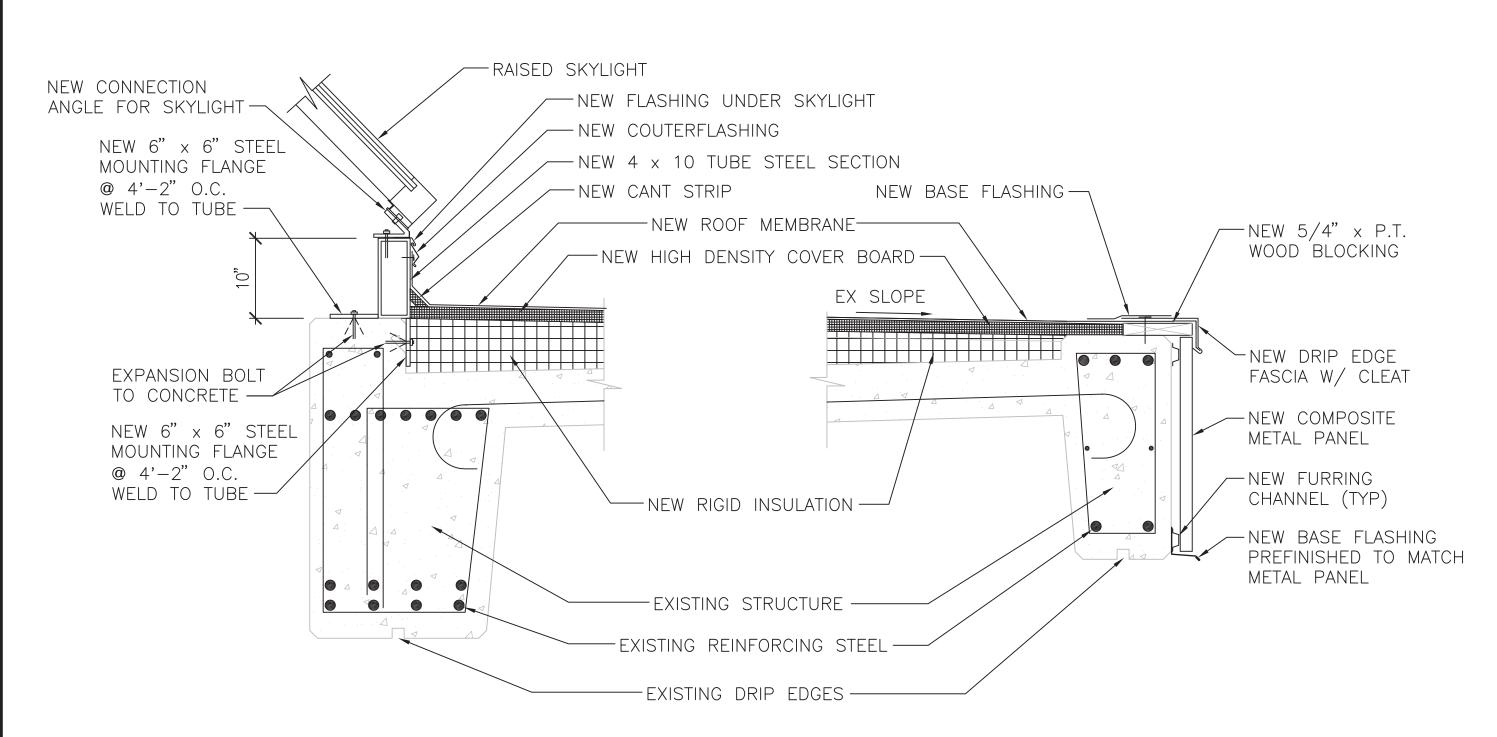


		REFERENCE DRAWINGS		REVISIONS			CONTRACT NO.	WACHINGTON METROPOLIT	AN AREA TRANSIT AUTHORITY	0000/51/00 (144)
DRAWN MFR 1/01 DATE	NUMBER	DESCRIPTION	NO.	DESCRIPTION	BY APP.	DATE	IFB FF-170/TGB	WASHINGTON METHOPOLIT	AN AREA TRANSIT AUTHORITT	GROSVENOR (A11)
CHECKED T. WATSON 1/01 DATE		-						TR .		PIDS STATION WIRING TERMINATION DIAGRAM
APPROVEDTWATSON1/01DATE								AE	INOVA	(PASSENGER INFORMATION DISPLAY SYSTEM)
APPROVED J. ROGERS 1/01 DATE							NEXT ASSY.	OM .		SIZE SCALE DRAWING NO.
Walker Seal Companies, Inc.							PID-A11b	OTHER		D NONE PIDS-A11 SH2 OF 2 2

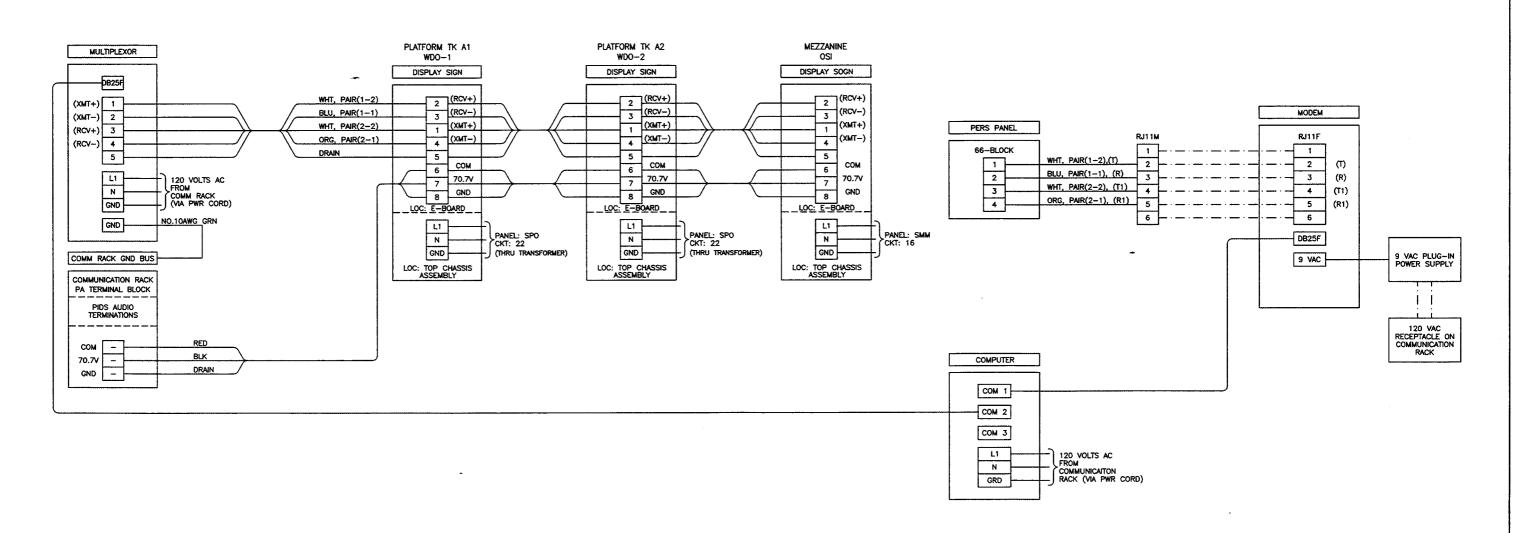



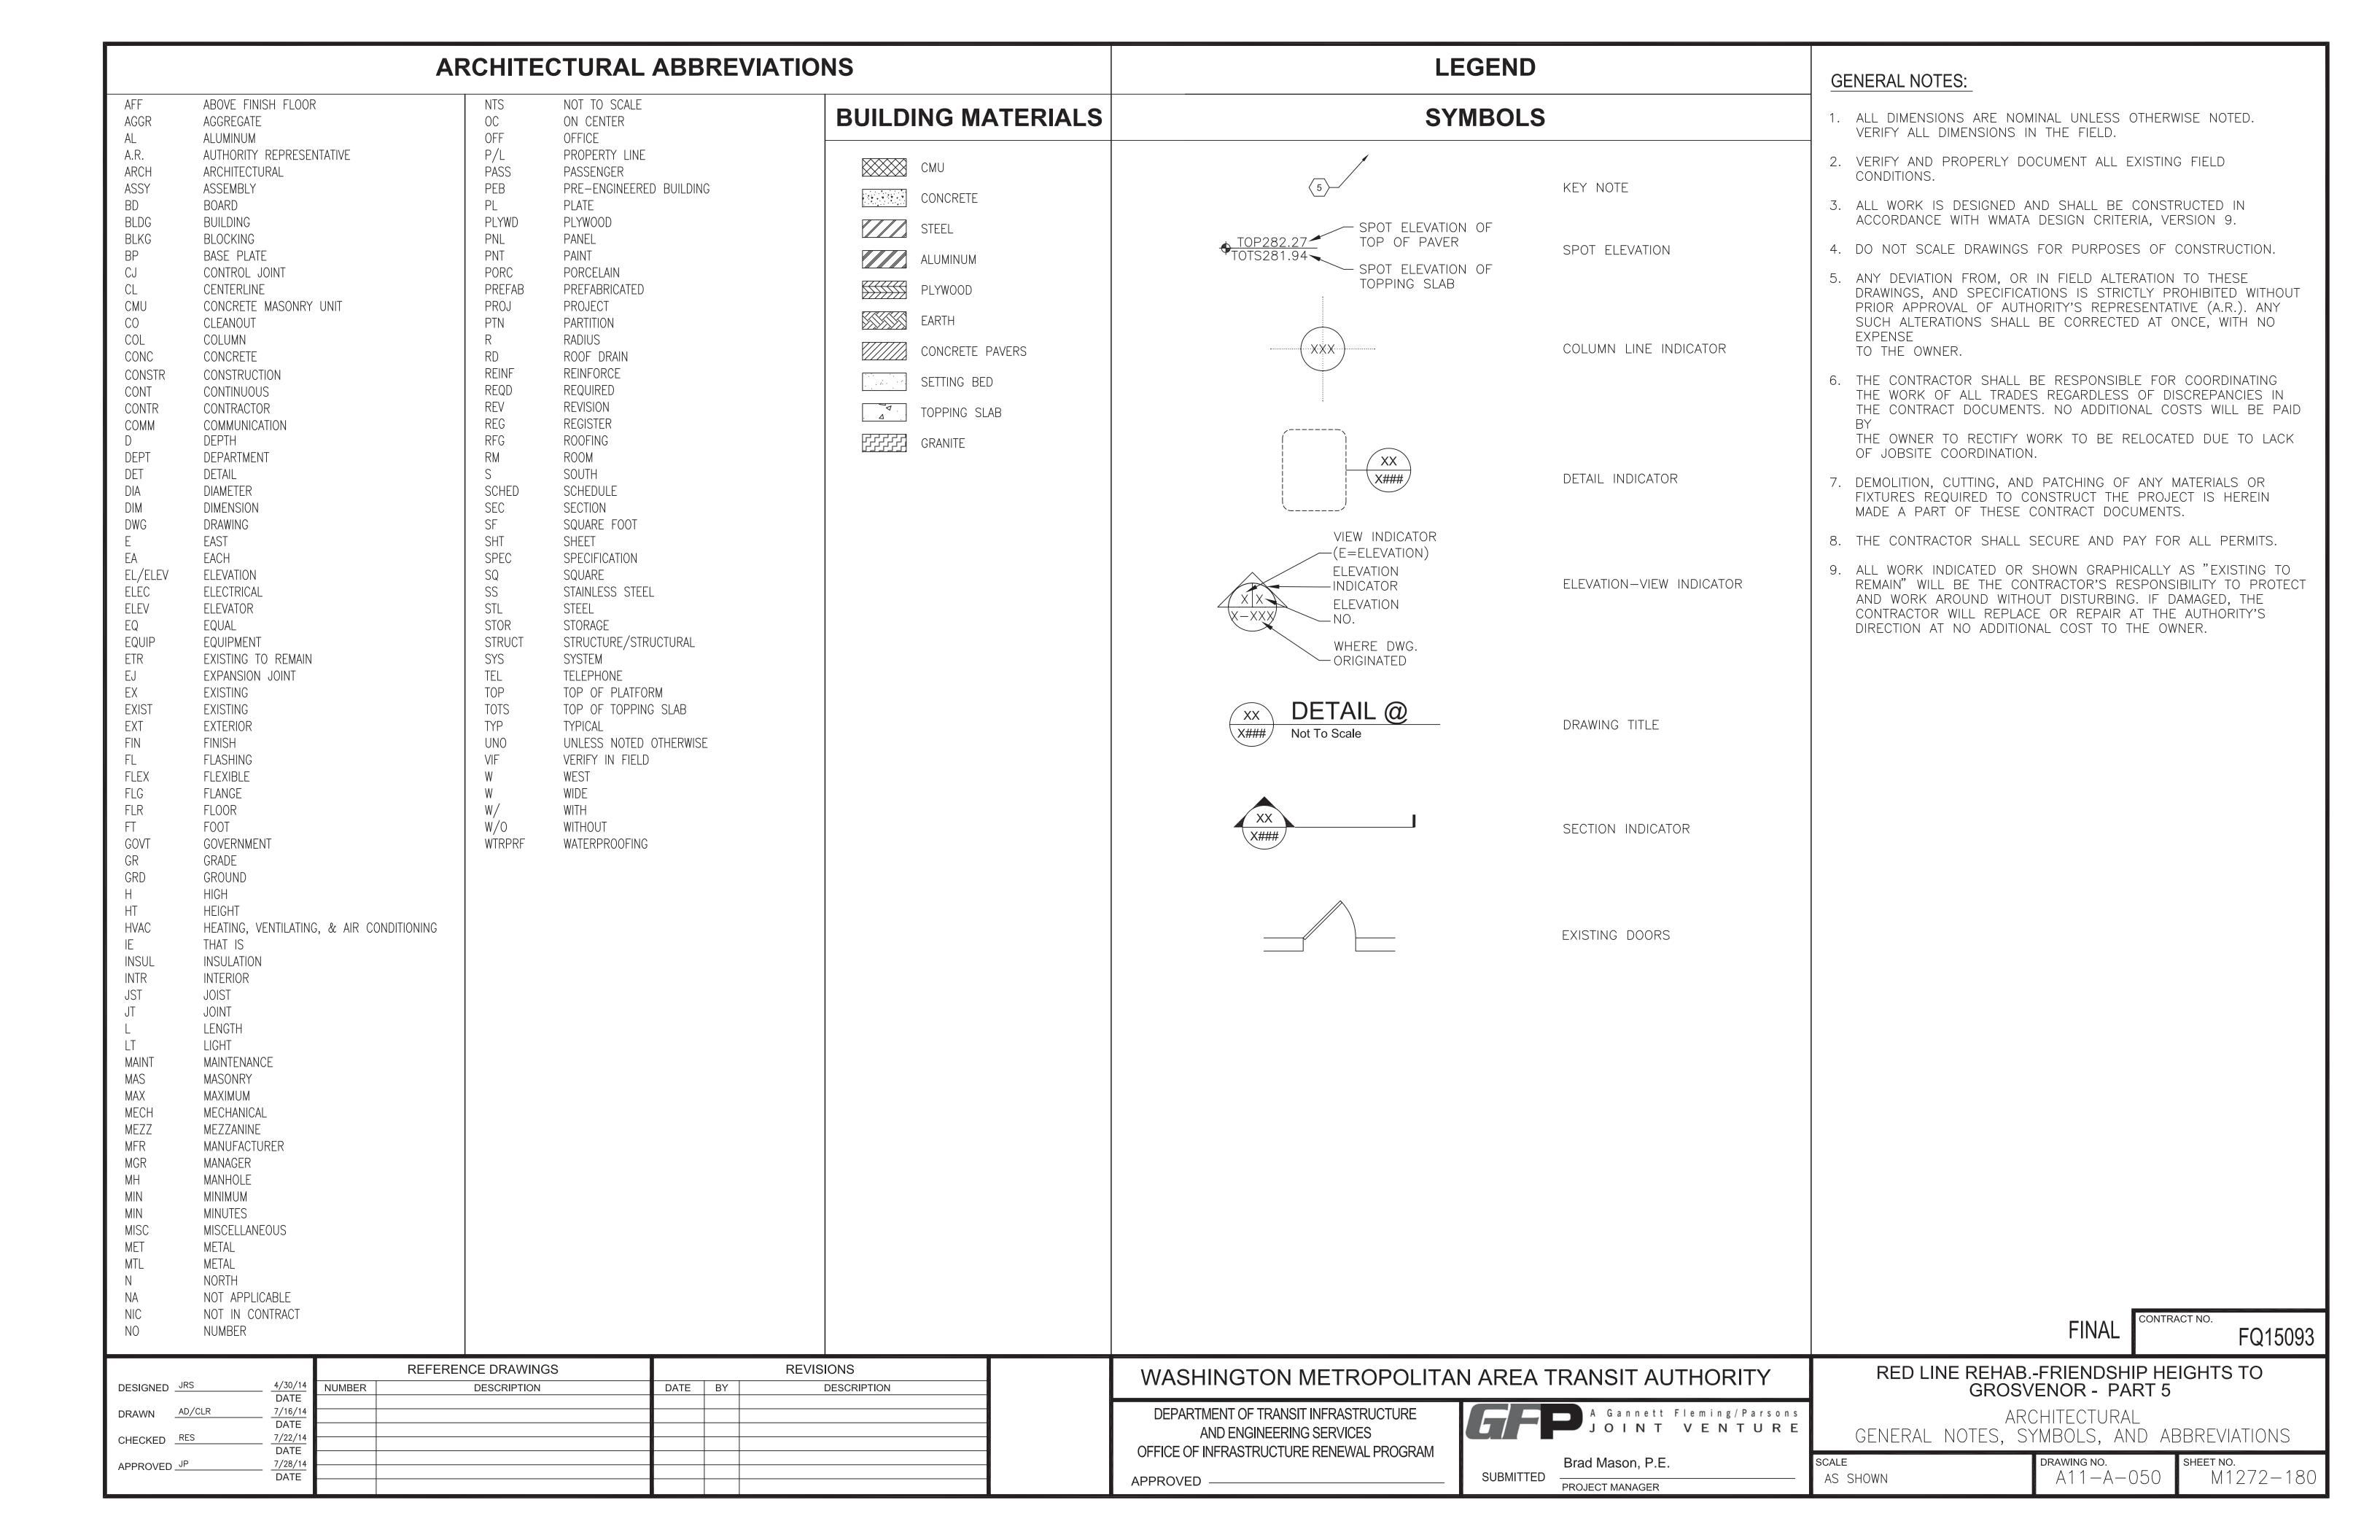

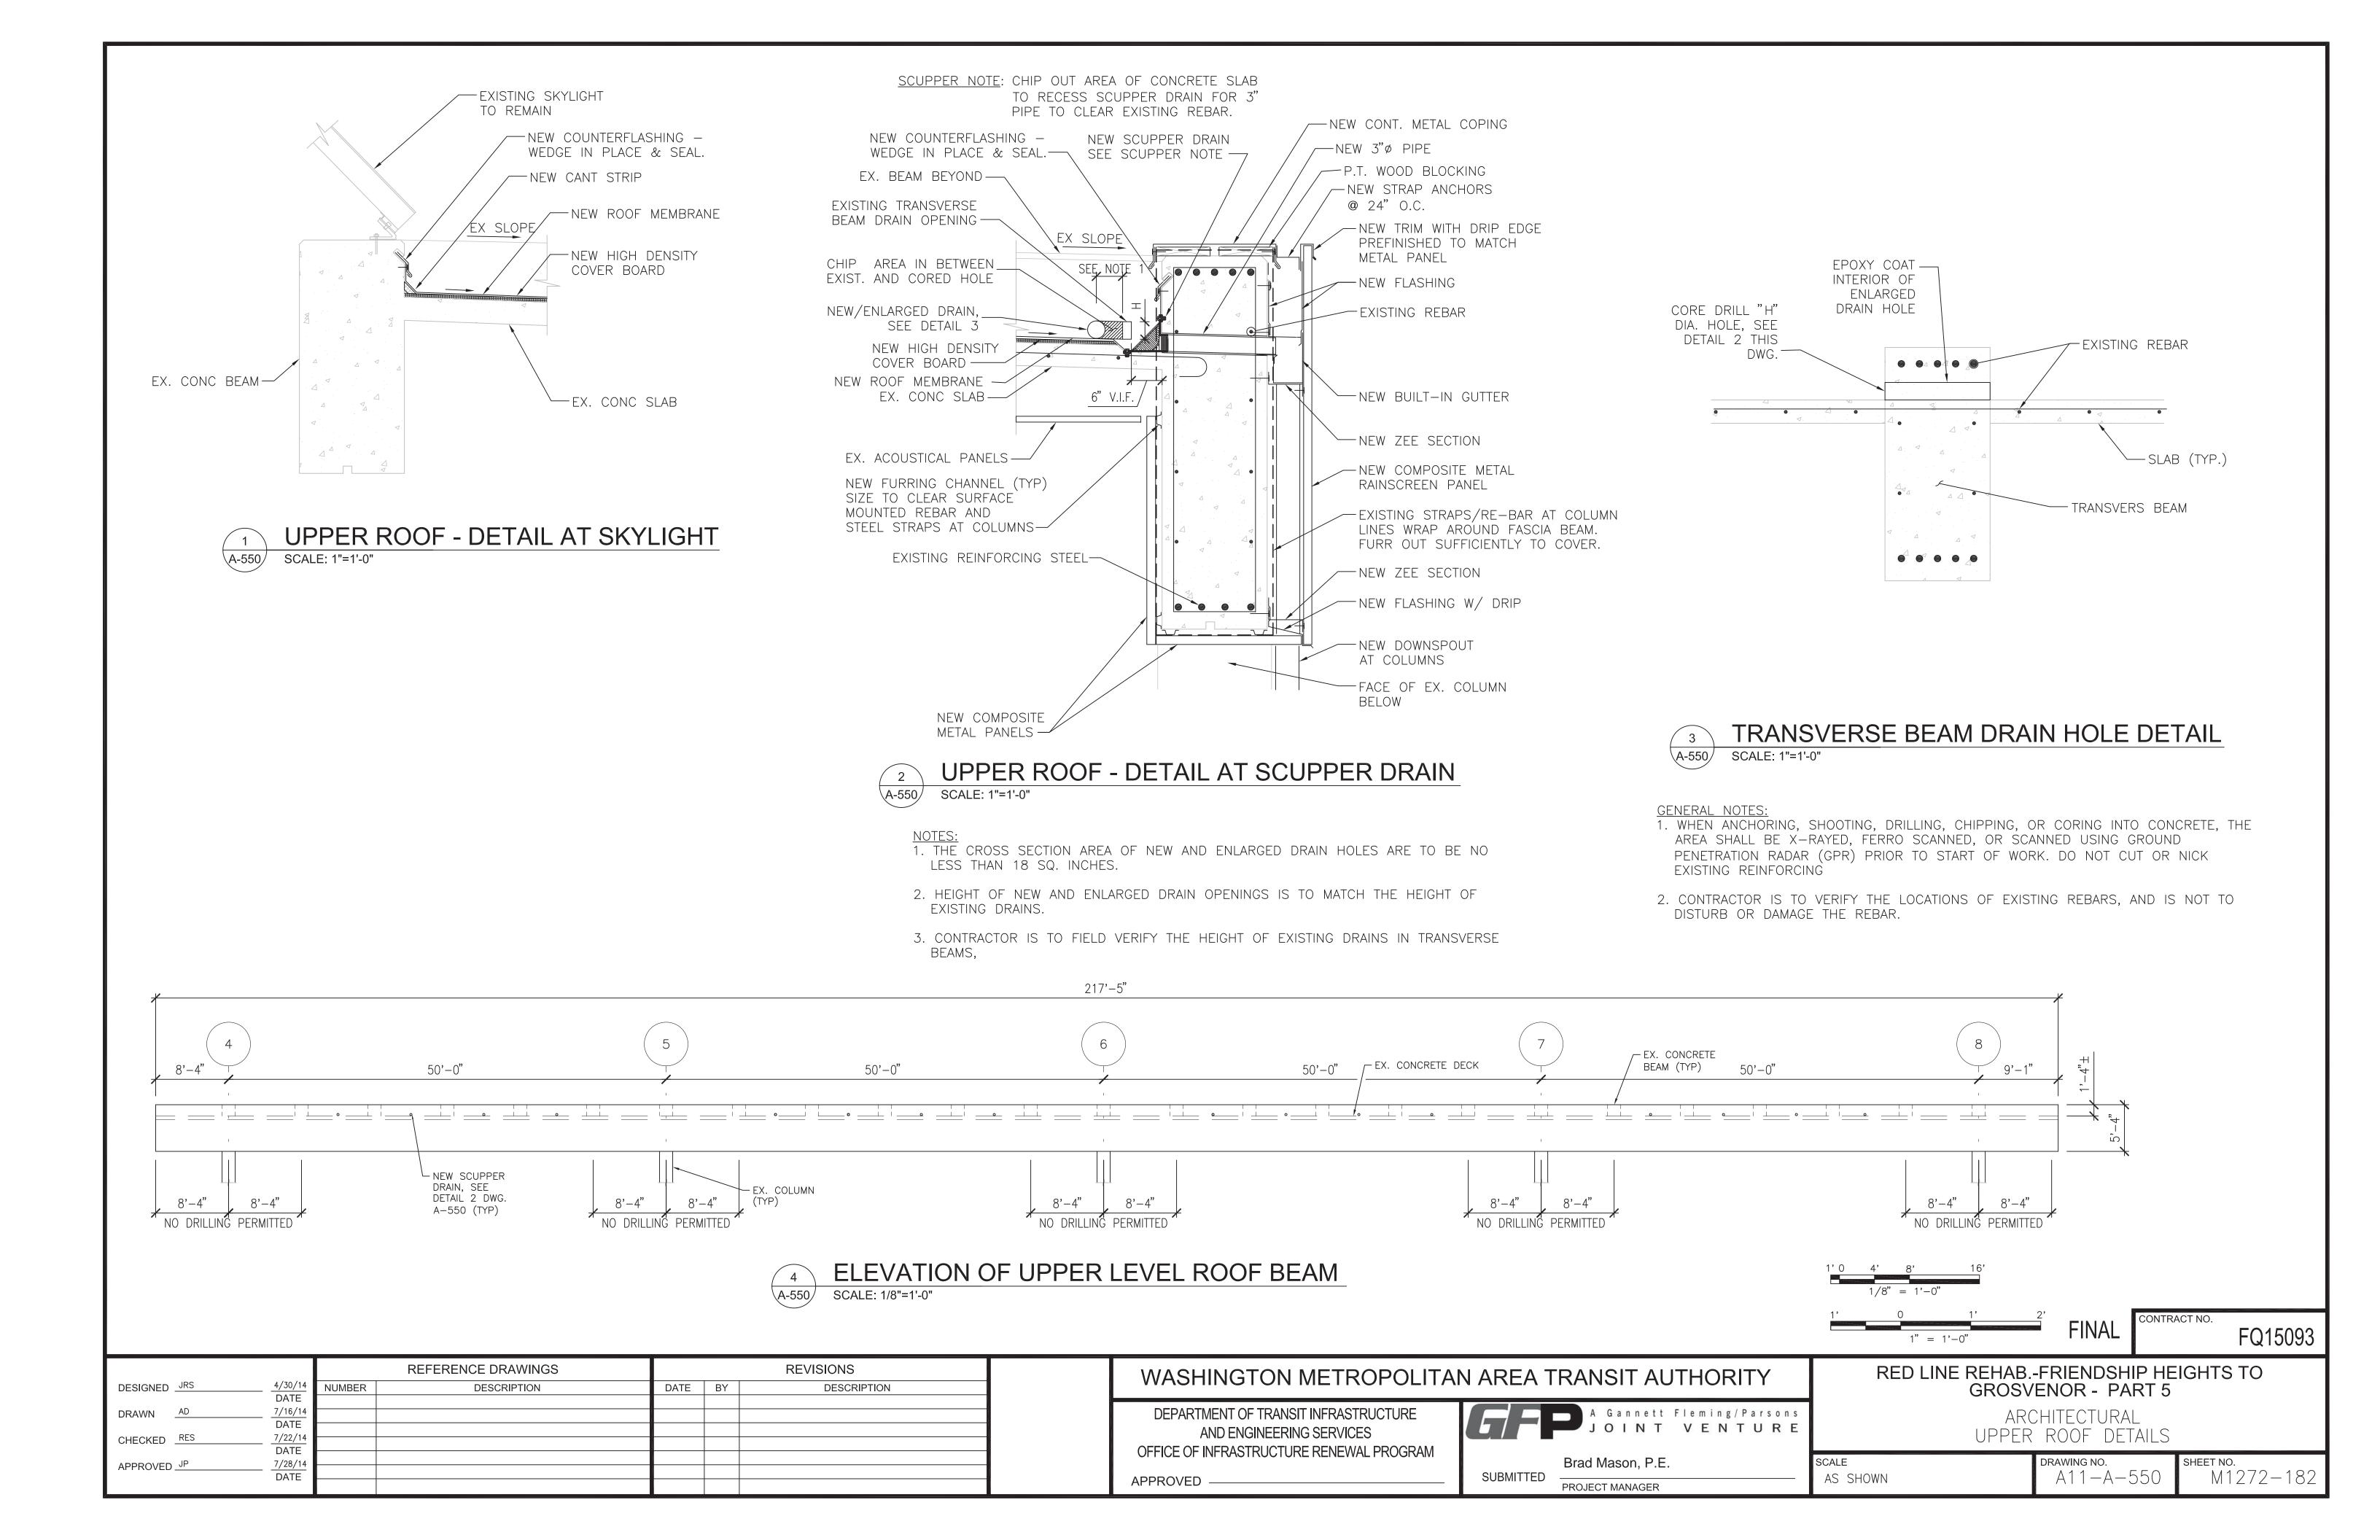

1 LOWER ROOF - DETAIL AT SKYLIGHT

A-551 SCALE: 1"=1'-0"

2 LOWER ROOF - DETAIL AT EDGE

SCALE: 1"=1'-0"

**GENERAL NOTES:** 

1. WHEN ANCHORING, SHOOTING, DRILLING, CHIPPING, OR CORING INTO CONCRETE, THE AREA SHALL BE X—RAYED, FERRO SCANNED, OR SCANNED USING GROUND PENETRATION RADAR (GPR) PRIOR TO START OF WORK. DO NOT CUT OR NICK EXISTING REINFORCING

2. CONTRACTOR IS TO VERIFY THE LOCATIONS OF EXISTING REBARS, AND IS NOT TO DISTURB OR DAMAGE THE REBAR.

1' 0 1' 2' 1" = 1'-0"

L CONTRACT

FQ15093

			REFERENCE DRAWINGS			REVISIONS	
DESIGNED JRS	4/30/14 DATE	NUMBER	DESCRIPTION	DATE	BY	DESCRIPTION	
DRAWN AD	7/16/14 DATE						
CHECKED RES	7/22/14						
APPROVED JP	DATE 7/28/14						
	DATE						

WASHINGTON METROPOLITAN AREA TRANSIT AUTHORITY

DEPARTMENT OF TRANSIT INFRASTRUCTURE
AND ENGINEERING SERVICES
OFFICE OF INFRASTRUCTURE RENEWAL PROGRAM

APPROVED -

A Gannett Fleming/Parsons
JOINT VENTURE

Brad Mason, P.E.

PROJECT MANAGER


RED LINE REHAB.-FRIENDSHIP HEIGHTS TO GROSVENOR - PART 5

ARCHITECTURAL

LOWER ROOF DETAILS

 SCALE
 DRAWING NO.
 SHEET NO.

 AS SHOWN
 A11-A-551
 M1272-183

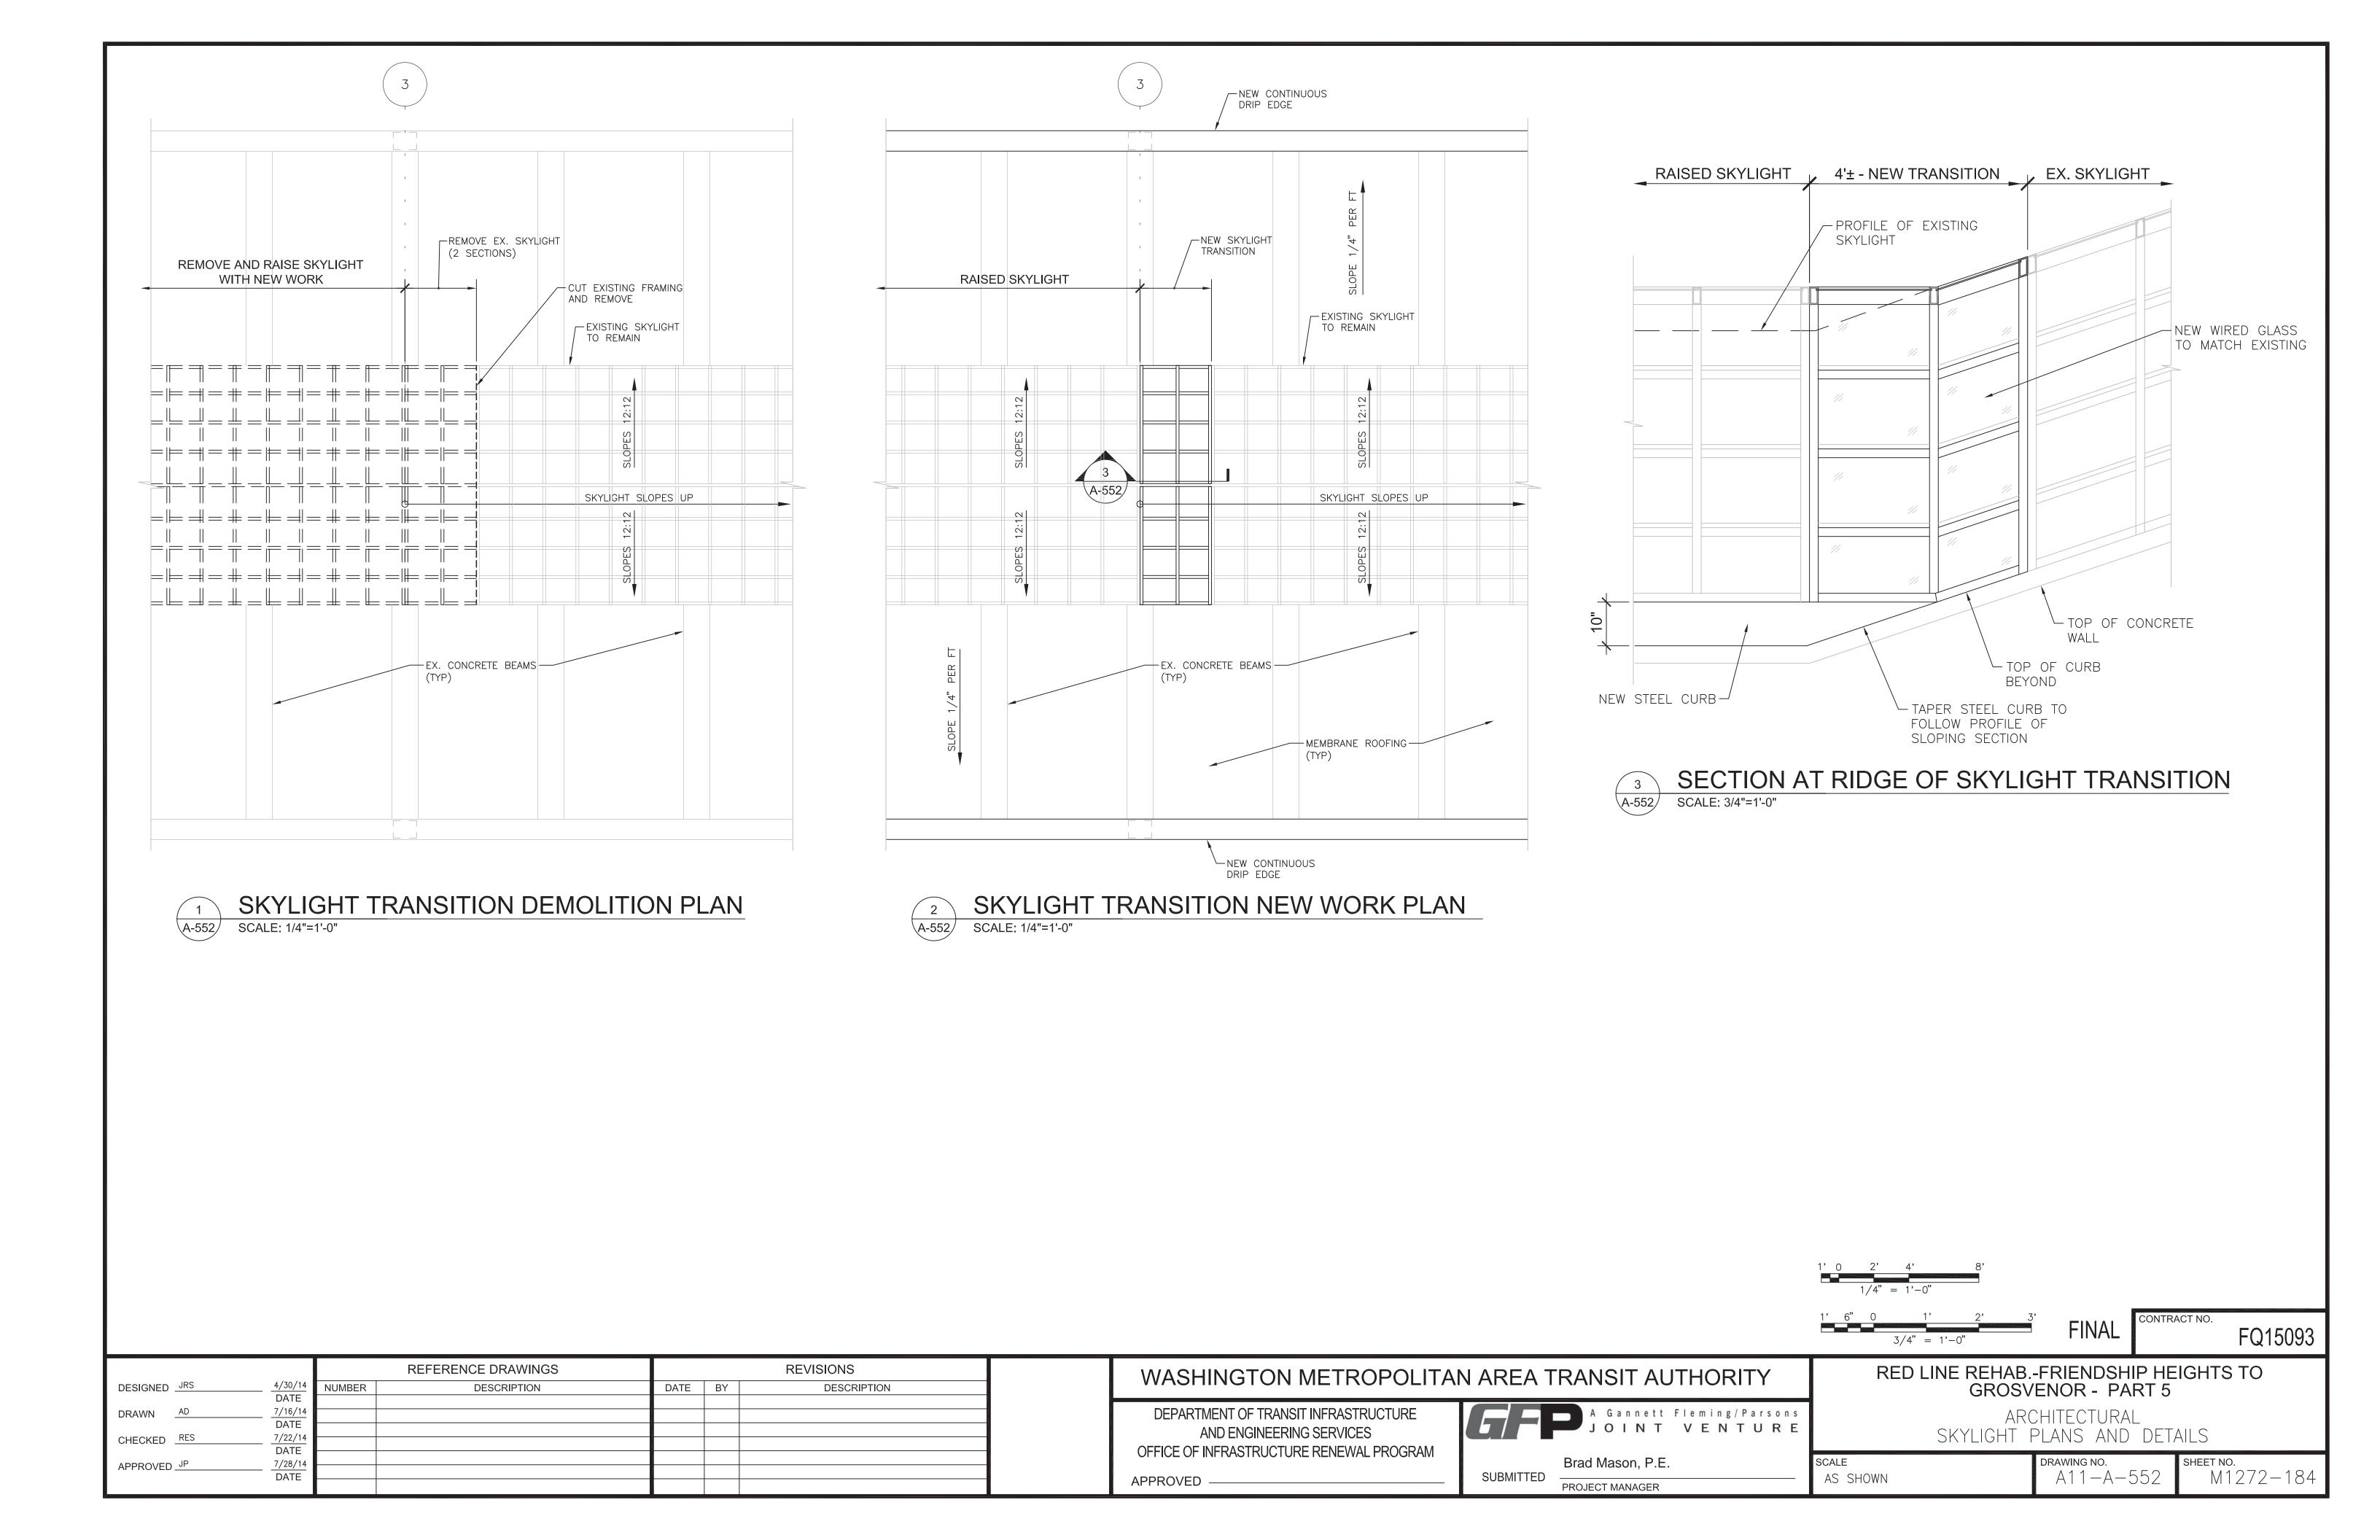

# MECHANICAL GENERAL NOTES:

- 1. THE CONTRACTOR SHALL VERIFY ALL CONDITIONS IN THE FIELD.
- 2. COORDINATE ALL MECHANICAL WORK WITH STRUCTURAL, ARCHITECTURAL, AND ANY OTHER TRADES PRIOR TO BEGINNING WORK.
- 3. THE PROPOSED CONCEPTS INCLUDED IN THIS SET ARE CONCEPTUAL DRAWINGS ONLY. THEY SHALL NOT BE USED FOR CONSTRUCTION.
- 4. PERFORM ALL DRAINAGE PIPING WORK IN ACCORDANCE WITH THE FOLLOWING SPECIFICATIONS:
- 4.1. 15075 IDENTIFICATION OF MECHANICAL EQUIPMENT AND PIPING 4.2. 15205 PIPING SYSTEMS
- 5. ALL NEW WORK SHALL COMPLY WITH NATIONAL, STATE, AND LOCAL CODE REQUIREMENTS, INCLUDING BUT NOT LIMITED TO THE FOLLOWING (SEE SPECIFICATIONS FOR LISTING OF APPLICABLE CODES AND STANDARDS):

5.a. 2012 INTERNATIONAL BUILDING CODE 5.b. 2012 INTERNATIONAL PLUMBING CODE

# SCOPE OF MECHANICAL WORK

THE EXISTING ROOF DRAINAGE SYSTEM FOR THE GROSVENOR CANOPY IS INADEQUATE AND RESULTS IN STANDING WATER ON THE ROOF. THE SCOPE OF THIS PROJECT IS TO REDIRECT THE DRAINAGE FROM WITHIN THE EXISTING PLATFORM COLUMNS TO THE OUTER EDGE OF THE CANOPY.

# CONCEPT NOTES:

THE UPPER ROOF LEVEL OF THE GROSVENOR CANOPY SHALL BE MODIFIED AS FOLLOWS:

- ROOF SHALL BE RE-SURFACED (SEE ARCHITECTURAL PLANS).
- EXISTING DRAINS SHALL BE FILLED AND ABANDONED IN PLACE.
   NEW SCUPPER DRAINS SHALL BE INSTALLED, WITH LEADERS
- NEW SCUPPER DRAINS SHALL BE INSTALLED, WITH LEADERS
   THAT PENETRATE THE PARAPET WALL AND ASSOCIATED METAL
   PANEL TO TIE INTO A PROPOSED GUTTER.
- THE PROPOSED GUTTER SHALL HAVE DRAIN LEADERS AT EACH STRUCTURAL COLUMN THAT DISCHARGE TO GRADE LEVEL.

THE LOWER ROOF LEVEL OF THE GROSVENOR CANOPY SHALL BE MODIFIED AS FOLLOWS:

- ROOF SHALL BE RE-SURFACED TO REVERSE THE SLOPE DIRECTION FROM TOWARDS THE MIDDLE OF THE STATION TO TOWARDS THE EDGE OF THE CANOPY.
- EXISTING DRAINS SHALL BE FILLED AND ABANDONED IN PLACE.
- DRAINAGE SHALL DRIP OFF OF THE CANOPY EDGE ONTO THE TRACKBED.

# MECHANICAL ABBREVIATIONS:

- D ROOF DRAIN
- SD SCUPPER DRAIN

# MECHANICAL SYMBOLS

PROPOSED GUTTER (PLAN)

PROPOSED PIPING

— — PROPOSED PIPING (HIDDEN)

ROOF DRAIN (PLAN)

ROOF DRAIN (SECTION)

PROPOSED GUTTER (SECTION)

SCUPPER DRAIN (PLAN)

SCUPPER DRAIN (SECTION)

FINAL

FQ15093

D EDIEND

RED LINE REHAB.-FRIENDSHIP HEIGHTS TO GROSVENOR - PART 5

MECHANICAL GENERAL NOTES, SYMBOLS, AND ABBREVIATIONS

DRAWI

SCALE NONE

DRAWING NO. **A11-M-050** 

M1272-185

DEPARTMENT OF TRANSIT INFRASTRUCTURE
AND ENGINEERING SERVICES
OFFICE OF INFRASTRUCTURE RENEWAL PROGRAM

APPROVED —


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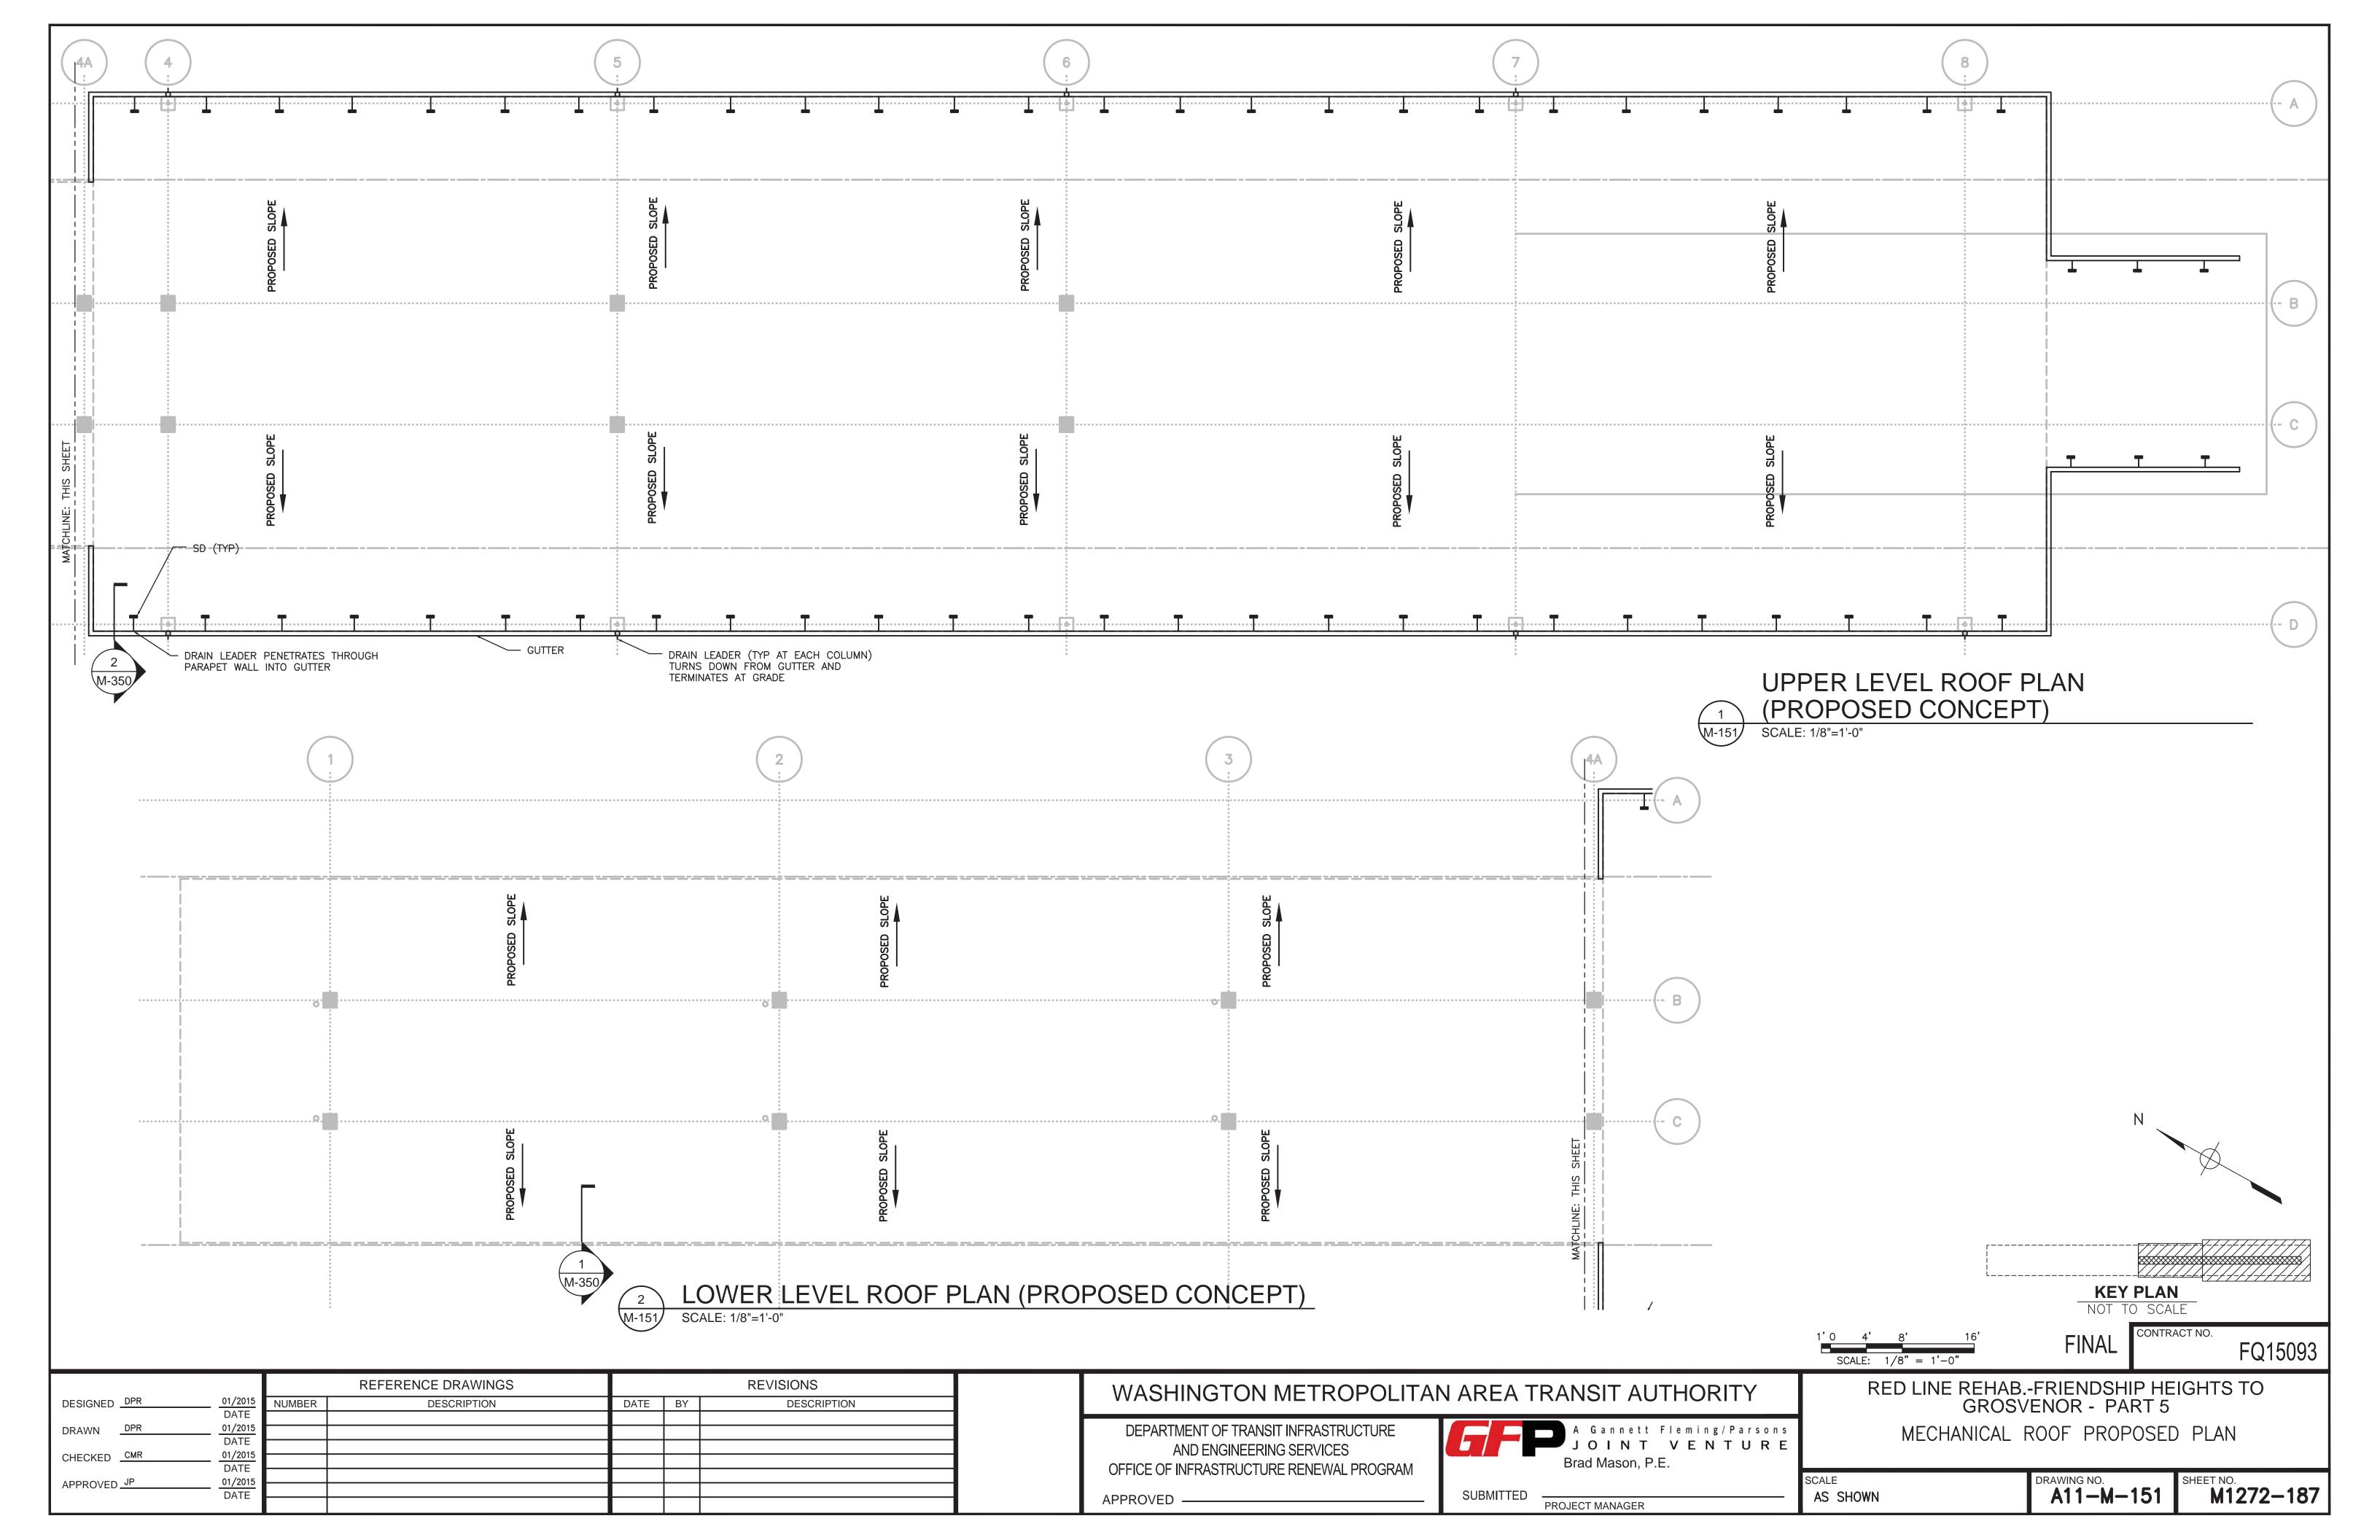
WASHINGTON METROPOLITAN AREA TRANSIT AUTHORITY


PROJECT MANAGER


Brad Mason, P.E.

A Gannett Fleming/Parsons
JOINT VENTURE



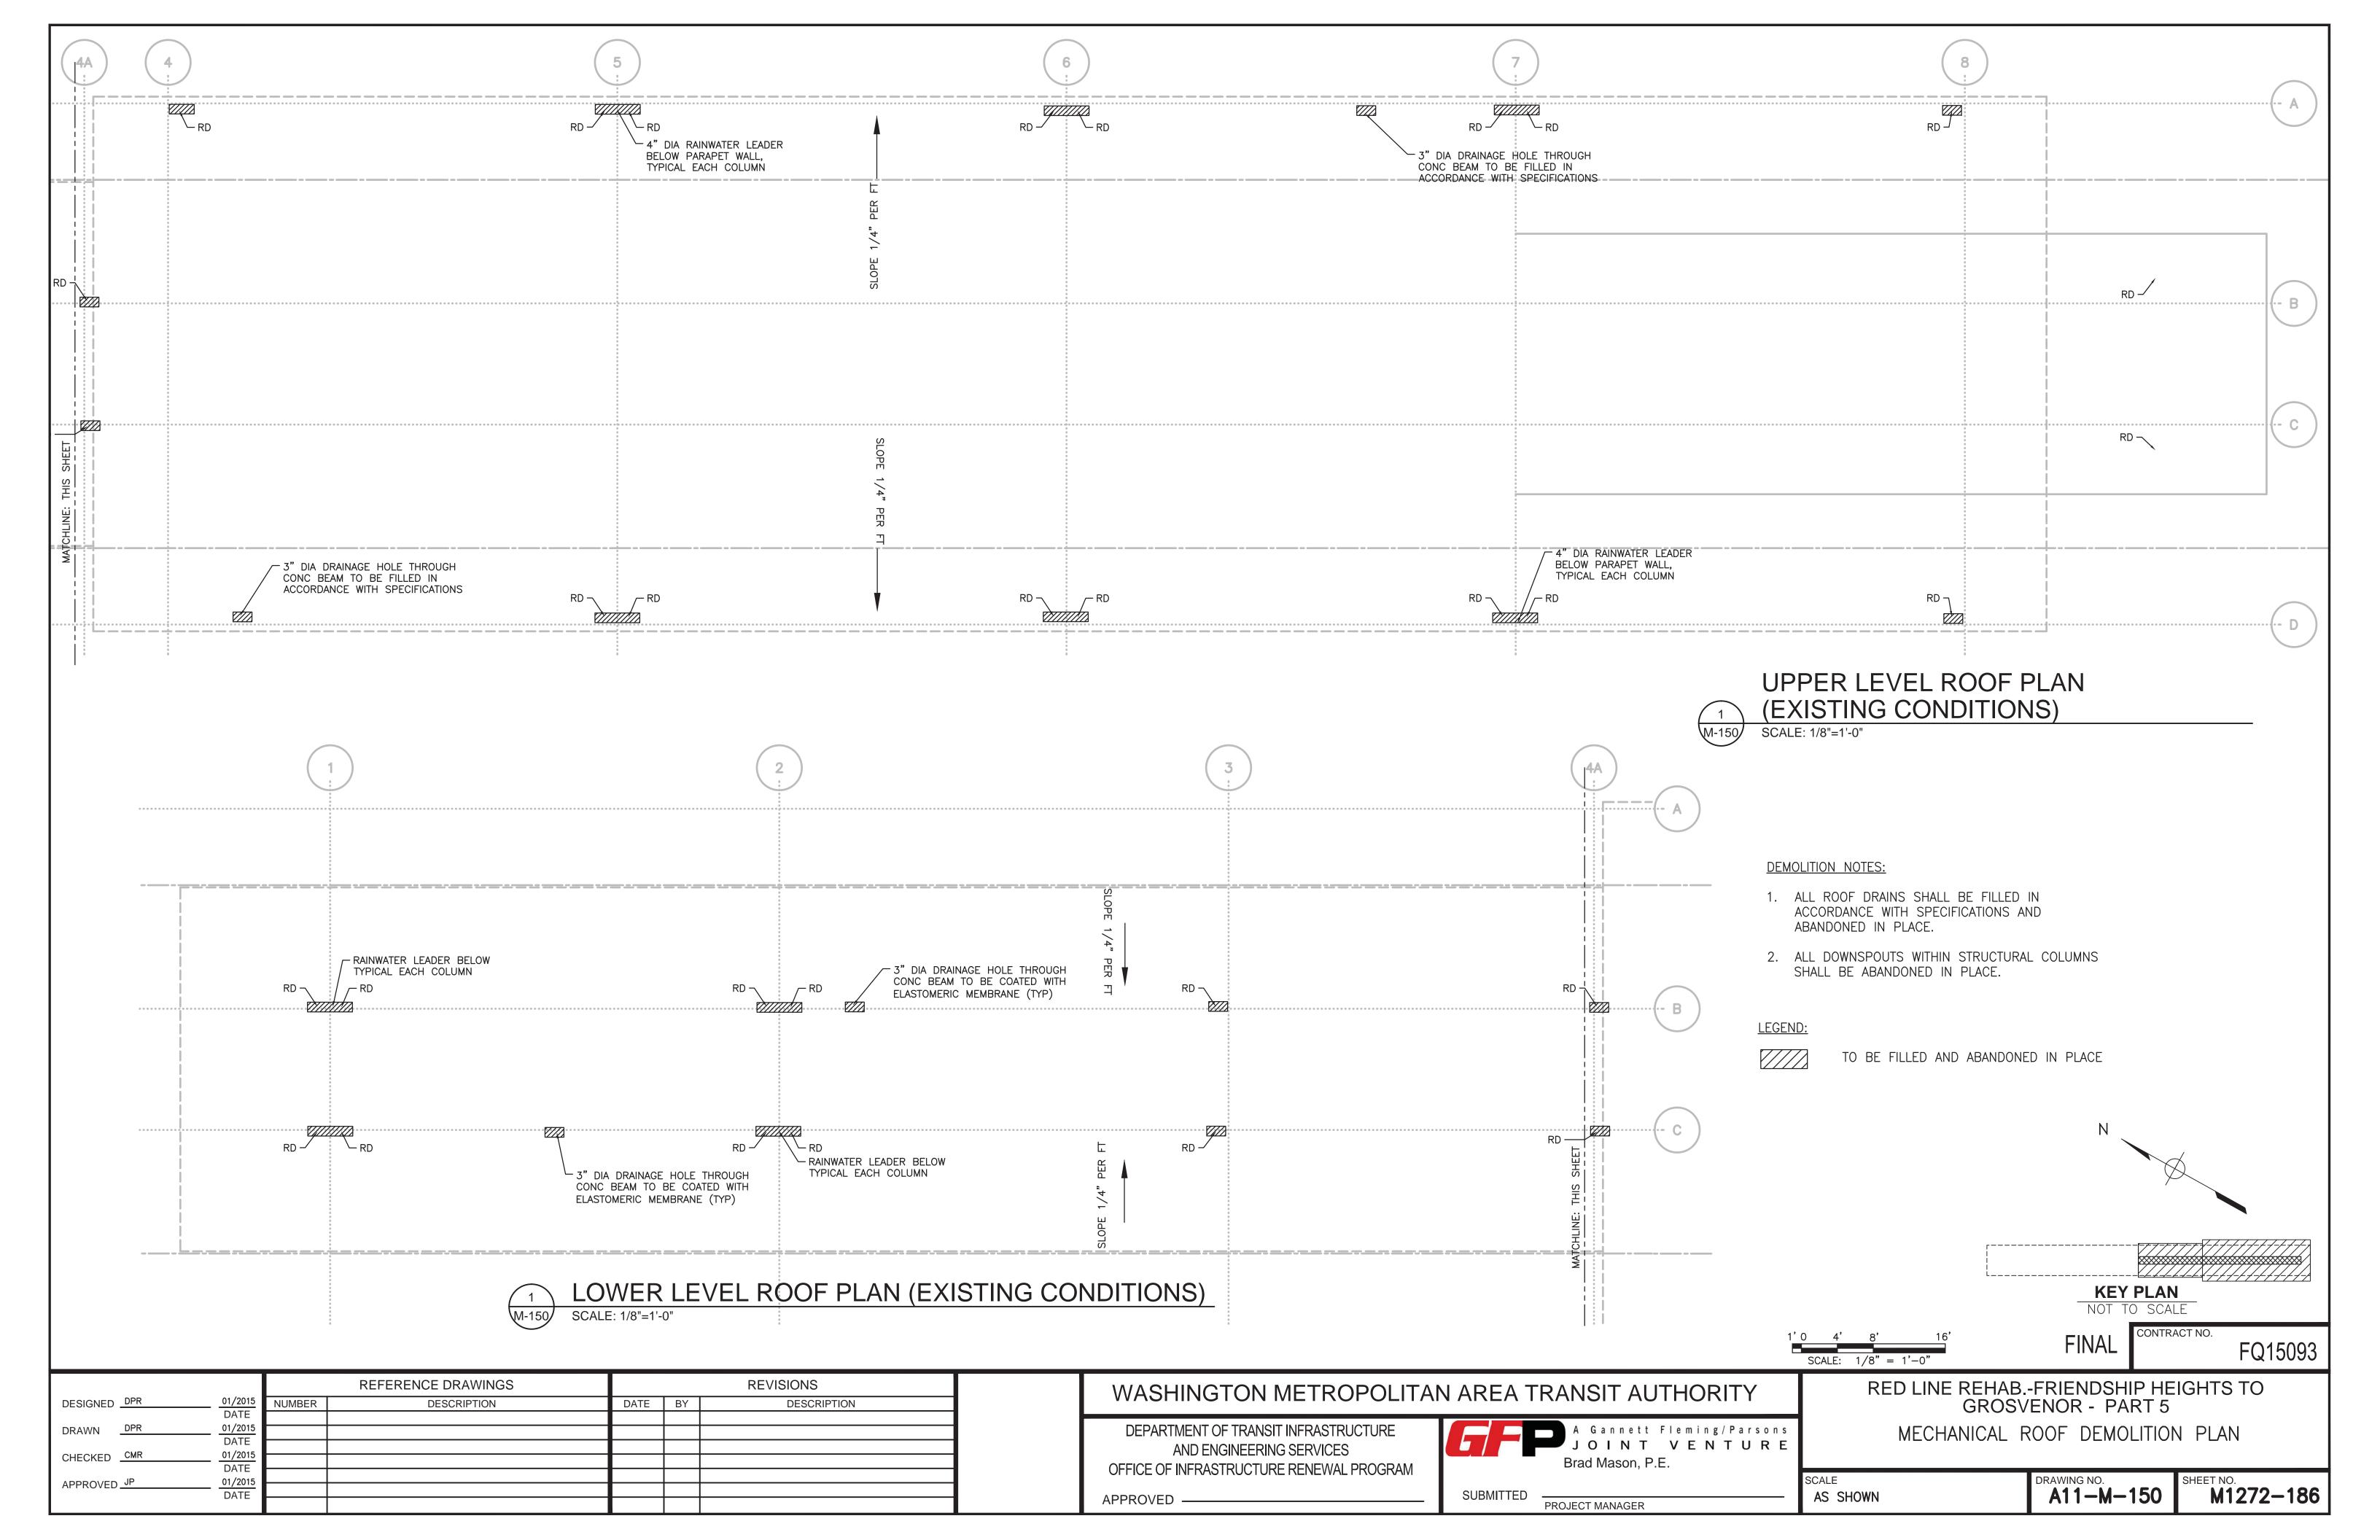

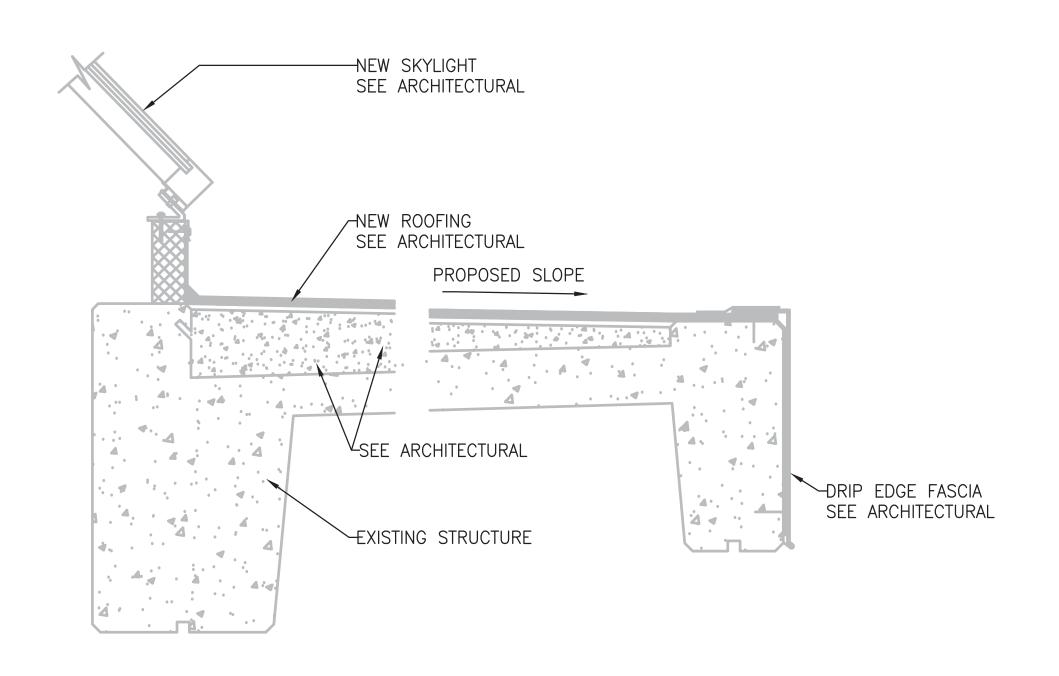

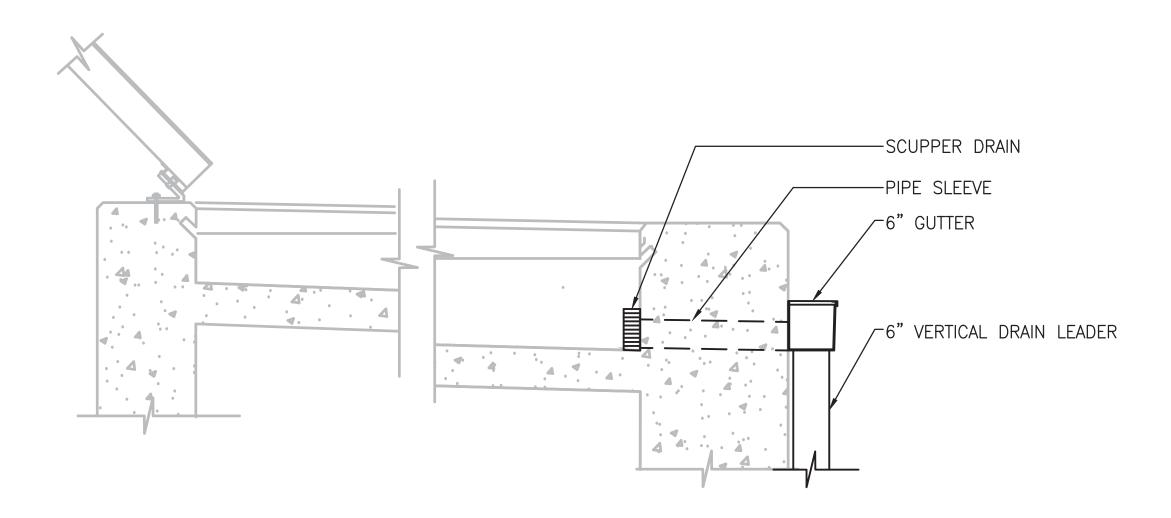

TYPICAL SECTION AT LOWER ROOF

SCALE: 1"=1'-0"

TYPICAL SECTION AT SCUPPER DRAIN

SCALE: 1"=1'-0"

		F	REFERENCE DRAWINGS				REVISIONS
DESIGNED DPR	01/2015 DATE	NUMBER	DESCRIPTION		DATE	BY	DESCRIPTION
DRAWN DPR	01/2015			-			
CHECKED CMR	DATE 01/2015						
CHECKED CMR	DATE						
APPROVED JP	01/2015 DATE						

WASHINGTON METROPOLITAN AREA TRANSIT AUTHORITY

DEPARTMENT OF TRANSIT INFRASTRUCTURE
AND ENGINEERING SERVICES
OFFICE OF INFRASTRUCTURE RENEWAL PROGRAM

APPROVED —




RED LINE REHAB.-FRIENDSHIP HEIGHTS TO GROSVENOR - PART 5 MECHANICAL ROOF PROPOSED SECTIONS


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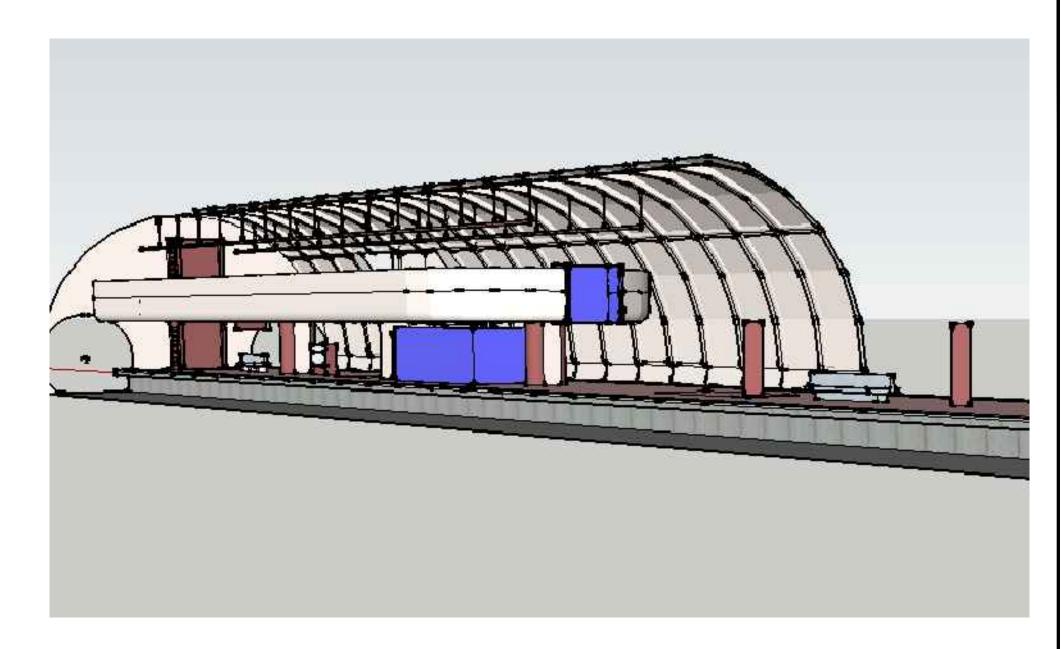
FQ15093

6" 3" 0 3" 6" 1 SCALE: 1" = 1'-0"

SCALE DRAWING NO. SHEET NO. M1272-188



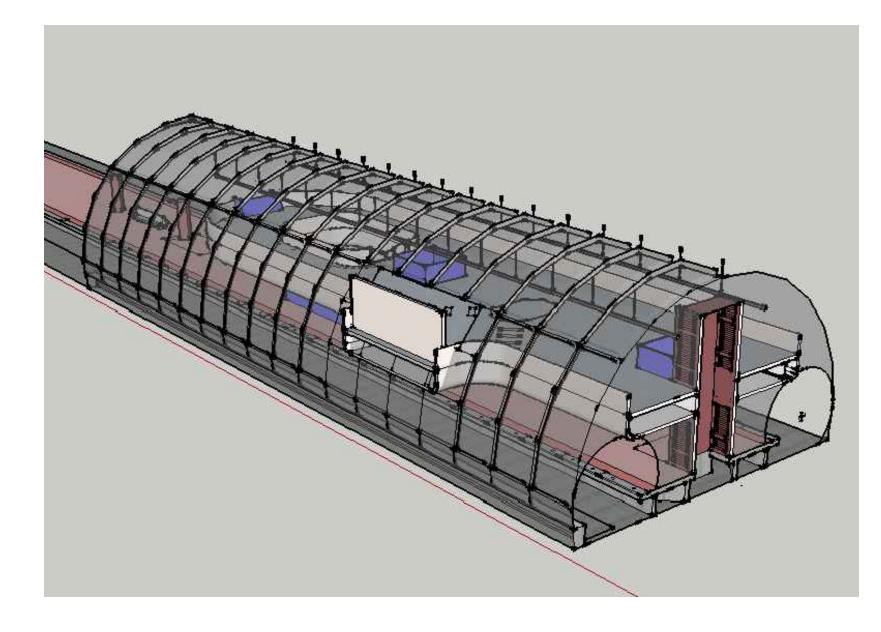


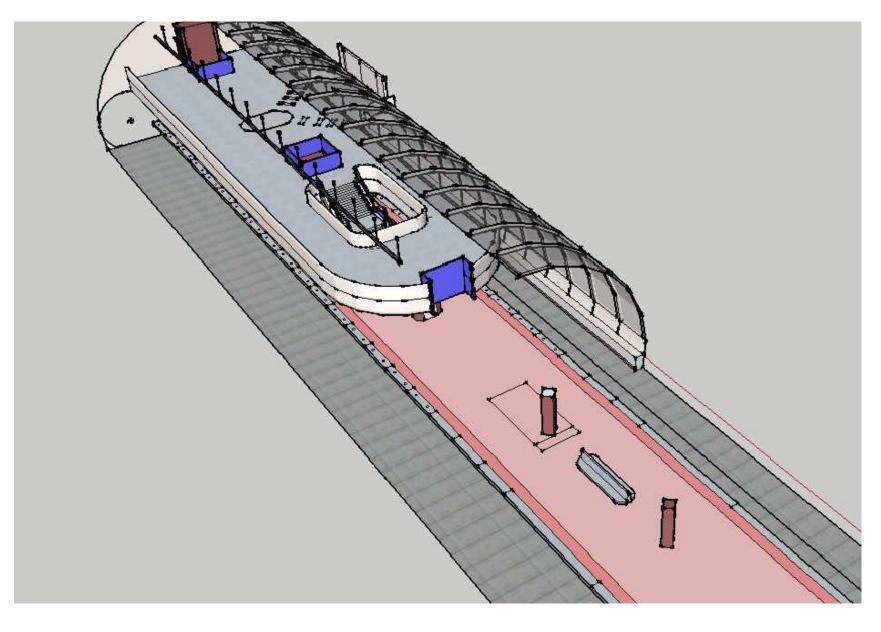








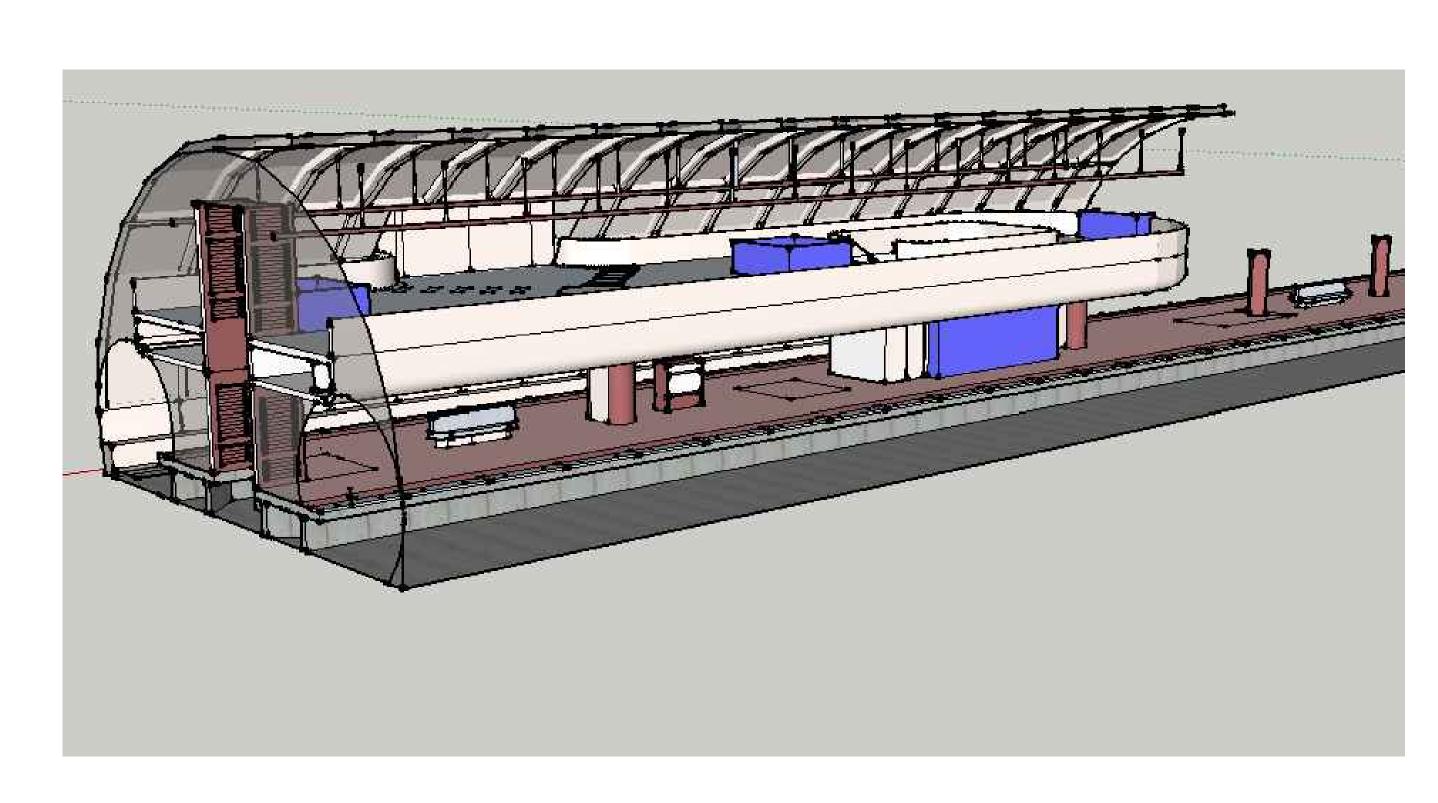

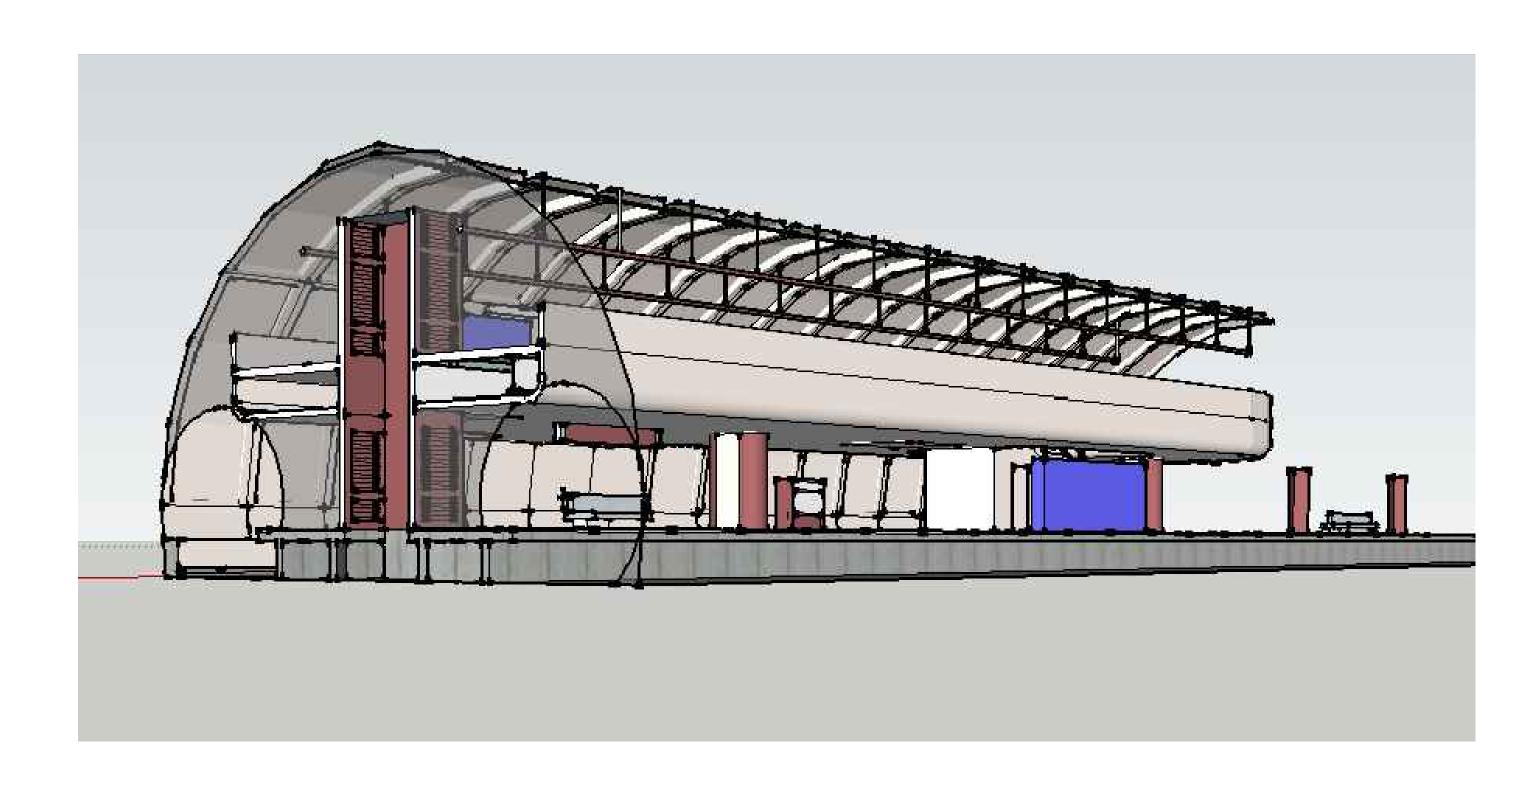

4 VIEW 4 - 1B
A-000 SCALE: NTS

5 VIEW 5 - 1B SCALE: NTS

FINAL FQ15093

WASHINGTON METROPOLITAN AREA TRANSIT AUTHORITY

DEPARTMENT OF TRANSIT INFRASTRUCTURE
AND ENGINEERING SERVICES
OFFICE OF INFRASTRUCTURE RENEWAL PROGRAM
APPROVED

A Gannett Fleming/Parsons
JOINT VENTURE

SUBMITTED PROJECT MANAGER


A Gannett Fleming/Parsons
SCALE
AS SH

RED LINE REHAB.-FRIENDSHIP HEIGHTS TO GROSVENOR - PART 6

PHASE 1B PERSPECTIVE VIEWS


 SCALE
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 AS SHOWN
 A09-A-000
 M1272-189

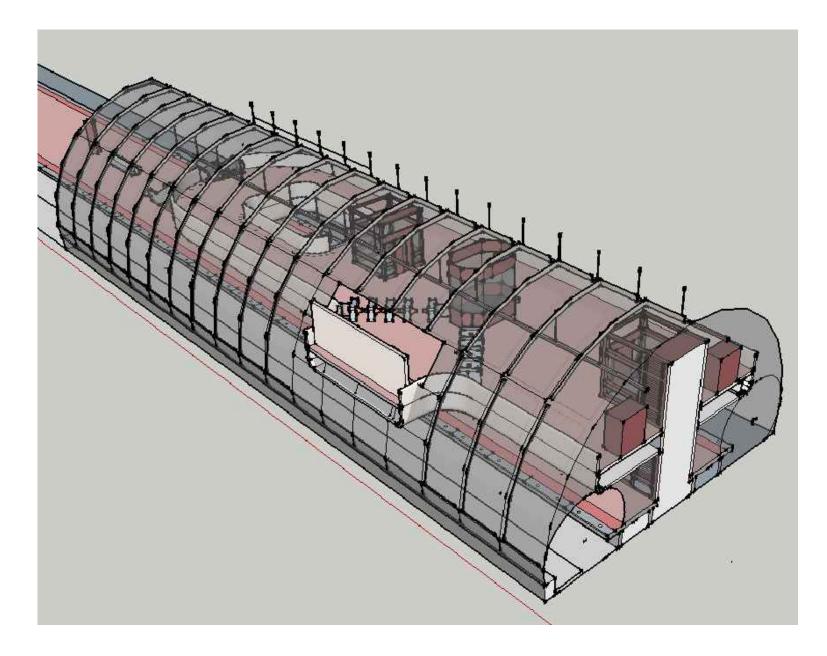

VIEW 1 - FUTURE WORK (NIC)

SCALE: NTS

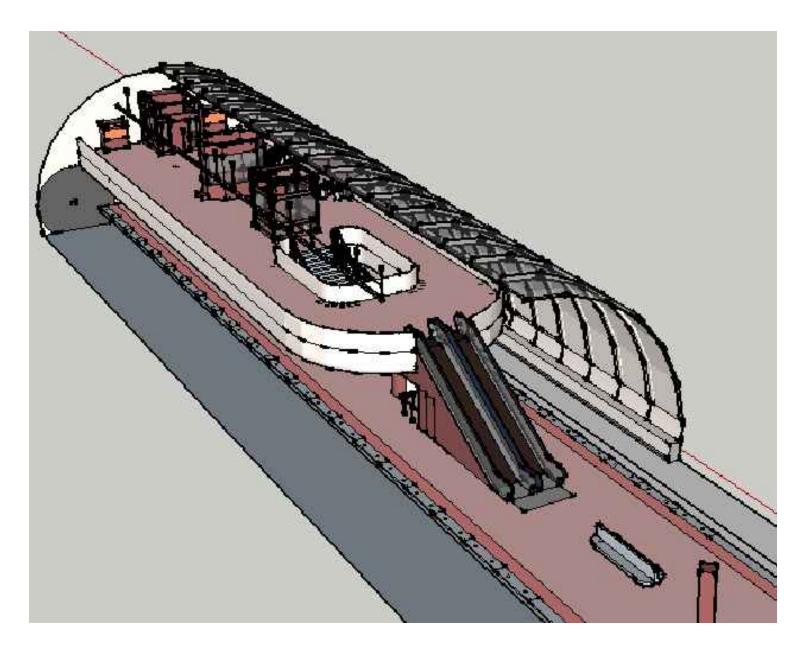


VIEW 2 - FUTURE WORK (NIC)

SCALE: NTS




VIEW 3 - FUTURE WORK (NIC)

SCALE: NTS

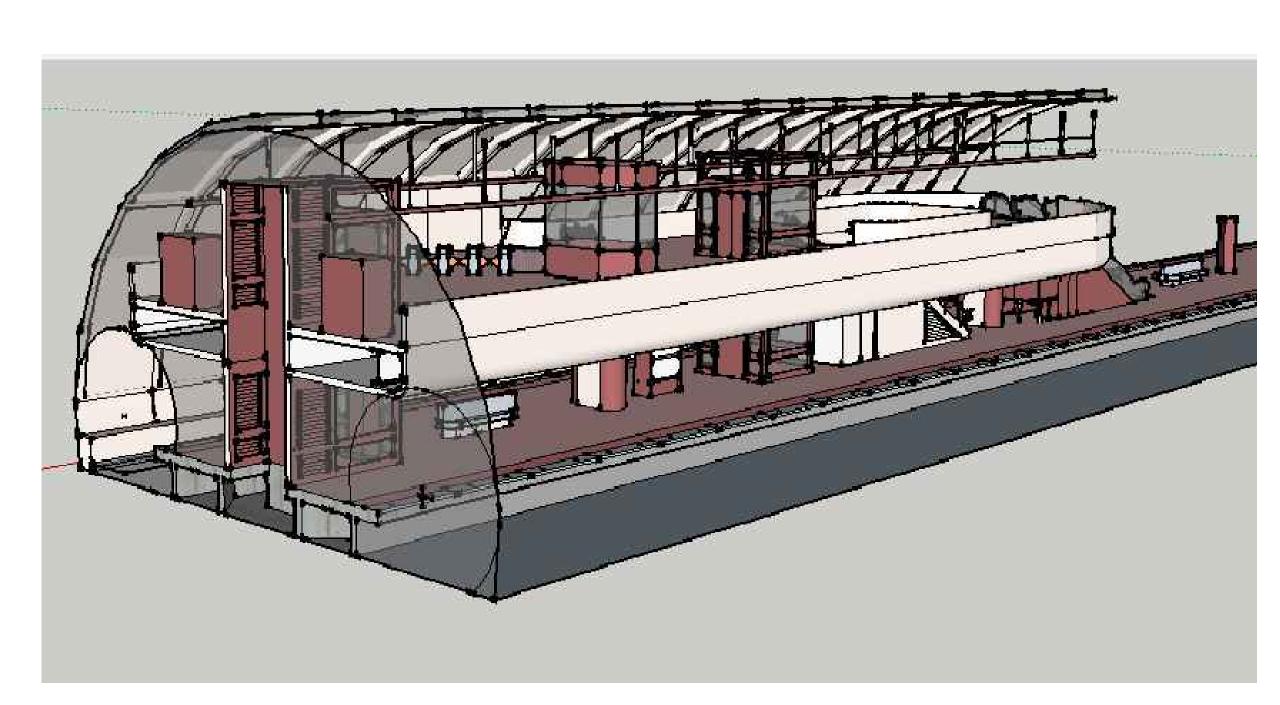



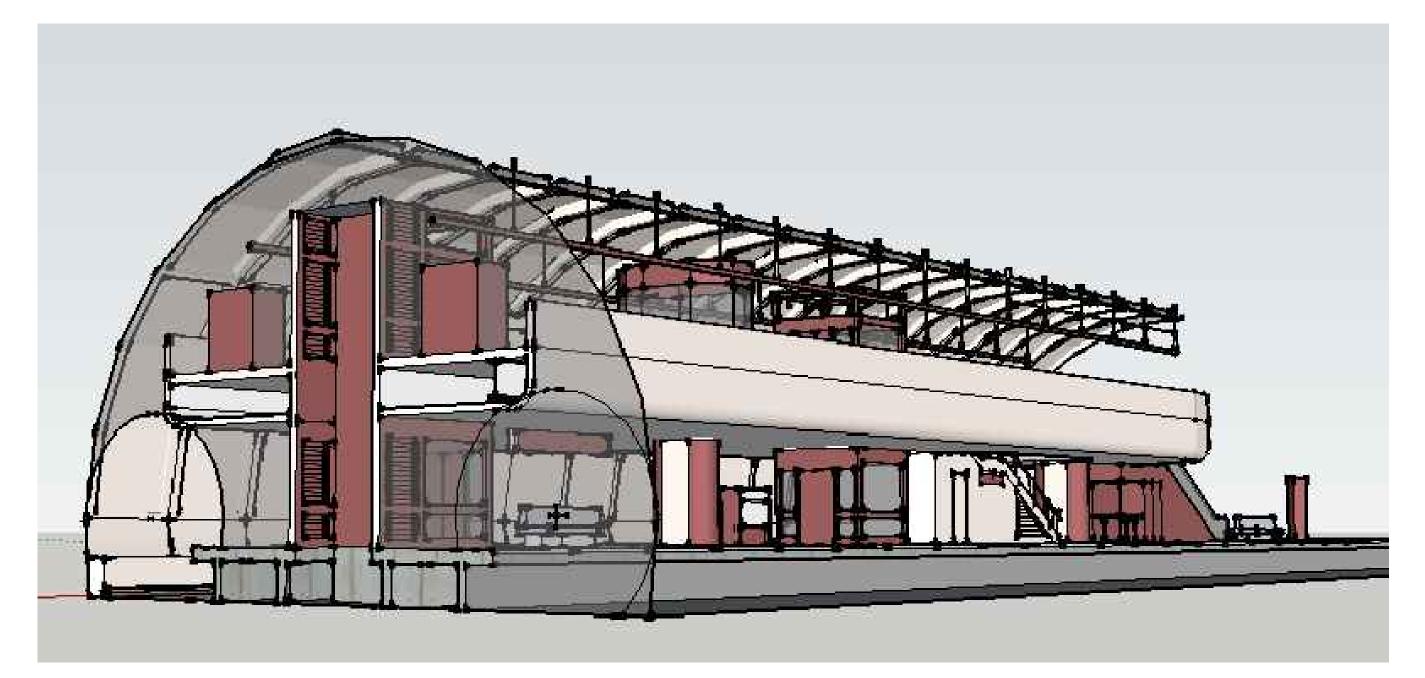

VIEW 5 - FUTURE WORK (NIC)

SCALE: NTS

WASHINGTON METROPOLITAN AREA TRANSIT AUTHORITY

DEPARTMENT OF TRANSIT INFRASTRUCTURE
AND ENGINEERING SERVICES
OFFICE OF INFRASTRUCTURE RENEWAL PROGRAM
APPROVED

A Gannett Fleming/Parsons
JOINT VENTURE

SUBMITTED PROJECT MANAGER


RED LINE REHAB.-FRIENDSHIP HEIGHTS TO GROSVENOR - PART 6

FQ15093

FUTURE WORK (NIC) PERSPECTIVE VIEWS

SCALE DRAWING NO. SHEET NO. M1272-190

					REVISIONS				
DESIGNED	RES	2/20/15 DATE	NUMBER	DESCRIPTION	]	DATE	BY	DESCRIPTION	
DRAWN	RES	2/20/15 DATE							
CHECKED	RES	2/20/15 DATE							
APPROVED	JP	2/20/15 DATE							
		DATE							

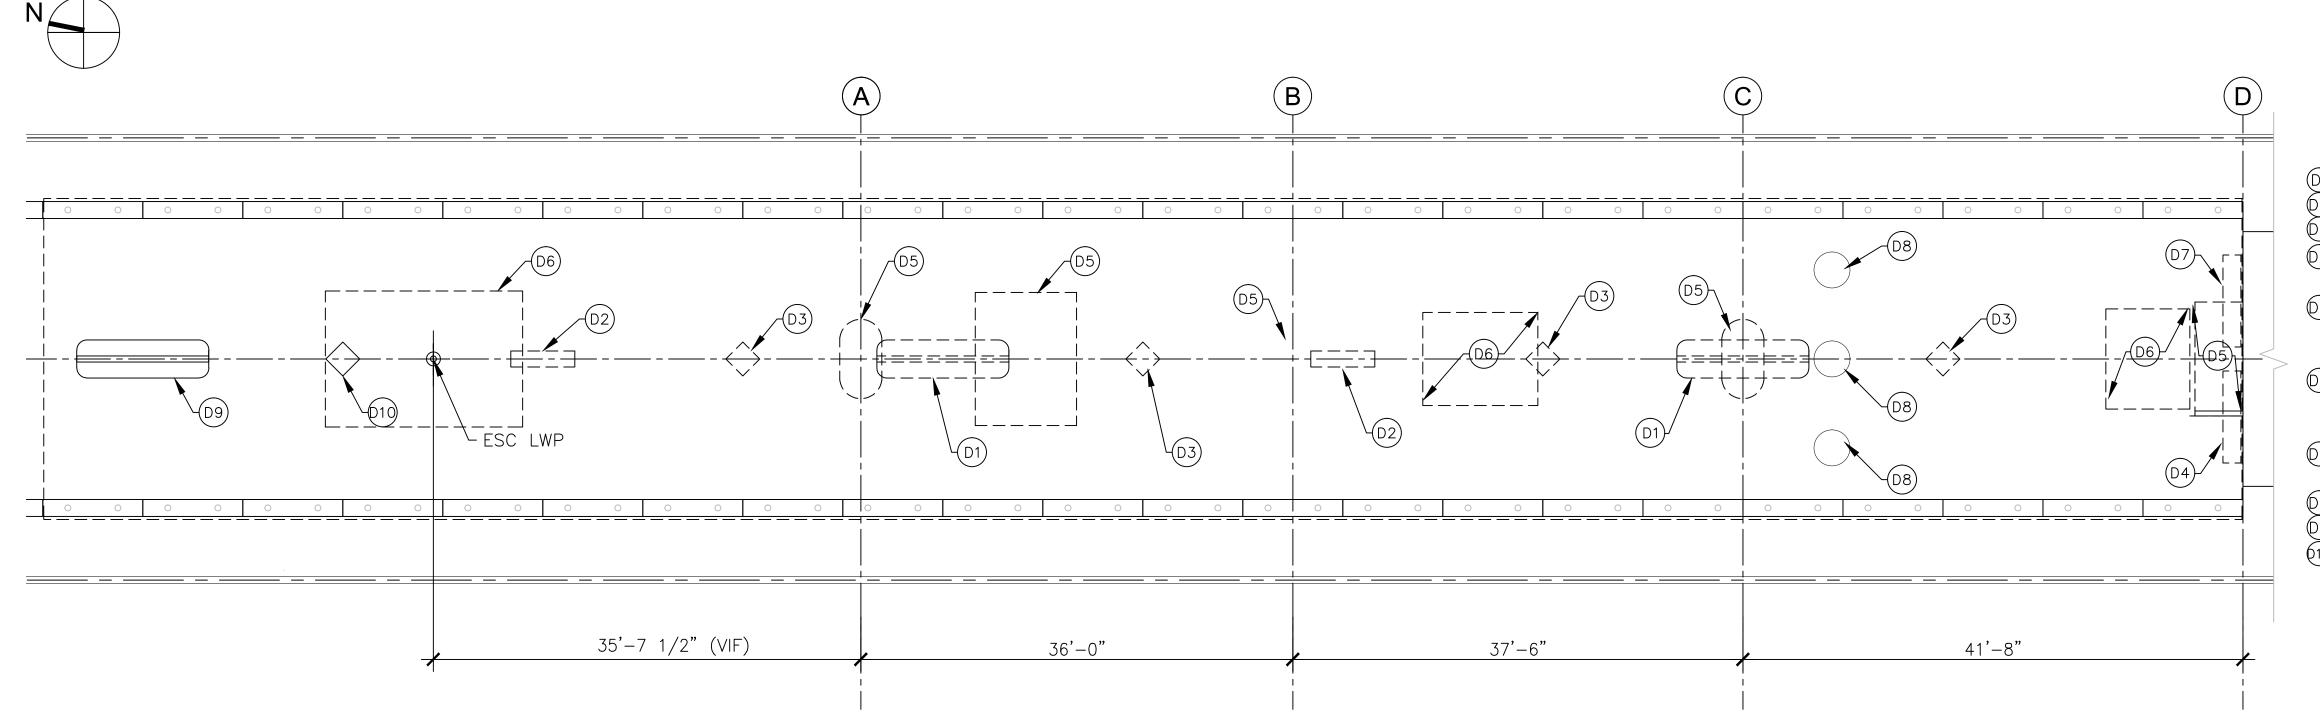

PARTIAL PLATFORM PLAN - DEMOLITION - 1B

SCALE: 1/8" = 1'-0"

# GENERAL DEMOLITION NOTES

- 1. DIMENSIONS BASED ON RECORD DWGS. DESIGN BUILDER SHALL VERIFY EXISTING FIELD CONDITIONS.
- 2. PRIOR TO DEMOLITION, VERIFY MATERIALS AND EQUIPMENT TO BE SALVAGED. STORE WHERE DIRECTED BY WMATA (OWNER). SOME ITEMS MAY BE INCORPORATED INTO NEW WORK.
- 3. VERIFY AND MARK ALL UNDER SLAB UTILITIES PRIOR TO THE START OF WORK.
- 4. REMOVE ALL RUBBISH AND DEMOLITION DEBRIS FROM THE SITE AND DISPOSE OF IN A LAWFUL MANNER.
- 5. COORDINATE GENERAL CONSTRUCTION DEMOLITION W/ THE WORK OF OTHER TRADES.
- 6. REPAIR ALL EXIST STRUCTURES, UTILITIES, AND EQUIPMENT, SCHEDULED TO REMAIN, WHICH ARE DAMAGED DURING DEMOLITION OPERATIONS. ALL WORK SCHEDULED TO BE DEMOLISHED, WILL BE REMOVED COMPLETELY INCLUDING ALL FASTENERS, ATTACHMENTS, ACCESSORIES, OR ANY RELATED WORK.

- 7. DEMOLITION OF CONC SLABS IS SHOWN ON THE DEMOLITION PLAN AS IT RELATES TO DEMOLITION FOR OTHER TRADES SUCH AS STRUCT FOUNDATIONS. SEE ELECT AND STRUCT DOCUMENTS FOR RELATED DEMOLITION WORK.
- 8. DEMOLITION INCLUDES ALL ITEMS WHETHER OR NOT SHOWN ON THE DWGS, THAT ARE REQUIRED TO BE REMOVED IN ORDER TO INSTALL THE NEW WORK SHOWN ON DRAWING A-102, A-103 AND OTHER PORTIONS OF THE CONTRACT DOCUMENTS.
- 9. ALL SURFACES TO REMAIN SHALL BE REFINISHED TO REPAIR ALL HOLES, SCRATCHES, DENTS, MARS, PITTING, ADHESIVE, BAD JOINTS, DEFECTIVE CMU, ETC. TO BE ACCEPTABLE IN EVERY WAY TO RECEIVE NEW FINISHES.
- 10. DESIGN BUILDER WILL COORDINATE LOCATIONS OF ALL UTILITIES IN PLENUM AREA BELOW PLATFORM AND VERIFY THAT ALL WORK IS COORDINATED.
- 11. DESIGN BUILDER IS RESPONSIBLE FOR ALL EQUIPMENT, FURNISHING AND SIGNAGE WHETHER SHOWN OR NOT. DESIGN BUILDER SHALL COORDINATE, REMOVE, PROTECT AND REINSTALL ALL EQUIPMENT, FURNISHING AND SIGNAGE AS REQUIRED TO PROVIDE FOR FUNCTIONAL OPERATIONS BY WMATA.

APPROVED

#### DEMOLITION NOTES FOR 1B

- (D1) REMOVE AND STORE EXISTING BENCH FOR SALVAGE OR RE-USE.
- (D2) REMOVE AND STORE EXISTING DIORAMA FOR SALVAGE OR RE-USE (D3) REMOVE PYLONS.
- REMOVE AND RELOCATE ETEC CABINETS TO TEMPORARY AND FINAL LOCATIONS AS DIRECTED BY THE AUTHORITY.
- ©5 REMOVE EXISTING SLAB AS REQUIRED TO FACILITATE INSTALLATION OF PROPOSED COLUMNS, STAIRS AND MECH SHAFT. SEE STRUCT, MECH AND ELECT WORK.
- ©6) REMOVE EXISTING SLAB AS REQUIRED TO FACILITATE INSTALLATION OF KNOCK-OUT PANEL FOR PROPOSED ESCALATOR AND ELEVATORS. SEE ELECT & STRUCT WORK.
- (D) REMOVE & RELOCATE CWS CABINET TO TEMPORARY AND FINAL LOCATION AS DIRECTED BY THE AUTHORITY.
- (D8) EXIST MANHOLE COVER TO REMAIN
- (09) EXIST BENCH TO REMAIN
- (10) EXIST PYLON TO REMAIN

#### WORK ZONE NOTES

1. DESIGN BUILDER SHALL PERFORM THEIR WORK IN A MATTER THAT ALLOWS FOR FULL USE OF THE STATION DURING PERIODS OTHER THAN AGREED TO STATION CLOSURES AS SCHEDULED.

## <u>ABBREVIATIONS</u>

**EXIST EXISTING** W/ STRUCT STRUCTURAL ARCH ARCHITECTURAL ELECT ELECTRICAL MECH MECHANICAL DWGS DRAWINGS CONCRETE CONC SYSTEM SYS TYP TYPICAL MEZZ MEZZANINE ELEVATOR ELEV **ESCALATOR** ESC COORD COORDINATE LOWER WORKING POINT LWP UWP UPPER WORKING POINT VIF VERIFY IN FIELD

FINAL

FQ15093

# WASHINGTON METROPOLITAN AREA TRANSIT AUTHORITY

DEPARTMENT OF TRANSIT INFRASTRUCTURE
AND ENGINEERING SERVICES
OFFICE OF INFRASTRUCTURE RENEWAL PROGRAM

NORTH

PLATFORM

SOUTH

**PLATFORM** 

14//4/4///

KEY PLAN




PROJECT MANAGER

RED LINE REHAB.-FRIENDSHIP HEIGHTS TO GROSVENOR - PART 6

PHASE 1B PLATFORM DEMOLITION PLAN

 SCALE
 DRAWING NO.
 SHEET NO.

 AS SHOWN
 A09-A-100
 M1272-191

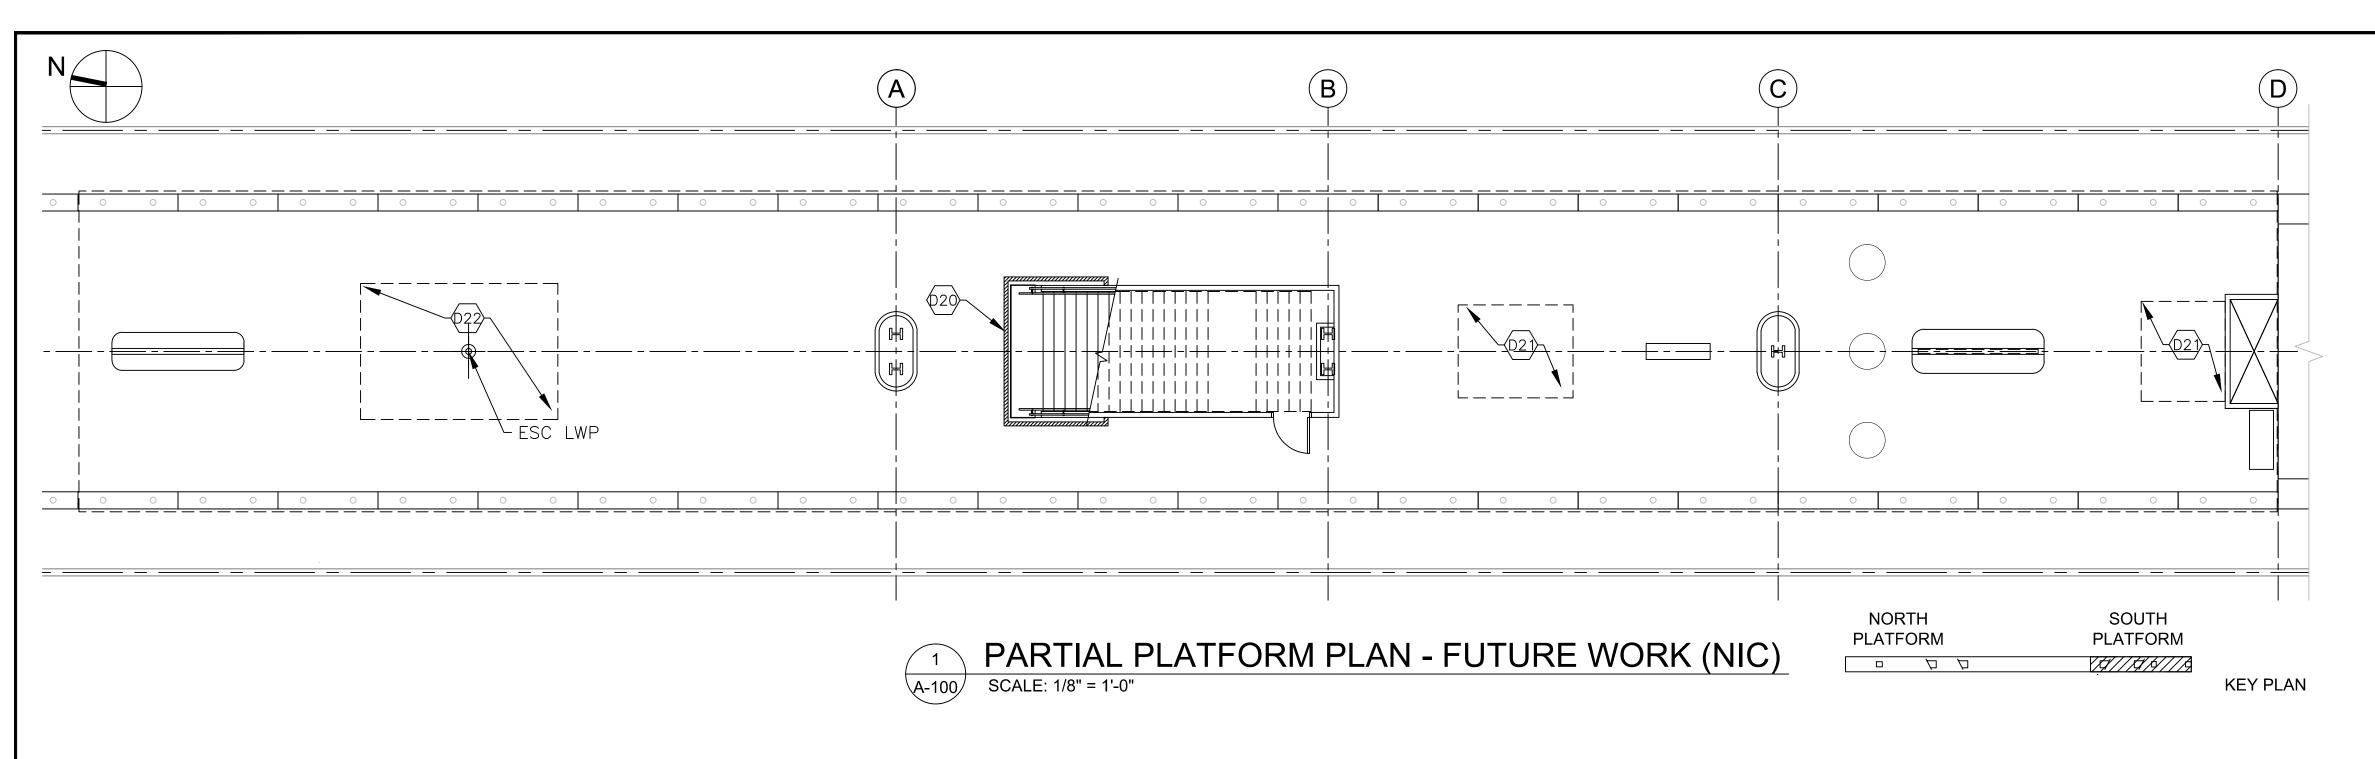

#### DEMOLITION NOTES FOR 2


- REMOVE PROTECTION BARRIERS FOR INITIATION OF REVENUE SERVICE
- (D2) REMOVE KNOCKOUT PANEL AND PREPARE SURFACE FOR ELEVATOR
- \$\phi^2\rightarrou\right\right\right\right\right\right\right\right\right\right

#### WORK ZONE NOTES

1. DESIGN BUILDER SHALL PERFORM THEIR WORK IN A MATTER THAT ALLOWS FOR FULL USE OF THE STATION DURING PERIODS OTHER THAN AGREED TO STATION CLOSURES AS SCHEDULED.

#### **ABBREVIATIONS**

EXISTING WITH STRUCTURAL ARCHITECTURAL ELECTRICAL MECHANICAL DRAWINGS CONCRETE SYS SYSTEM TYP TYPICAL MEZZ MEZZANINE ELEV ELEVATOR ESC **ESCALATOR** COORD COORDINATE LWP LOWER WORKING POINT UWP UPPER WORKING POINT VERIFY IN FIELD

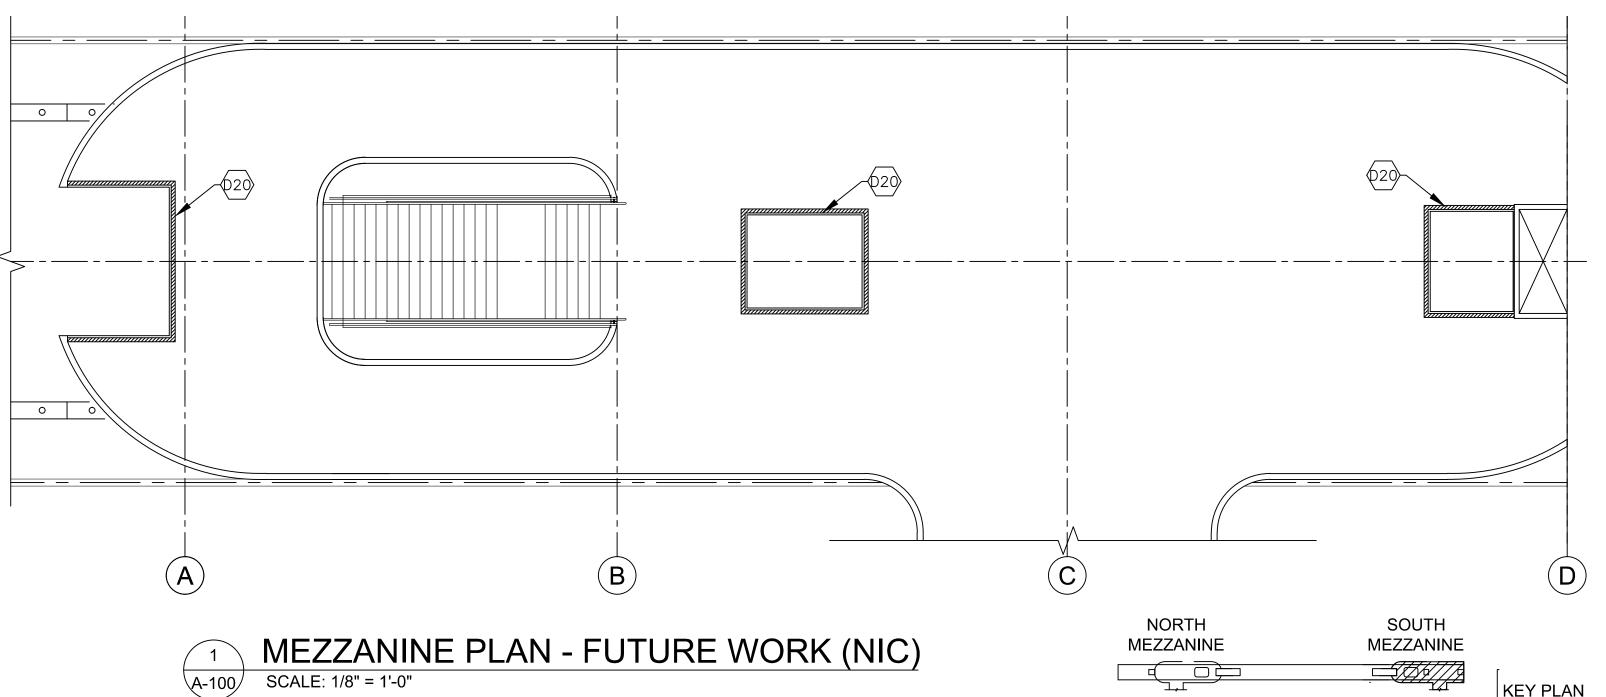

# GENERAL DEMOLITION NOTES

- 1. DIMENSIONS BASED ON RECORD DWGS. DESIGN BUILDER SHALL VERIFY EXISTING FIELD CONDITIONS.
- 2. PRIOR TO DEMOLITION, VERIFY MATERIALS AND EQUIPMENT TO BE SALVAGED. STORE WHERE 7. DIRECTED BY WMATA (OWNER). SOME ITEMS MAY BE INCORPORATED INTO NEW WORK.
- 3. VERIFY AND MARK ALL UNDER SLAB UTILITIES PRIOR TO THE START OF WORK.
- 4. REMOVE ALL RUBBISH AND DEMOLITION DEBRIS FROM THE SITE AND DISPOSE OF IN A LAWFUL MANNER.

- 5. COORDINATE GENERAL CONSTRUCTION DEMOLITION W/ THE WORK OF OTHER TRADES.
- 6. REPAIR ALL EXIST STRUCTURES, UTILITIES, AND EQUIPMENT, SCHEDULED TO REMAIN, WHICH ARE DAMAGED DURING DEMOLITION OPERATIONS. ALL WORK SCHEDULED TO BE DEMOLISHED, WILL BE REMOVED COMPLETELY INCLUDING ALL FASTENERS, ATTACHMENTS, ACCESSORIES, OR ANY RELATED WORK.
- 7. DEMOLITION OF CONC SLABS IS SHOWN ON THE DEMOLITION PLAN AS IT RELATES TO DEMOLITION FOR OTHER TRADES SUCH AS STRUCT FOUNDATIONS. SEE ELECT AND STRUCT DOCUMENTS FOR RELATED DEMOLITION WORK.
- 8. DEMOLITION INCLUDES ALL ITEMS WHETHER OR NOT SHOWN ON THE DWGS, THAT ARE REQUIRED TO BE REMOVED IN ORDER TO INSTALL THE NEW WORK SHOWN ON DRAWING A-102, A-103 AND OTHER PORTIONS OF THE CONTRACT DOCUMENTS.
- 9. ALL SURFACES TO REMAIN SHALL BE REFINISHED TO REPAIR ALL HOLES, SCRATCHES, DENTS, MARS, PITTING, ADHESIVE, BAD JOINTS, DEFECTIVE CMU, ETC. TO BE ACCEPTABLE IN EVERY WAY TO RECEIVE NEW FINISHES.
- 10. DESIGN BUILDER WILL COORDINATE LOCATIONS OF ALL UTILITIES IN PLENUM AREA BELOW PLATFORM AND VERIFY THAT ALL WORK IS COORDINATED.
- 11. DESIGN BUILDER IS RESPONSIBLE FOR ALL EQUIPMENT, FURNISHING AND SIGNAGE WHETHER SHOWN OR NOT. DESIGN BUILDER SHALL COORDINATE, REMOVE, PROTECT AND REINSTALL ALL EQUIPMENT, FURNISHING AND SIGNAGE AS REQUIRED TO PROVIDE FOR FUNCTIONAL OPERATIONS BY WMATA.

FINAL

FQ15093

		RE	EFERENCE DRAWINGS		REVISIONS				
DESIGNED AD	<u>2/20/15</u> DATE	NUMBER	DESCRIPTION	DA	E B	Y DESCRIPTION			
DRAWN AD	<u>2/20/15</u> DATE								
CHECKED RES	<u>2/20/15</u> DATE								
APPROVED JP	2/20/15 DATE								

WASHINGTON METROPOLITAN AREA TRANSIT AUTHORITY

DEPARTMENT OF TRANSIT INFRASTRUCTURE
AND ENGINEERING SERVICES
OFFICE OF INFRASTRUCTURE RENEWAL PROGRAM
APPROVED



PROJECT MANAGER


RED LINE REHAB.-FRIENDSHIP HEIGHTS TO GROSVENOR - PART 6


FUTURE WORK (NIC)


PLATFORM DEMOLITION PLAN

 SCALE
 DRAWING NO.
 SHEET NO.

 AS SHOWN
 A09-A-101
 M1272-192

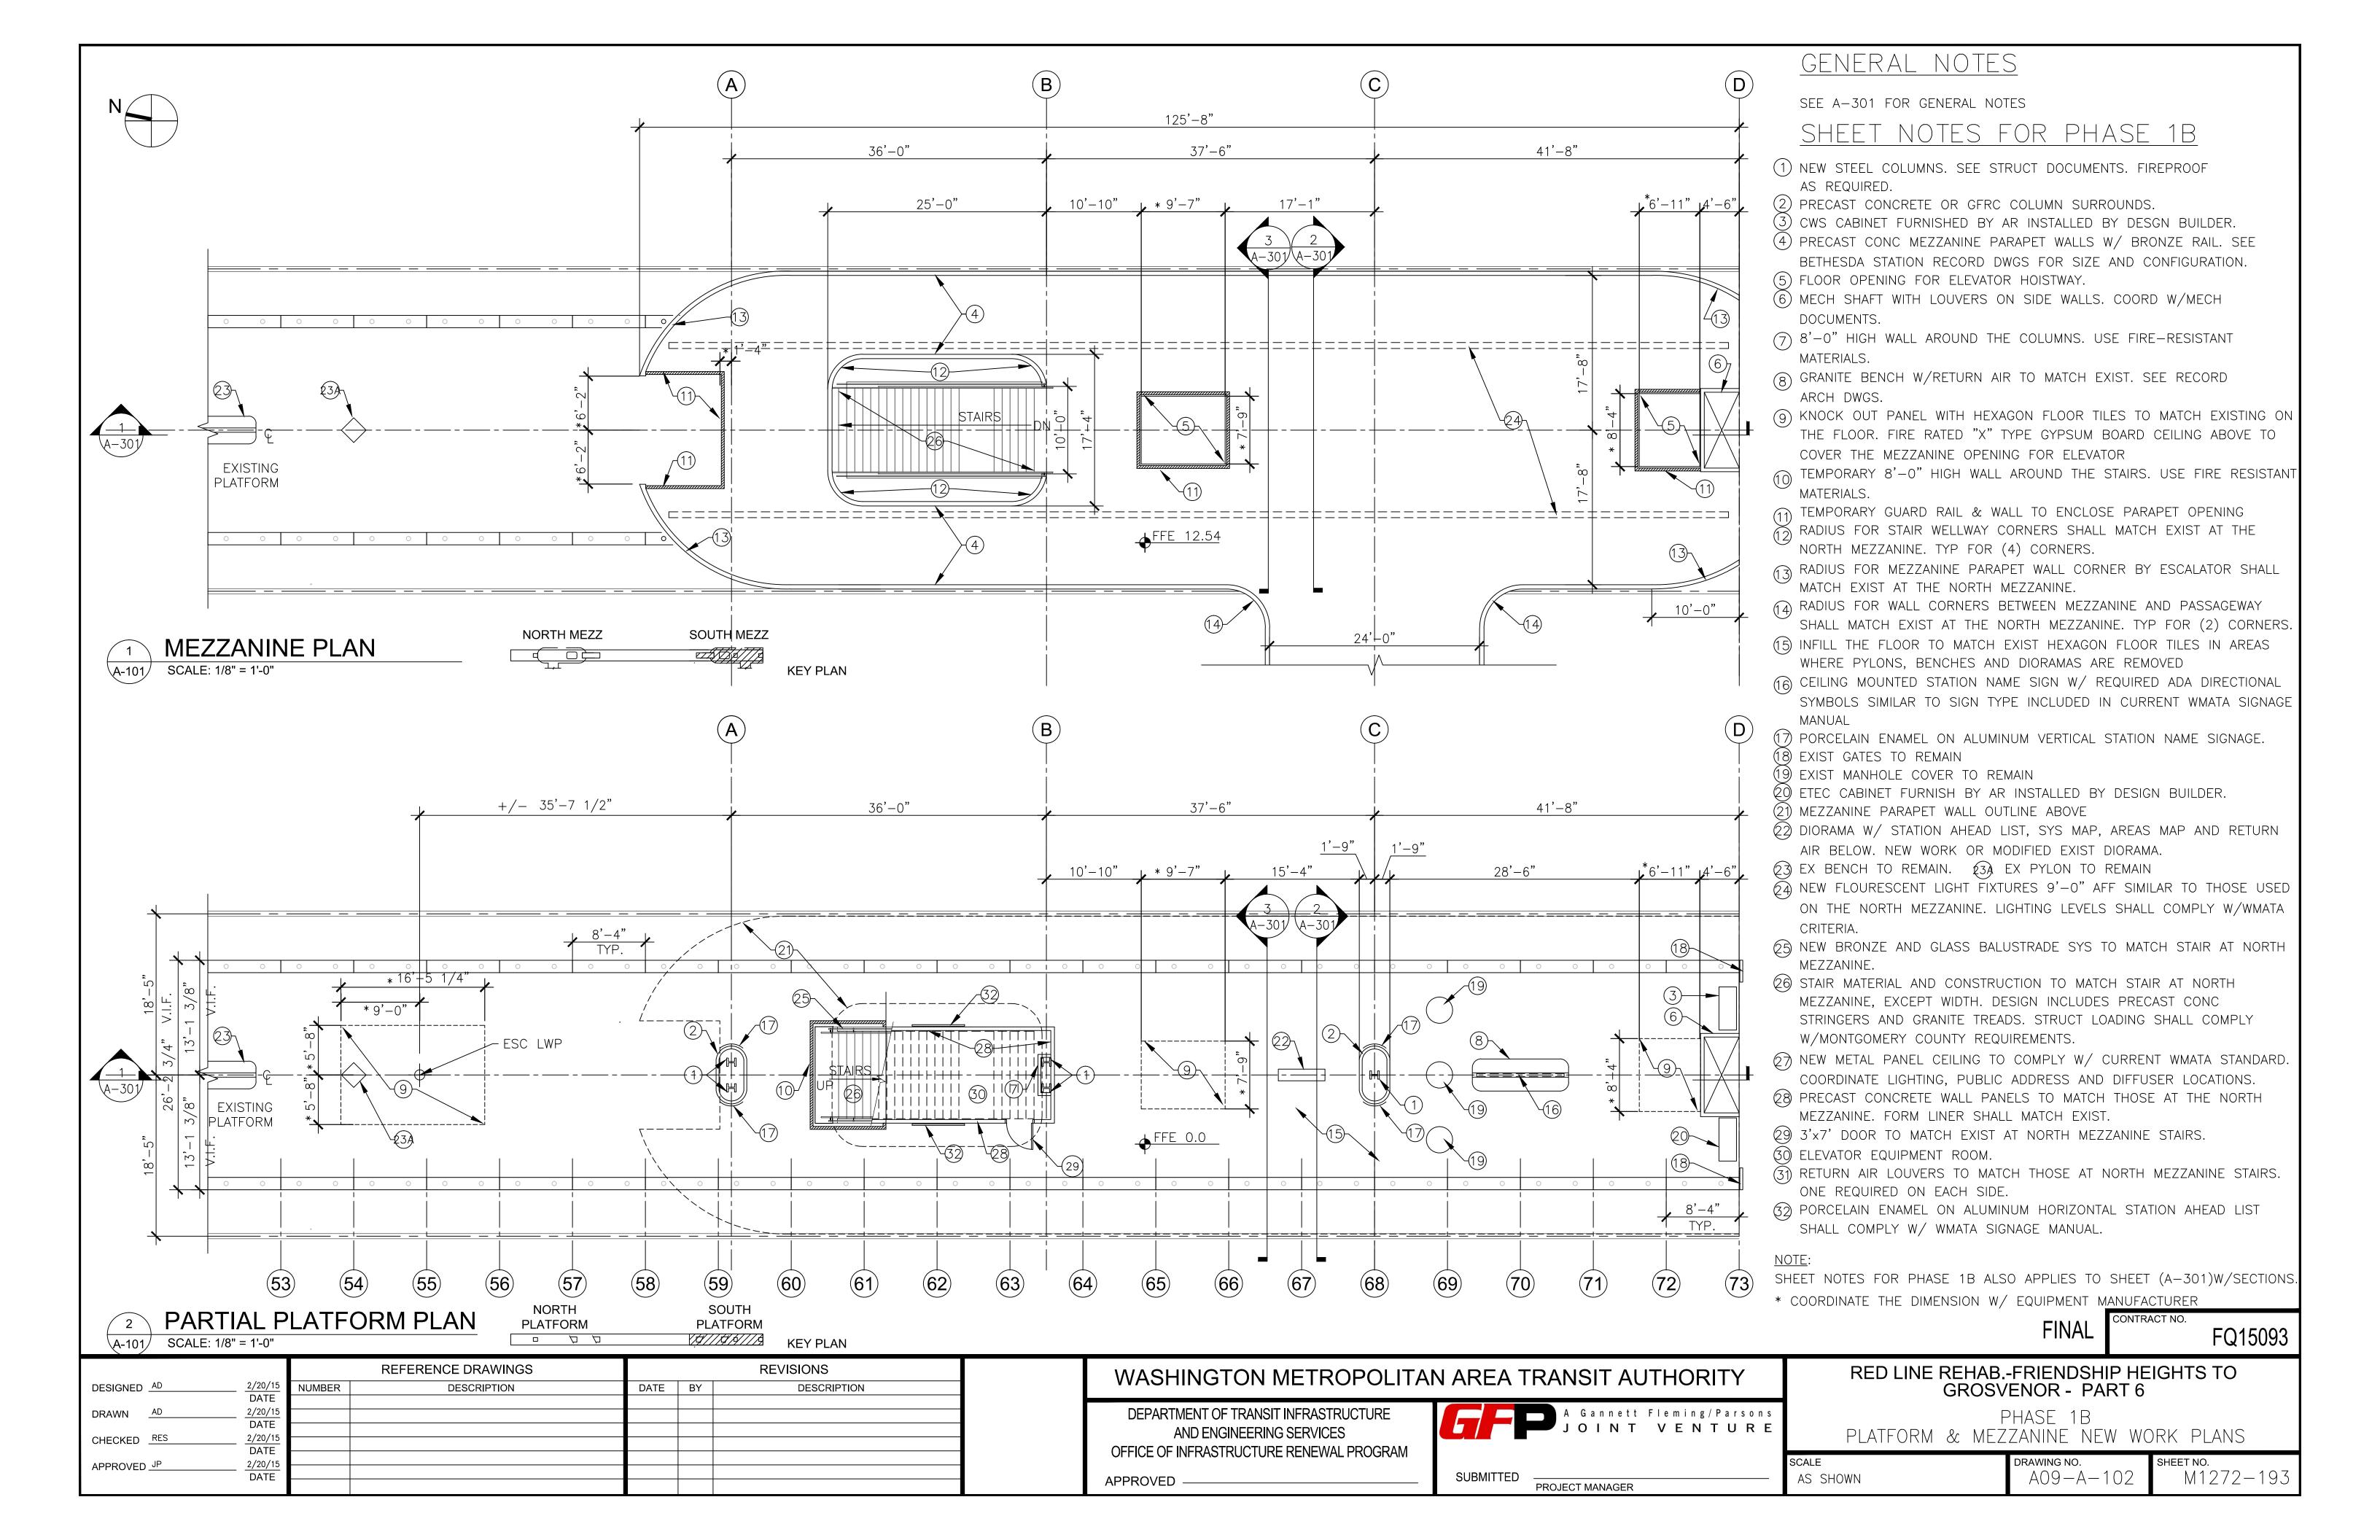

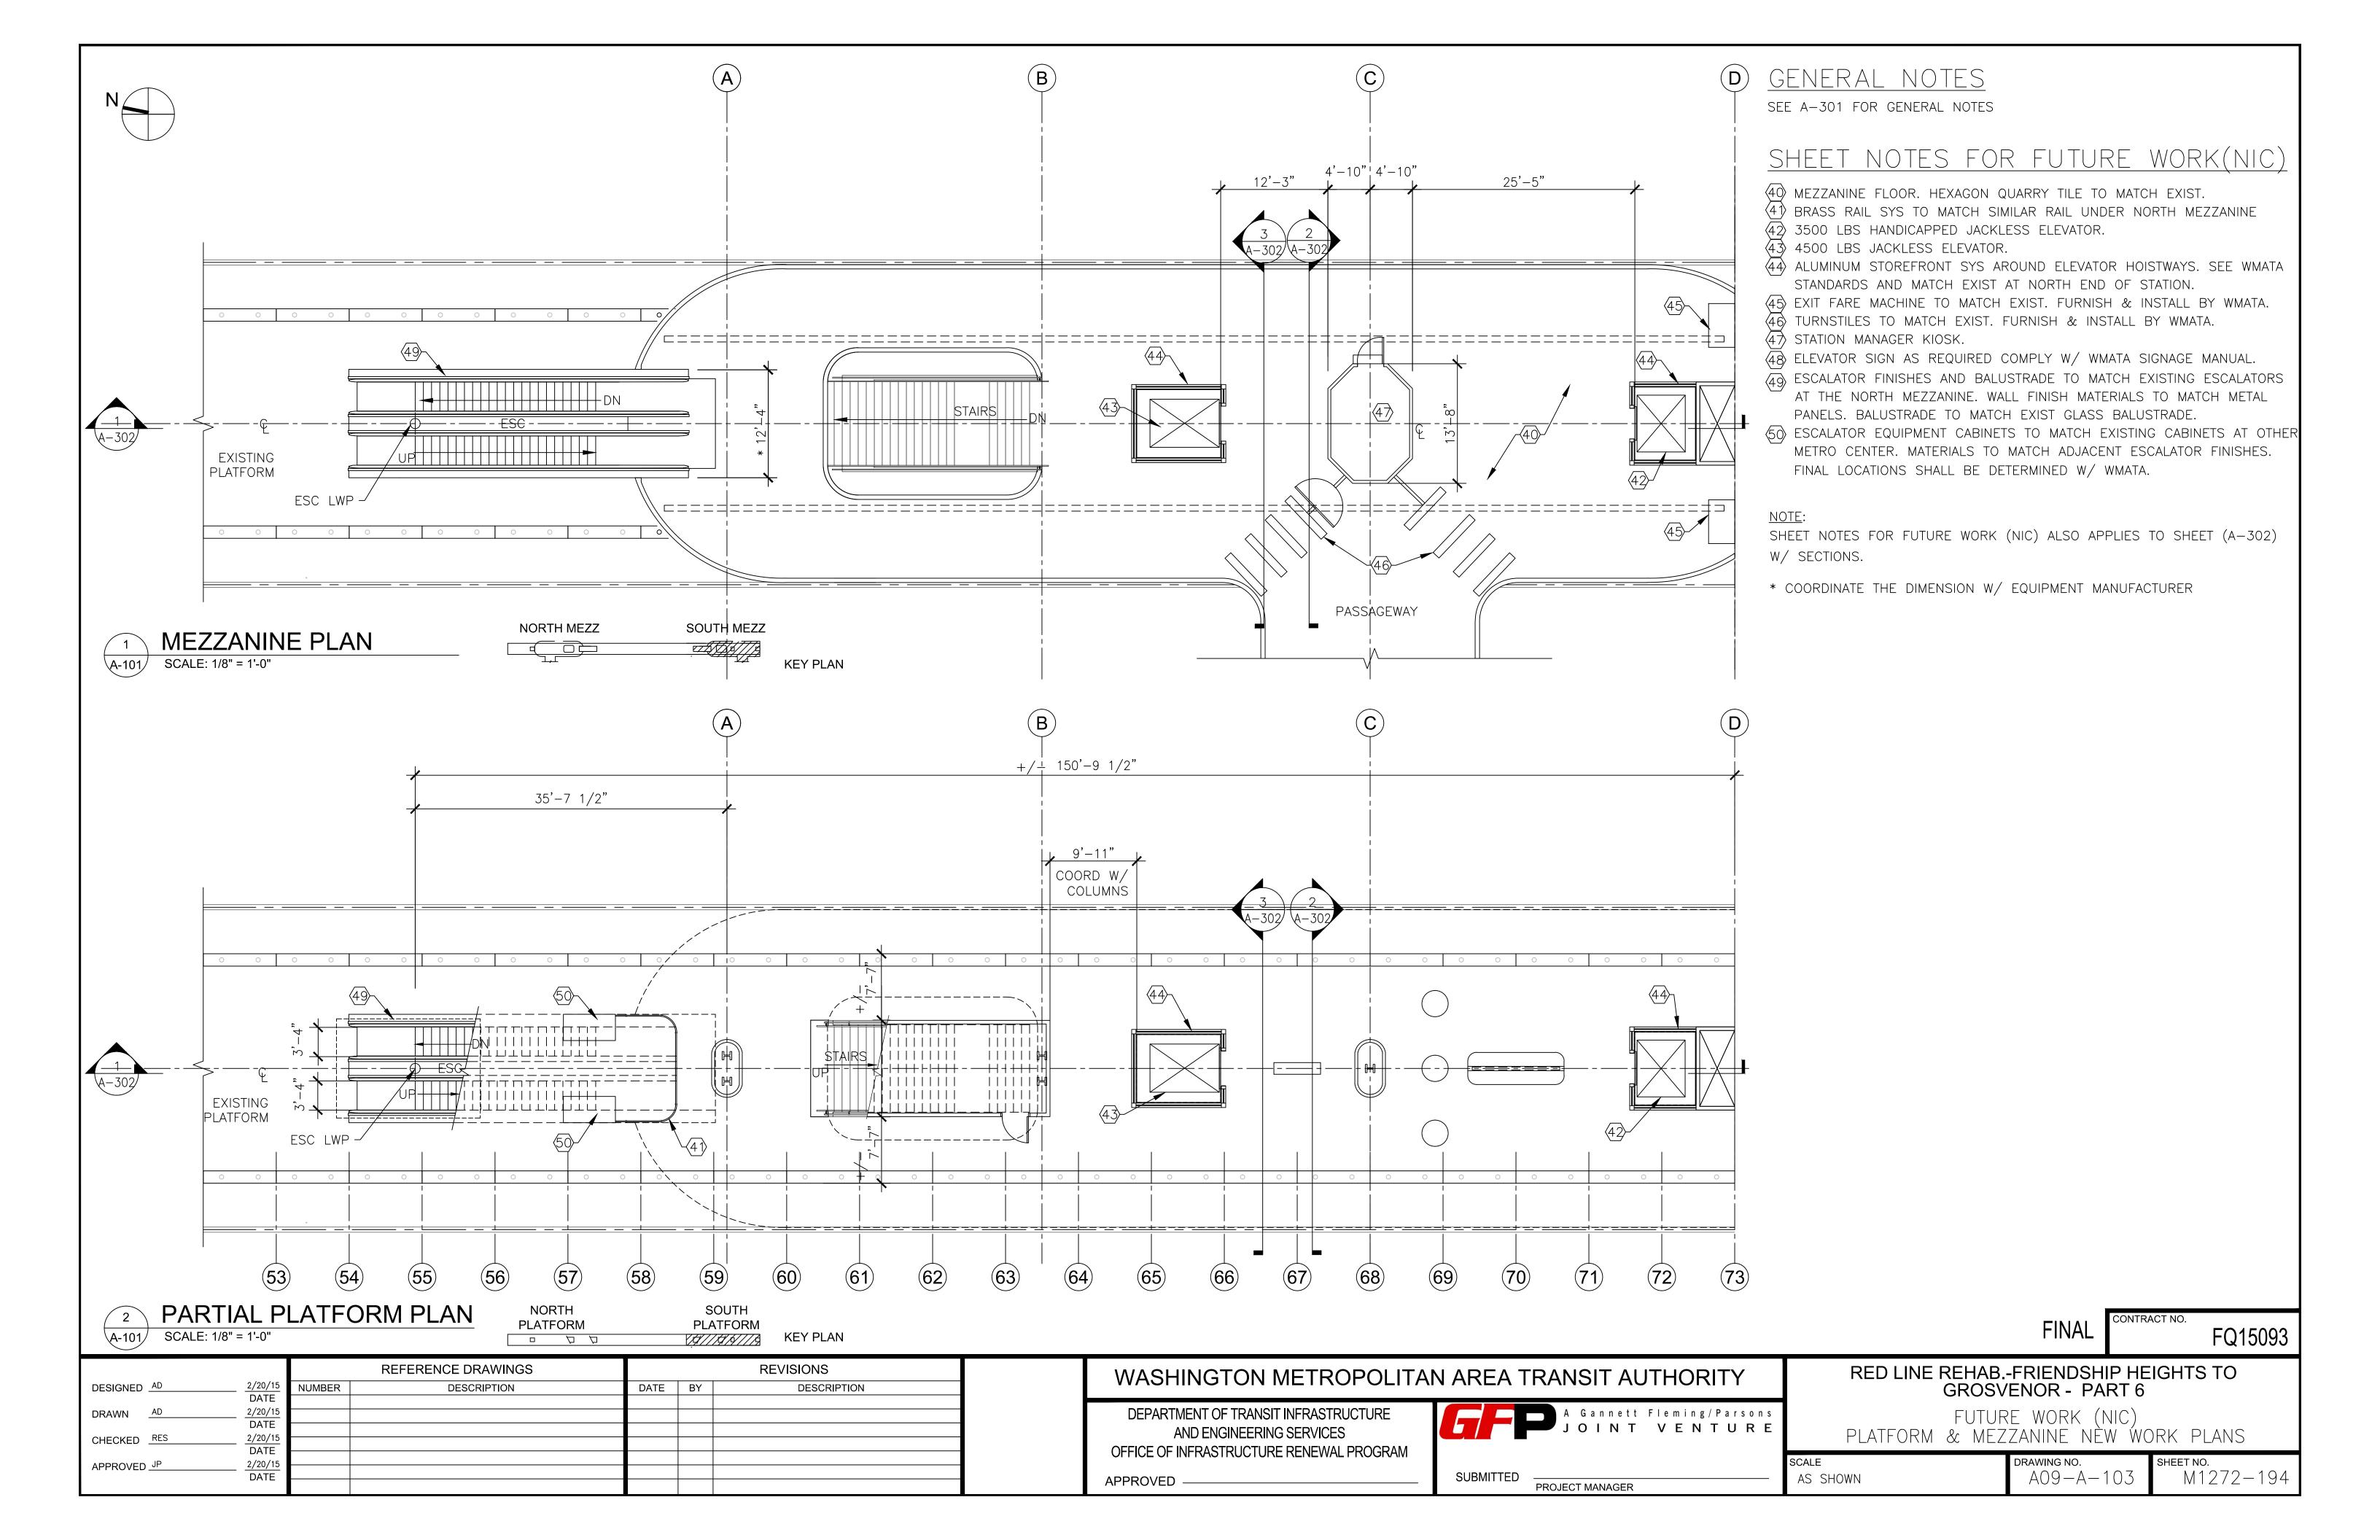


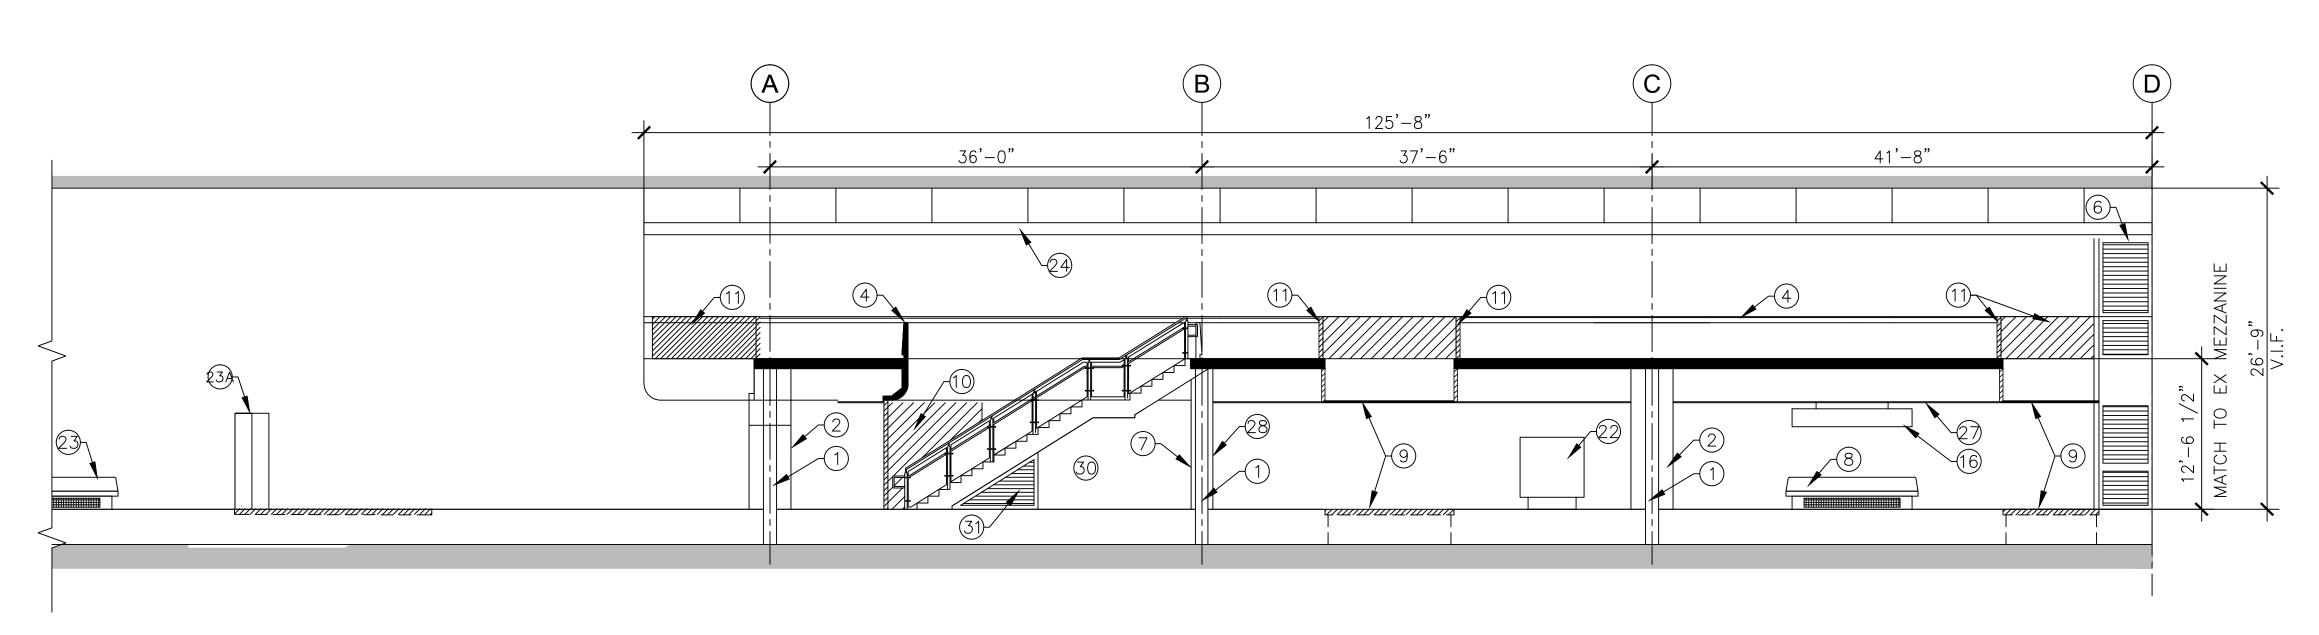


# 1 LONGITUDINAL SECTION - PHASE 1B A-301 SCALE: 1/8" = 1'-0"

#### GENERAL NOTES

- 1. VERIFY ALL DIMENSIONS IN THE FIELD.
- 2. VERIFY ALL FIELD CONDITIONS.
- 3. ALL DIMENSIONS ARE NOMINAL UNLESS NOTED OTHERWISE.
- 4. ALL WORK WILL BE COMPLETED IN ACCORDANCE WITH THE LATEST VERSIONS OF I.B.C. AND LIFE SAFETY CODES. ALL WORK IS DESIGNED AND SHALL BE CONSTRUCTED IN ACCORDANCE W/ WMATA DESIGN CRITERIA, VERSION 9.
- 5. DO NOT SCALE DWGS FOR PURPOSES OF FINAL DESIGN
- 6. DEMOLITION, CUTTING, AND PATCHING OF ANY MATERIALS OR FIXTURES REQUIRED TO CONSTRUCT THE PROJECT IS HEREIN MADE A PART OF THESE DOCUMENTS.
- 7. THE CONTRACTOR SHALL SECURE AND PAY FOR ALL PERMITS AS REQUIRED.
- 8. THE IMAGES ON THE CONSTRUCTION DOCUMENT FLOOR PLANS REFLECT THE INFORMATION FROM THE ORIGINAL CONSTRUCTION DOCUMENTS FOR THE PROJECT, IT IS NOT AN INDICATION OF NEW WORK, IT IS SHOWN IN GRAY LINE COLOR. THE NEW WORK AND REQUIRED DEMOLITION OR REMOVALS ARE SHOWN IN BLACK LINE COLOR. IF THE DIFFERENCE IS NOT OBVIOUS, REPORT TO THE A.R. IMMEDIATELY.
- 9. ALL WORK INDICATED OR SHOWN GRAPHICALLY AS "EXIST (EXISTING) TO REMAIN" WILL BE THE CONTRACTOR'S RESPONSIBILITY TO PROTECT AND WORK AROUND WITHOUT DISTURBING. IF DAMAGED, THE CONTRACTOR WILL REPLACE AT NO ADDITIONAL COST TO THE OWNER.
- 10. FIREPROOF ALL NEW STRUCT STEEL, INCLUDING, BUT NOT LIMITED TO COLUMNS, BEAMS, METAL DECK, AND MISCELLANEOUS METALS SEE SPECIFICATION SECTION 07.81.00.
- 11. FORMWORK FOR PRECAST CONCRETE TO MATCH FORMWORK USED AT THE NORTH MEZZANINE STAIR.

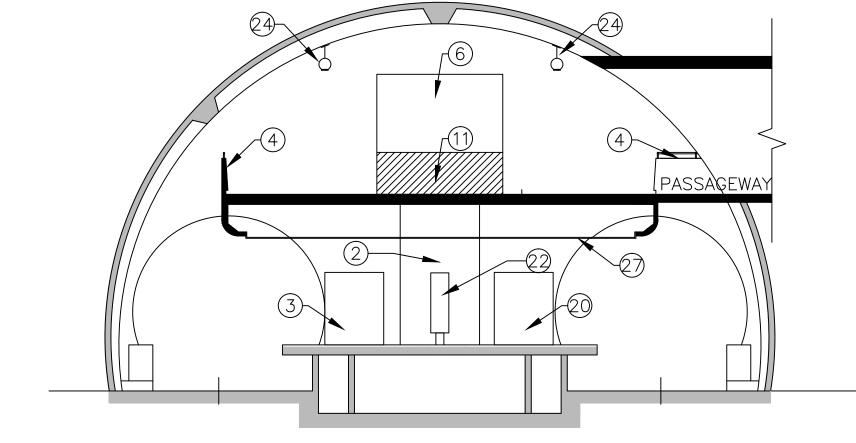

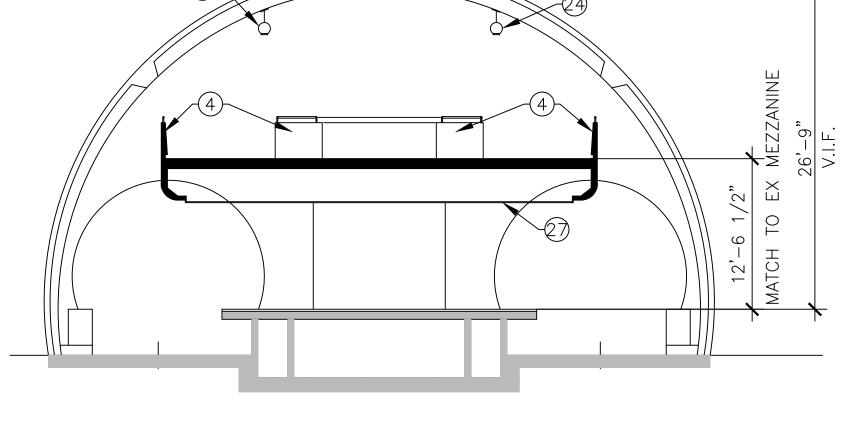

A-301

TRANSVERSE SECTION - PHASE 1B

SCALE: 1/8" = 1'-0"

TRANSVERSE SECTION - PHASE 1B

SCALE: 1/8" = 1'-0"

## SHEET NOTES

SEE A-102 FOR "SHEET NOTES FOR PHASE 1B" (X)

WASHINGTON METROPOLITAN AREA TRANSIT AUTHORITY

DEPARTMENT OF TRANSIT INFRASTRUCTURE
AND ENGINEERING SERVICES
OFFICE OF INFRASTRUCTURE RENEWAL PROGRAM
APPROVED




RED LINE REHAB.-FRIENDSHIP HEIGHTS TO GROSVENOR - PART 6

FQ15093

PHASE 1B SECTIONS

 SCALE
 DRAWING NO.
 SHEET NO.


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 A09-A-301
 M1272-195

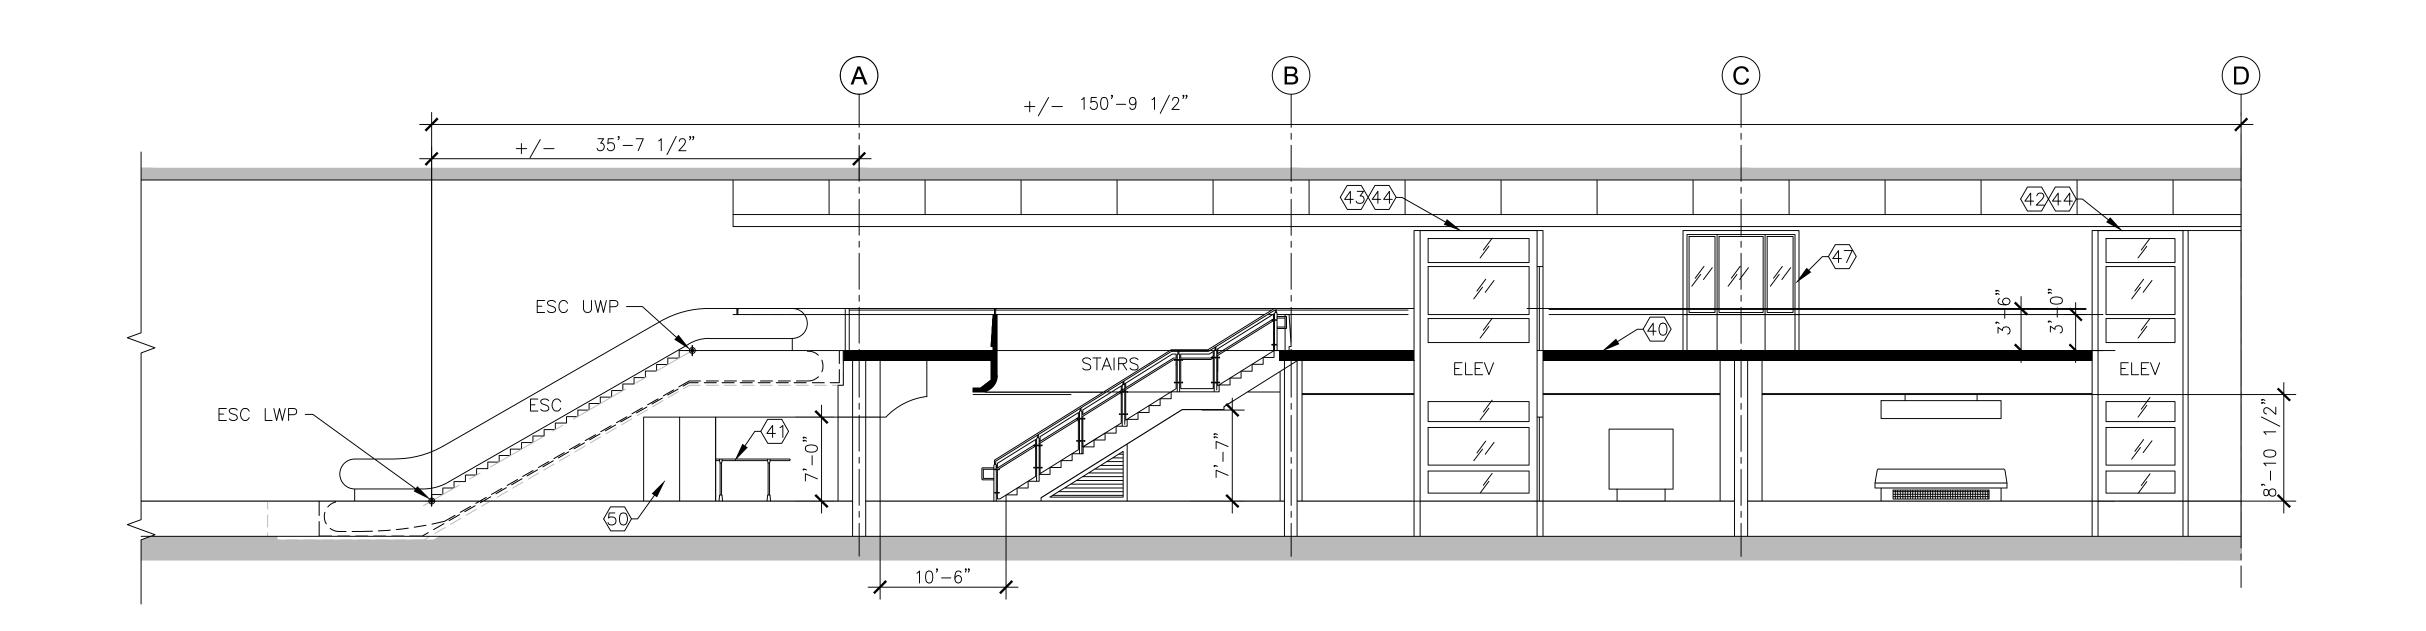


LONGITUDINAL SECTION - FUTURE WORK (NIC)

# GENERAL NOTES

- 1. VERIFY ALL DIMENSIONS IN THE FIELD.
- 2. VERIFY ALL FIELD CONDITIONS.
- 3. ALL DIMENSIONS ARE NOMINAL UNLESS NOTED OTHERWISE.
- 4. ALL WORK WILL BE COMPLETED IN ACCORDANCE WITH THE LATEST VERSIONS OF I.B.C. AND LIFE SAFETY CODES. ALL WORK IS DESIGNED AND SHALL BE CONSTRUCTED IN ACCORDANCE W/WMATA DESIGN CRITERIA, VERSION 9.
- 5. DO NOT SCALE DWGS FOR PURPOSES OF FINAL DESIGN
- 6. DEMOLITION, CUTTING, AND PATCHING OF ANY MATERIALS OR FIXTURES REQUIRED TO CONSTRUCT THE PROJECT IS HEREIN MADE A PART OF THESE DOCUMENTS.
- 7. THE CONTRACTOR SHALL SECURE AND PAY FOR ALL PERMITS AS REQUIRED.
- 8. THE IMAGES ON THE CONSTRUCTION DOCUMENT FLOOR PLANS REFLECT THE INFORMATION FROM THE ORIGINAL CONSTRUCTION DOCUMENTS FOR THE PROJECT, IT IS NOT AN INDICATION OF NEW WORK, IT IS SHOWN IN GRAY LINE COLOR. THE NEW WORK AND REQUIRED DEMOLITION OR REMOVALS ARE SHOWN IN BLACK LINE COLOR. IF THE DIFFERENCE IS NOT OBVIOUS, REPORT TO THE A.R. IMMEDIATELY.
- 9. ALL WORK INDICATED OR SHOWN GRAPHICALLY AS "EXIST (EXISTING) TO REMAIN" WILL BE THE CONTRACTOR'S RESPONSIBILITY TO PROTECT AND WORK AROUND WITHOUT DISTURBING. IF DAMAGED, THE CONTRACTOR WILL REPLACE AT NO ADDITIONAL COST TO THE OWNER.
- 10. FIREPROOF ALL NEW STRUCT STEEL, INCLUDING, BUT NOT LIMITED TO COLUMNS, BEAMS, METAL DECK, AND MISCELLANEOUS METALS SEE SPECIFICATION SECTION 07.81.00.
- 11. FORMWORK FOR PRECAST CONCRETE TO MATCH FORMWORK USED AT THE NORTH MEZZANINE STAIR.

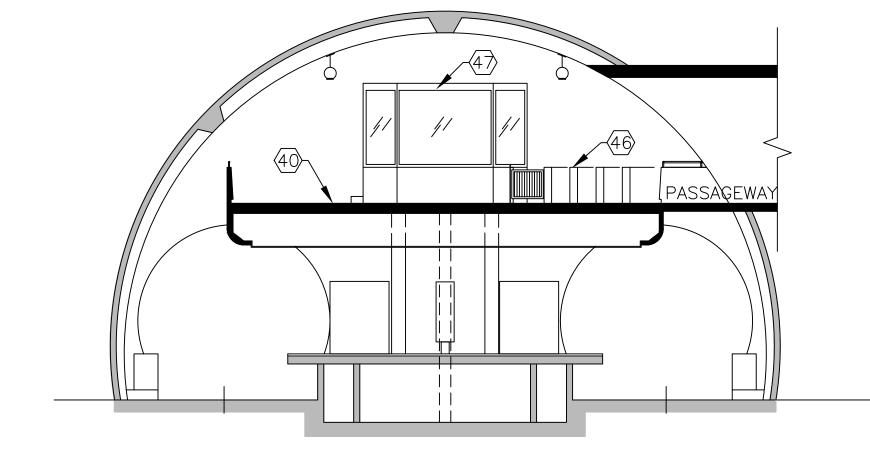

A-302 SCALE: 1/8" = 1'-0"

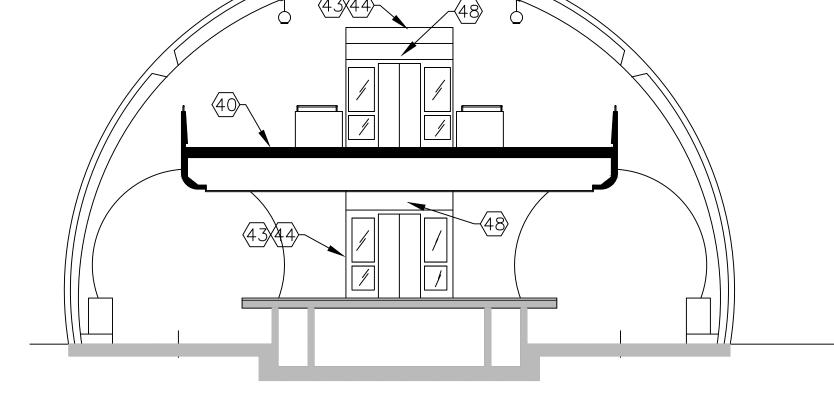

A-302

TRANSVERSE SECTION - FUTURE WORK (NIC)

SCALE: 1/8" = 1'-0"

TRANSVERSE SECTION - FUTURE WORK (NIC)

SCALE: 1/8" = 1'-0"

# SHEET NOTES

SEE A-103 FOR "SHEET NOTES FOR FUTURE WORK (NIC)"  $\langle X \rangle$ 

| DESIGNED | AD | 2/20/15 | DATE | DA

WASHINGTON METROPOLITAN AREA TRANSIT AUTHORITY

DEPARTMENT OF TRANSIT INFRASTRUCTURE
AND ENGINEERING SERVICES
OFFICE OF INFRASTRUCTURE RENEWAL PROGRAM
APPROVED



PROJECT MANAGER

RED LINE REHAB.-FRIENDSHIP HEIGHTS TO GROSVENOR - PART 6

FUTURE WORK (NIC) SECTIONS

 SCALE
 DRAWING NO.
 SHEET NO.

 AS SHOWN
 A09-A-302
 M1272-196

FQ15093

#### **GENERAL STRUCTURAL NOTES** SPECIFICATIONS: A. WMATA "GENERAL PROVISIONS AND STANDARD SPECIFICATIONS FOR CONTRACT DRAWINGS." B. WMATA "DIRECTIVE DRAWINGS." 2. DESIGN CRITERIA: A. WMATA "MANUAL OF DESIGN CRITERIA FOR MAINTAINING AND CONTINUED OPERATION OF FACILITIES AND SYSTEMS, MAY 2008." B. ACI 318-99 BUILDING CODE REQUIREMENTS FOR STRUCTURAL CONCRETE", ALTERNATE DESIGN METHOD.

D. AMERICAN WELDING SOCIETY STANDARD D1.1. E. ASCE 7-10 MINIMUM DESIGN LOADS FOR BUILDINGS AND OTHER STRUCTURES. F. INTERNATIONAL BUILDING CODE, 2012.

3. DESIGN LOADING A. DEAD LOADS CONCRETE

> STEEL 490 PCF - SOILS 130 PCF (BUOYANT WEIGHT = 68 PCF) - ROCK 170 PCF B. LIVE LOADS - STATION PLATFORMS

C. AISC MANUAL OF STEEL CONSTRUCTION, 14TH EDITION.

150 PSF STAIRWAYS 150 PSF OR CONCENTRATED LOAD OF 300 LBS. ON STAIR TREAD MEZZANINE 150 PSF PASSAGEWAYS 150 PSF - EQUIPMENT AND SERVICE ROOMS 250 PSF (UNO)

150 PCF

250 PSF

 HORIZONTAL LOAD AT TOP OF 150 PLF CONCRETE PARAPET VERTICAL LOAD AT TOP OF 100 PLF CONCRETE PARAPET SAFETY WALKS

200 LBS. IN ANY DIRECTION OR 50 PLF RAILINGS - AIR PRESSURE FROM RUNNING TRAINS ON 70 PSF SERVICE AREA WALLS, DOORS & HARDWARE

- GRATINGS AND HATCHES 4. DESIGN LOADINGS FOR ELEVATORS

A. SURFACE ELEVATORS SNOW LOAD 30 PSF BASIC WIND LOAD 40 PSF

 CANOPY FRAME LIVE LOAD 100 PLF FOR FREE EDGES

- ELEVATOR PIT SLAB AS PER MEP AND ELEVATOR MANUFACTURER DWGS. PLUS IMPACT

B. MEZZANINE TO PLATFORM ELEVATORS - ENCLOSURE, GLAZED AREA 30 PSF ENCLOSURE, UNGLAZED AREA 15 PSF

5. WIND LOADS IN ACCORDANCE WITH ASCE 7-10 - COMPONENTS AND CLADDING BASIC WIND VELOCITY 90 MPH

EXPOSURE С 1.15 IMPORTANCE FACTOR CATEGORY

6. CONCRETE

A. ALL CONSTRUCTION JOINTS IN EXTERIOR WALLS SHALL BE BONDED JOINTS.

B. ALL VERTICAL CONSTRUCTION JOINTS IN EXTERIOR WALLS AND SLABS SHALL BE KEYED.

C. ALL HORIZONTAL CONSTRUCTION JOINTS IN INTERIOR MEMBERS SHALL BE KEYED.

D. ALL VERTICAL CONSTRUCTION JOINTS IN INTERIOR MEMBERS SHALL BE KEYED.

E. ADDITIONAL HORIZONTAL AND VERTICAL CONSTRUCTION JOINTS MAY BE ADDED ONLY WITH WRITTEN AUTHORIZATION OF THE ENGINEER. ENGINEER APPROVED ADDITIONAL CONSTRUCTION JOINTS SHALL NOT RESULT IN ADDITIONAL EXPENSE TO THE OWNER

F. ALL CONTRACTION JOINTS SHALL HAVE A BOND BREAKER APPLIED.

G. PROVIDE 9" PVC DUMBBELL WATERSTOPS IN ALL EXTERIOR CONSTRUCTION AND CONTRACTION JOINTS. FOR JOINT DETAILS, SEE DWG. NO. ST-S-001.

H. CHAMFER ALL EXPOSED EDGES 3/4" X 3/4". CHAMFER REQUIRED UNLESS NOTED OTHERWISE IN DRAWINGS.

I. ALLOW 48 HOURS MINIMUM CURING TIME BETWEEN PLACEMENT OF ADJACENT CONCRETE POURS.

J. ALL CONDUITS IN THE FINAL LINER AND SLABS SHALL BE ROUTED ON THE DRY SIDE OF THE WATER STOPS.

K. REINFORCED CONCRETE STRUCTURES SHALL BE DETAILED AND CONSTRUCTED IN ACCORDANCE WITH THE CURRENT "ACI STANDARD BUILDING CODE REQUIREMENTS FOR REINFORCED CONCRETE" (ACI 318).

L. SEE ARCHITECTURAL, CIVIL, MECHANICAL AND ELECTRICAL DRAWINGS FOR ALL EMBEDDED ITEMS SUCH AS SCREWS, ANCHORS, ELECTRICAL CONDUITS, OPENINGS, ETC. WHICH MAY INTERFERE WITH CONCRETE CONSTRUCTION.

M. CONCRETE STRENGTH SHALL BE AS FOLLOWS:

- WALLS, SLABS, SLABS ON GRADE, BEAMS AND COLUMNS f'c = 4,000 PSI f'c = 5,000 PSI PRECAST CONCRETE f'c = 3,500 PSIALL OTHER CAST—IN—PLACE CONCRETE

7. REINFORCING STEEL

A. ALL REINFORCING STEEL SHALL CONFORM TO ASTM A615, GRADE 60.

B. CONCRETE COVER FOR REINFORCING SHALL BE AS FOLLOWS,

UNLESS NOTED OTHERWISE ON THE DRAWINGS: - UNFORMED CONCRETE BOTTOM BARS IN FOOTINGS AND SLABS ON EARTH, GRAVEL OR CRUSHED STONE......3"

- EXTERIOR UNFORMED SURFACE OF WALLS.......3"

- BEAMS, COLUMNS, SLABS AND WALLS EXPOSED TO GROUND OR WEATHER AFTER THE REMOVAL OF FORMS......2"

- BEAMS, COLUMNS AND WALLS NOT EXPOSED TO GROUND OR WEATHER

AFTER THE REMOVAL OF FORMS....... 1 1/2" - SLABS NOT EXPOSED TO GROUND OR WEATHER AFTER THE REMOVAL OF FORMS......3/4"

C. ALL SPLICES SHALL BE CLASS B TENSION LAPS UNLESS OTHERWISE NOTED ON THE PLANS.

D. ALL REINFORCEMENT SHALL BE MADE ELECTRICALLY CONTINUOUS. THIS INCLUDES INTERFACE WITH ADJACENT CONTRACTS; CHIP OUT EXISTING CONCRETE TO MAKE CONNECTION WHERE NECESSARY. UNLESS OTHERWISE SHOWN OR NOTED, ELECTRICALLY BONDED CIRCUMFERENTIAL CONTRACTION JOINTS ARE TO BE CONSTRUCTED AT A MAXIMUM INTERVAL OF 50'-0" MEASURED HORIZONTALLY. FOR DETAILS OF ELECTRICAL BONDING, SEE DWG. NO. ST-S-007 AND ST-S-021.

E. REINFORCING STEEL SHALL BE DETAILED IN ACCORDANCE WITH ACI 315-99 "MANUAL OF STANDARD PRACTICE FOR DETAILING CONCRETE STRUCTURES." THE CONTRACTOR SHALL SUBMIT DRAWINGS OF REINFORCING STEEL BEFORE PROCEEDING WITH FABRICATION.

F. WELDED STEEL WIRE FABRIC SHALL CONFORM TO ASTM A185-06. THE FABRIC SHALL BE FURNISHED IN FLAT SHEETS.

G. UNLESS OTHERWISE NOTED ON THE STRUCTURAL DRAWINGS, SPLICE AND EMBEDMENT LENGTHS FOR REINFORCING BARS SHALL BE IN ACCORDANCE WITH TABLE SHOWN BELOW:

REINFORCING SPLICE AND DEVELOPMENT LENGTHS (INCHES)										
	#3	#4	#5	#6	#7	#8	#9	#10	#11	
Ld	12	14	17	26	41	53	68	86	106	
TOP BAR Ld	14	18	22	36	46	60	77	97	120	
Ls	14	18	22	33	53	69	88	112	138	
TOP BAR Ls	17	23	29	47	60	78	100	127	156	

Ld=DEVELOPMENT LENGTH

Ls=SPLICE LENGTH

NOTE: TOP BARS ARE DEFINED AS HAVING MORE THAN 12" OF FRESH CONCRETE CAST BELOW BAR.

8. STRUCTURAL STEEL

A. MATERIALS SHALL CONFORM TO THE FOLLOWING:

W-SHAPES ASTM A572 GRADE 50 ASTM A36 SHAPES AND PLATES ASTM A500 GRADE B STRUCTURAL BOLTS ASTM A325

 ANCHOR BOLTS ASTM F1554 GRADE 55 ROCK BOLTS ASTM F432

B. THE CONTRACTOR SHALL SUBMIT ERECTION PLANS AND SHOP DETAILS BEFORE PROCEEDING WITH FABRICATION.

C. MILL BOTTOM OF ALL COLUMNS AND FINISH TOP OF ALL BASE PLATES IN ACCORDANCE WITH AISC SPECIFICATIONS. BASE PLATES SHALL BE WELDED TO BOTTOM OF COLUMNS.

D. 1/4" THICK LEVELING PLATES SHALL BE USED UNDER ALL BEAMS AND COLUMNS RESTING ON

E. ALL SHOP CONNECTIONS SHALL BE WELDED WITH ELECTRODES AS SPECIFIED. ALL FIELD CONNECTIONS SHALL BE HIGH STRENGTH BOLTED JOINTS, TYPE ST, EXCEPT WHERE NOTED. BOLTS SHALL BE A325 AND CERTIFIED AS NOT TO BE COUNTERFEIT.

F. ELECTRODES FOR WELDING CONNECTIONS SHALL BE AS FOLLOWS:

SHIELDED METAL ARC E70XX SUBMERGED ARC F7X-EXXX

G. CONNECTION DETAILS SHALL BE DESIGNED AND SUBMITTED ON SHOP DRAWINGS BY THE CONTRACTOR AND ACCOMPANIED BY COMPLETE STRUCTURAL CALCULATIONS PREPARED AND SIGNED AND SEALED BY AN ENGINEER, LICENSED IN THE STATE OF MARYLAND.

9. GENERAL REQUIREMENTS

A. ELEVATIONS ARE TO BE ACTUAL FINISH ELEVATION.

B. SHORING REQUIRED FOR THE STABILITY OF THE UNCOMPLETED STRUCTURE OR FOR INSTALLATION OR MODIFICATION OF STRUCTURAL MEMBERS SHALL BE THE CONTRACTOR'S RESPONSIBILITY. ANY REQUIRED TEMPORARY STRUCTURES SHALL BE DESIGNED FOR THE LOADINGS SHOWN ON DWG. NO. ST-S-009.

C. CONTRACTOR SHALL VERIFY ALL EXISTING CONDITIONS, DIMENSIONS AND ELEVATIONS PRIOR TO THE START OF CONSTRUCTION. THE CONTRACTOR SHALL NOTIFY THE ENGINEER OF ANY DISCREPANCIES OR CONFLIFTS FOUND IN CONTRACT DOCUMENTS AND/OR FIELD CONDITIONS. IT SHALL BE THE RESPONSIBILITY OF THE CONTRACTOR TO SUPPLY THE ENGINEER WITH ALL FIELD DIMENSIONS REQUIRED TO CHECK DETAIL DRAWINGS. THE ± MARKS SHOWN WITH DIMENSIONS AND STATIONS DO NOT INDICATE ANY DEGREE OF PRECISION. THESE ± MARKS INDICATE DIMENSIONS AND STATIONS FROM EXISTING PLANS THAT MAY VARY AND DO REQUIRE FIELD VERIFICATION BY THE CONTRACTOR.

D. CONTRACTOR SHALL COORDINATE ALL REQUIRED OPENINGS WITH MECHANICAL, ELECTRICAL, AND ARCHITECTURAL DRAWINGS. CONTRACTOR SHALL COORDINATE FINAL SIZE AND LOCATION OF ALL OPENINGS WITH THE ACTUAL EQUIPMENT SUPPLIED, PROJECT REQUIREMENTS, AND WITH FIELD CONDITIONS.

SUBMITTED BY\_

E. THE ENGINEER PERMITS NO ALTERATIONS OR OPENINGS THROUGH BEAMS OR COLUMNS, UNLESS DETAILED ON STRUCTURAL PLANS.

F. THE SIZES AND LOCATIONS OF EQUIPMENT PADS, PEDESTALS AND FLOOR AND SLAB OPENINGS ARE DEPENDENT ON THE ACTUAL EQUIPMENT FURNISHED. IT SHALL BE THE CONTRACTOR'S RESPONSIBILITY TO COORDINATE AND VERIFY ALL SUCH ITEMS. NO DIMENSIONS INDICATED ON THESE DRAWINGS SHALL BE ALTERED WITHOUT THE ENGINEERS APPROVAL.

G. THE STRUCTURES SHALL BE DESIGNED TO RESISTS DESIGN LOADS ONLY AS COMPLETED STRUCTURES, UNLESS NOTED OTHERWISE ON THE DRAWINGS. ANY PROPOSED APPLICATION OF CONSTRUCTION LOADS WHICH EXCEED THE DESIGN LOADS, OR ANY LOADS APPLIED TO A PARTIALLY COMPLETED STRUCTURE WILL BE THE RESPONSIBILITY OF THE CONTRACTOR. ALL THE COST OF ANALYSIS, REDESIGN AND ANY ADDITIONAL CONSTRUCTION COSTS RESULTING FROM THE REDESIGN SHALL BE ACCOMPLISHED AT THE CONTRACTOR'S

H. WHERE A SPECIFIC MODEL AND/OR MANUFACTURER OF AN ITEM ARE NAMED ON A DRAWING AND/OR IN THE SPECIFICATIONS, THE MODEL AND/OR MANUFACTURER ARE THE BASIS OF DESIGN. ITEMS BY OTHER MANUFACTURERS OF EQUAL DESIGN MAY BE SUBMITTED TO THE ENGINEER FOR REVIEW AS APPROVED

I. ALL PLAN DIMENSIONS ON THE DRAWINGS ARE MEASURED IN A TRUE HORIZONTAL PLANE UNLESS NOTED OTHERWISE.

J. ALL VERTICAL DIMENSIONS SHALL BE MEASURED IN A TRUE VERTICAL PLANE FOR ALL STRUCTURES UNLESS

K. COLUMNS, WALLS, DOORS, CONSTRUCTION JOINTS AND ELEVATORS WITHIN THE STATION AND THE SERVICE AREAS SHALL BE PLACED TRULY VERTICAL, UNLESS NOTED OTHERWISE.

L. SUBMITTALS

- REPRODUCTION OF ANY PORTION OF THE STRUCTURAL CONTRACT DRAWINGS FOR RESUBMITTAL AS SHOP DRAWINGS IS PROHIBITED. SHOP DRAWINGS PRODUCED IN SUCH A MANNER WILL BE REJECTED AND RETURNED.

- ALL FORMWORK, SHORING AND RESHORING SHALL BE DESIGNED BY THE CONTRACTOR'S ENGINEER REGISTERED IN THE STATE OF MARYLAND. ALL SUBMISSIONS SHALL BEAR HIS SEAL AND SIGNATURE

- ALL SHORING, SHEETING, AND DEWATERING SHALL BE THE TOTAL RESPONSIBILITY OF THE CONTRACTOR. SHEETING AND SHORING SHALL BE DESIGNED BY THE CONTRACTORS ENGINEER REGISTERED IN THE STATE OF MARYLAND. ALL SUBMITTALS SHALL BEAR HIS/HER SEAL AND SIGNATURE AND MUST ACCOUNT FOR THE CONSTRUCTION SEQUENCE, DRAINAGE AND WALL THICKNESS. SUPPORT OF EXCAVATION SYSTEM FOR SHAFT AND ARCH SHALL PROVIDE SUFFICIENT CLEARANCE FOR CONSTRUCTION EXCAVATION, DELIVERY OF EQUIPMENT AND MATERIALS, WORKER ACCESS AND CONSTRUCTION OF FINAL STRUCTURE.

- STEEL GRATING SHALL HAVE DEPTH AS SHOWN ON DRAWINGS. MANUFACTURER SHALL DESIGN GRATING FOR THE LOADS SPECIFIED IN SECTION "3 DESIGN LOADING". ALL GRATING SHALL BE GALVANIZED PER ASTM A123.

- CONTRACTOR SHALL FURNISH DIMENSIONED COORDINATED SHOP DRAWINGS AT ALL LEVELS SHOWING THE LOCATION OF ALL SLEEVES AND OPENINGS REQUIRED BY ALL TRADES ON ONE PLAN FOR EACH LEVEL. CONFLICTS BETWEEN TRADES WILL BE RESOLVED BY GENERAL CONTRACTOR BEFORE SUBMISSION TO THE ENGINEER.

- REVIEW OF SHOP DRAWINGS DESIGNED BY CONTRACTORS ENGINEER'S SHALL BE FOR GENERAL CONFORMANCE WITH THE PROJECT PARAMETERS AS INDICATED ON THE DRAWINGS AND IN THE GENERAL NOTES.

M. THE CONTRACTOR SHALL TAKE PRECAUTIONS TO PROTECT ALL EXISTING STRUCTURES, CURBS, STREETS, ETC., FROM DAMAGE BY CONSTRUCTION EQUIPMENT. THE CONTRACTOR SHALL NOT DISPOSE OF ANY LIQUIDS, SLURRY, SOILS OR CHEMICALS ON THE SITE EXCEPT AS DIRECTED BY THE OWNER'S REPRESENTATIVE AND APPROVED BY THE DEPARTMENT OF ENVIRONMENTAL RESOURCES OR OTHER AGENCIES HAVING JURISDICTION.

N. THESE CONCEPT STRUCTURAL DRAWINGS REPRESENT THE GENERAL REQUIREMENTS FOR THE PROJECT WHICH SHALL BE DESIGNED. FOR THE WEIGHTS OF THE MATERIALS INDICATED ON THE DRAWINGS AND FOR THE SUPERIMPOSED LOADS INDICATED IN THE DESIGN DATA. IT IS THE CONTRACTOR'S RESPONSIBILITY TO DETERMINE ALLOWABLE CONSTRUCTION LOADS AND TO PROVIDE PROPER DESIGN AND CONSTRUCTION OF FALSEWORK, FORMWORK, STAGING, BRACING, SHEETING AND SHORING ETC.

O. ALL COSTS OF INVESTIGATION AND/OR REDESIGN, DUE TO CONTRACTOR MISLOCATION OF STRUCTURAL ELEMENTS OR OTHER LACK OF CONFORMANCE WITH THE PROJECT DOCUMENTS SHALL BE AT THE CONTRACTOR'S EXPENSE.

P. SEE ARCHITECTURAL DRAWINGS AND SPECIFICATIONS FOR DETAILED INFORMATION REGARDING FINISHES, FIREPROOFING. ETC.

Q. IN CASE OF CONFLICT BETWEEN THE GENERAL NOTES, DETAILS AND SPECIFICATIONS, THE MOST RIGID REQUIREMENTS SHALL GOVERN.

R. BACKFILL PLACED AROUND SHAFT STRUCTURE SHALL BE SELECT MATERIAL.

10. EXCAVATION AND EARTHWORK

A. REFERENCE GEOTECHNICAL DATA REPORT FOR SOUTH ENTRANCE TO BETHESDA METRO STATION BY E2CR, INC. DATED FEBRUARY 2010 FOR INFORMATION.

B. LOCATE ANY EXISTNG UTILITY LINES OR APPURTENANCES AND ADVISE ENGINEER OF ANY CONFLICTS OR DISCREPANCIES SHOWN IN PLANS PRIOR TO CONSTRUCTION. DO NOT DEMOLISH ANY EXISTING STRUCTURES WITHOUT WRITTEN AUTHORIZATION.

C. ALL EXCAVATIONS SHALL BE KEPT DRY. STANDING WATER SHALL NOT BE ALLOWED IN EXCAVATIONS.

11. EXISTING GEOTECHNICAL INFORMATION

A. FOR EXISTING BORING INFORMATION AT BETHESDA STATION, REFER TO RECORD DRAWINGS OF ROCKVILLE ROUTE DATED MAY 1977. FOR ROCK CAPACITY, REFER TO FINAL SUBSURFACE INVESTIGATION PREPARED BY MUESER RUTLEDGE WENTWORTH & JOHNSON DATED MARCH 1972.

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> NOTE: DIMENSIONS SHOWN ARE APPROXIMATE AND BASED ON INITIAL COORDINATION WITH WMATA. FINAL DIMENSIONS SHALL BE COORDINATED WITH WMATA AND EQUIPMENT SUPPLIED. FOR MINIMUM DIMENSIONS, SEE TECHNICAL PROVISIONS

CONTRACT NO. XXXXXX

REVISIONS DESIGNED \_\_\_\_ DESCRIPTION DATE BY DRAWN E.M. THOMPSON CHECKED <u>D.S. TUSING</u> DATE  ${ t APPROVED}$   ${ t oldsymbol \bot}$ 







DEPARTMENT OF OPERATIONS SERVICES OFFICE OF ENGINEERING SERVICE

81 MOSHER STREET | BALTIMORE, MD 21217 & ASSOCIATES, LLP FAX: (410) 728-3160


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BETHESDA STATION - SOUTH ENTRANCE

STRUCTURAL GENERAL NOTES

DRAWING NO. AS NOTED

5-

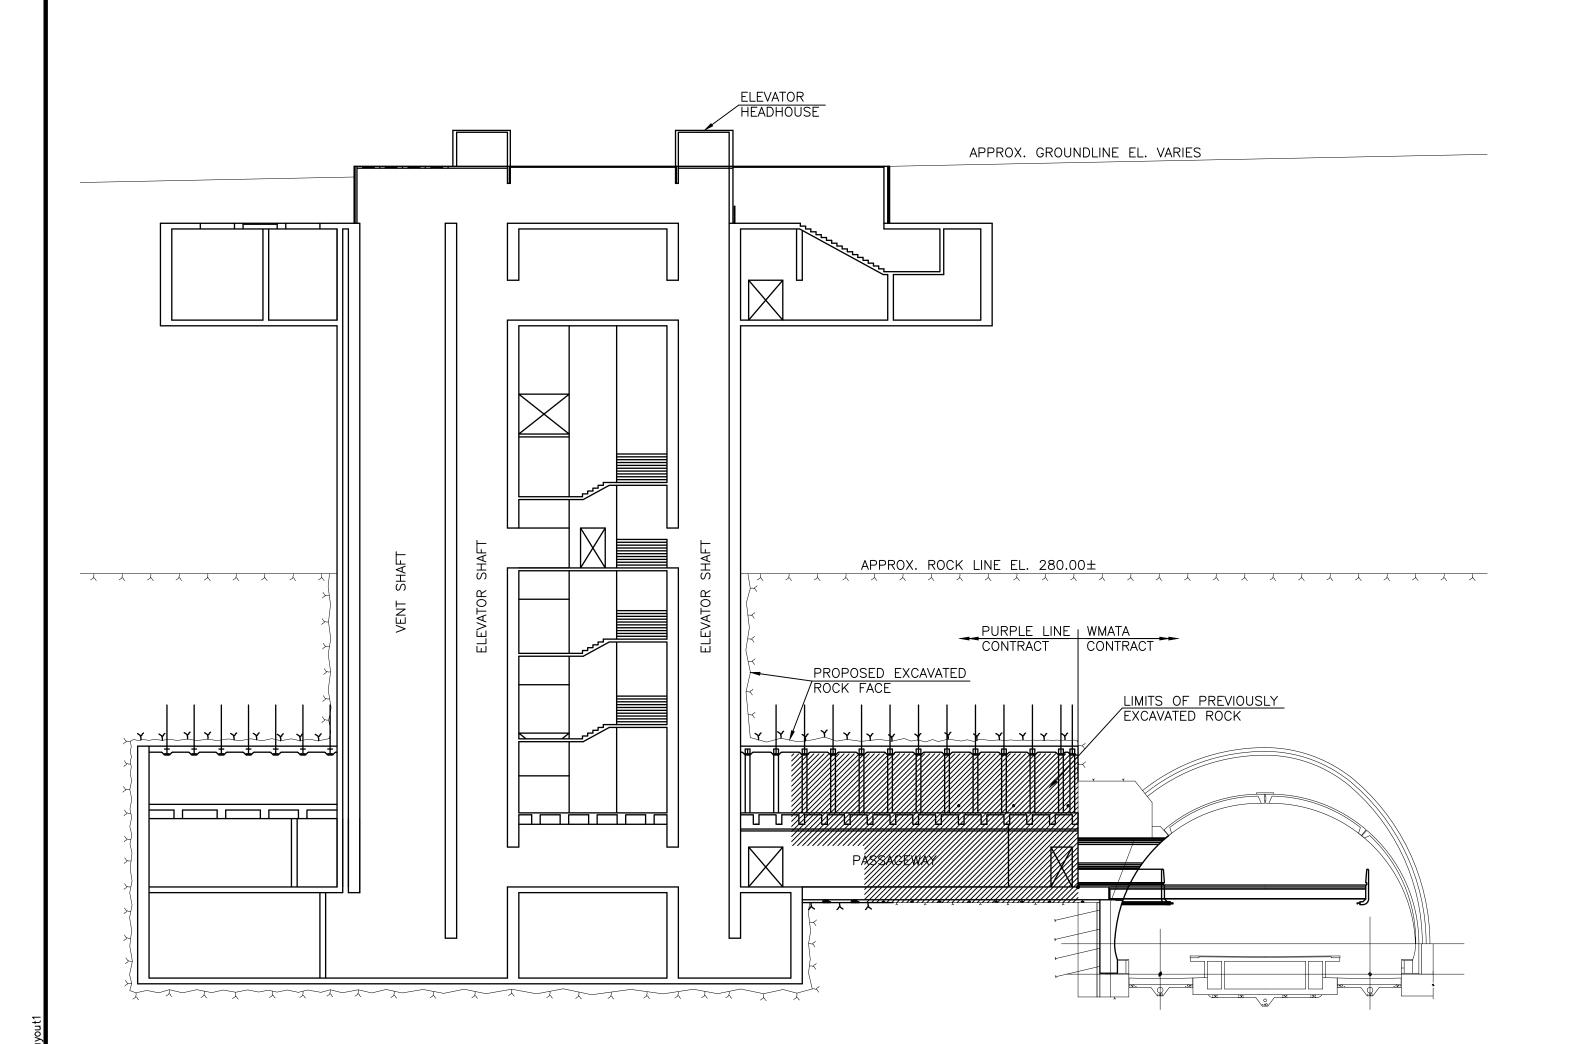

**ABBREVIATIONS** 

INBOUND

LONG

POUNDS

MAXIMUM

MINIMUM

NUMBER

OUTBOUND

OPENING

PLATE

RADIUS

SCHEDULE

STRUCTURAL

SYMMETRICAL

TOP OF RAIL

WIDE FLANGE WORKING POINT

STATION

THICK TOP OF

TYPICAL

NOT OT SCALE

OUTSIDE FACE

NUMBER (REINFORCING)

POUNDS PER SQUARE FOOT

POUNDS PER SQUARE INCH

SERVICE WEIGHT CAST IRON

UNLESS NOTED OTHERWISE

MEZZANINE

LBS.

MAX.

MEZZ.

MIN.

Ñ.T.S.

0.B.

O.F.

OPNG.

P.S.F.

P.S.I.

SCH.

STA.

SVCI SYMM.

THK.

T/R

TÝP.

UNO

STRUCT.

NO.

INSIDE FACE INTERIOR JOINT KNOCK-OUT

STRUCTURAL LEGEND

**EXISTING PROPOSED** APPROXIMATE APPROX. воттом BOT. CONTOUR WATERSTOP \_ \_ \_ \_ \_ \_ \_ \_ \_ \_ \_ \_ BRG. BEARING C.I.P. CAST-IN-PLACE INDEX CONTOUR REINFORCING STEEL CENTERLINE CHANNEL CENTERLINE W OR I SHAPE CLEAR, CLEARANCE CONST. CONSTRUCTION ANGLE SHAPE CONTR. CONTRACTION CONCRETE, CONCRETE FILL DIAMETER D.O. DOOR OPENING OPENING DWG. DRAWING CENTERLINE EACH FACE EACH WAY CONCRETE, CONCRETE FILL ELEVATION EQUAL EXP. **EXPANSION** PLATFORM SLAB REMOVAL EXT. **EXTERIOR** FIN. FINISHED PRECAST VAULT PANELS REMOVAL FEET FTG. FOOTING GALV. GALVANIZED HPR HYDROSTATIC PRESSURE RELIEF

1. THE ACTUAL CONSTRUCTION SEQUENCE AND SUPPORT OF EXCAVATION SYSTEM SHALL NOT RESULT IN LATERIAL PRESSURES TO THE SHAFT AND PASSAGEWAY ARCH RIBS HIGHER THAN THOSE SHOWN IN THE GEOTECHNICAL REPORT.

2. SEE GEOTECHNICAL DRAWINGS FOR SUPPORT OF EXCAVATION DETAILS BELOW EL. 280.00 ±. DESIGN OF SUPPORT OF EXCAVATION SYSTEM ABOVE EL. 280.00 ± SHALL BE BY CONTRACTOR. SYSTEM SHALL PROVIDE SUFFICIENT CLEARANCE FOR CONSTRUCTION EXCAVATION, DELIVERY OF EQUIPMENT AND MATERIALS AND WORKER ACCESS.

3. WATERPROOFING A. WATERPROOFING MEMBRANE AND GEOTEXTILE SHALL SATISFY THE

REQUIREMENTS OF THE SPECIFICATIONS. B. WATERPROOFING ABOVE THE APPROXIMATE ROCK LINE SHALL SATISFY

THE FOLLOWING REQUIREMENTS: - APPLY WATERPROOFING MEMBRANE AND GEOTEXTILE TO ALL

EXTERIOR CONCRETE SURFACES. FOR WATERPROOFING TERMINATION NEAR GROUND SURFACE, SEE DETAIL 3/S-25. - PROVIDE PROTECTIVE CONCRETE OVER WATERPROOFING ON ROOF

SLABS, SEE DETAIL 1/S-25. - WATERPROOFING SHALL BE SPLICED AT APPROXIMATE ROCK LINE, SEE DETAIL 6/S-23.

EXCAVATION WITH SELECT FILL. C. WATERPROOFING DETAILS SHALL BE SUBMITTED TO THE ENGINEER FOR APPROVAL.

- BACKFILL VOID BETWEEN WATERPROOFING AND SUPPORT OF

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WASHINGTON METROPOLITAN AREA TRANSIT AUTHORITY


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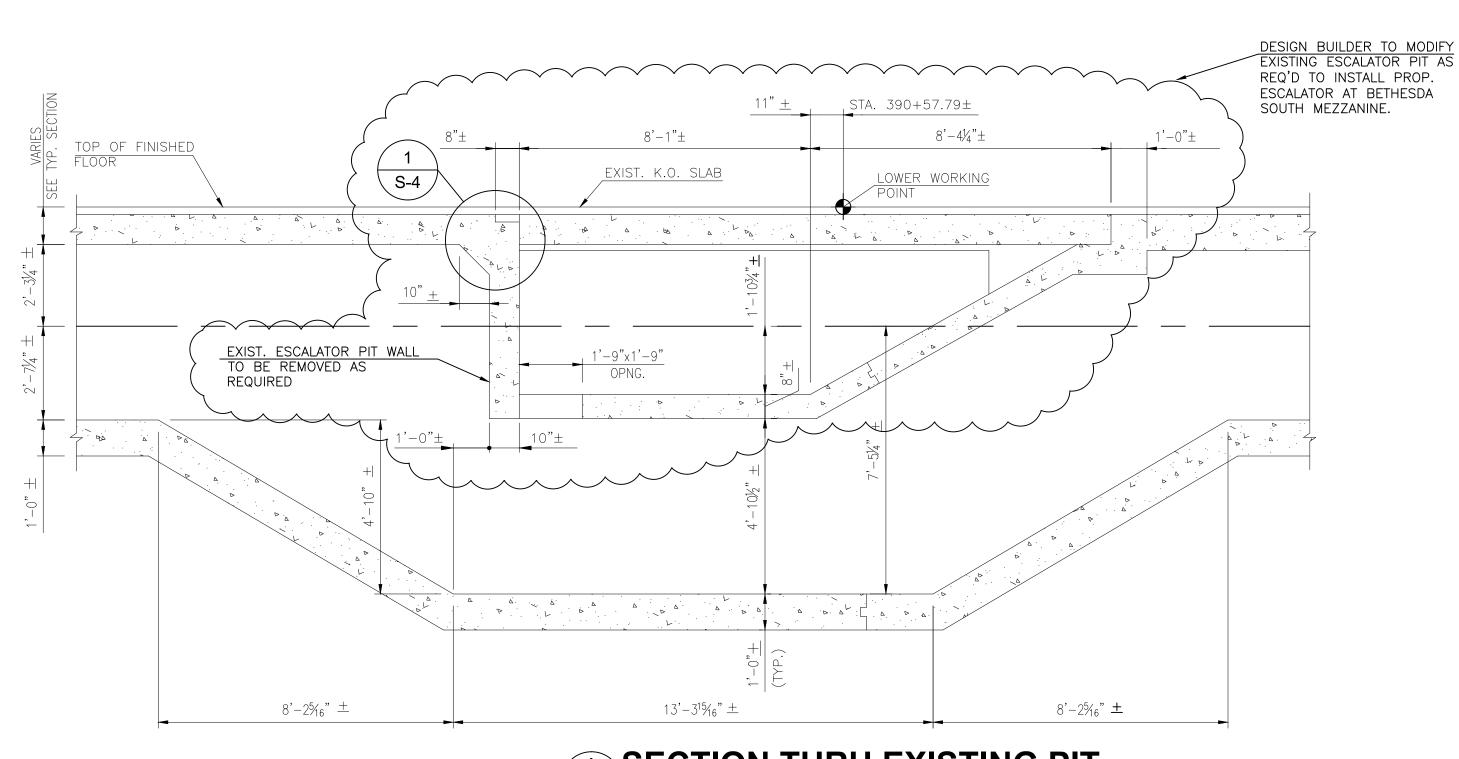
Rummel, Klepper & Kahl, LLP WHITMAN, REQUARDT 81 MOSHER STREET BALTIMORE, MD 21217 & ASSOCIATES, LLP PH: (410) 728-2900 FAX: (410) 728-3160 APPROVED \_\_\_\_


BETHESDA STATION - SOUTH ENTRANCE STRUCTURAL ABBREVIATION AND LEGEND


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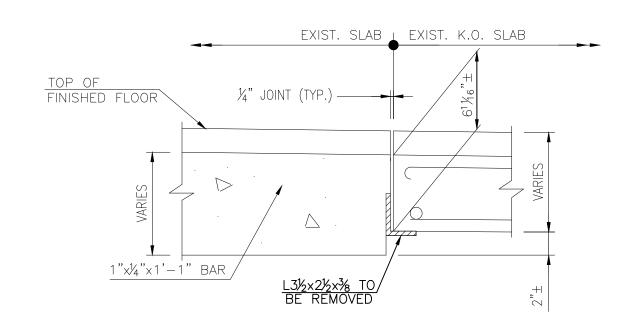






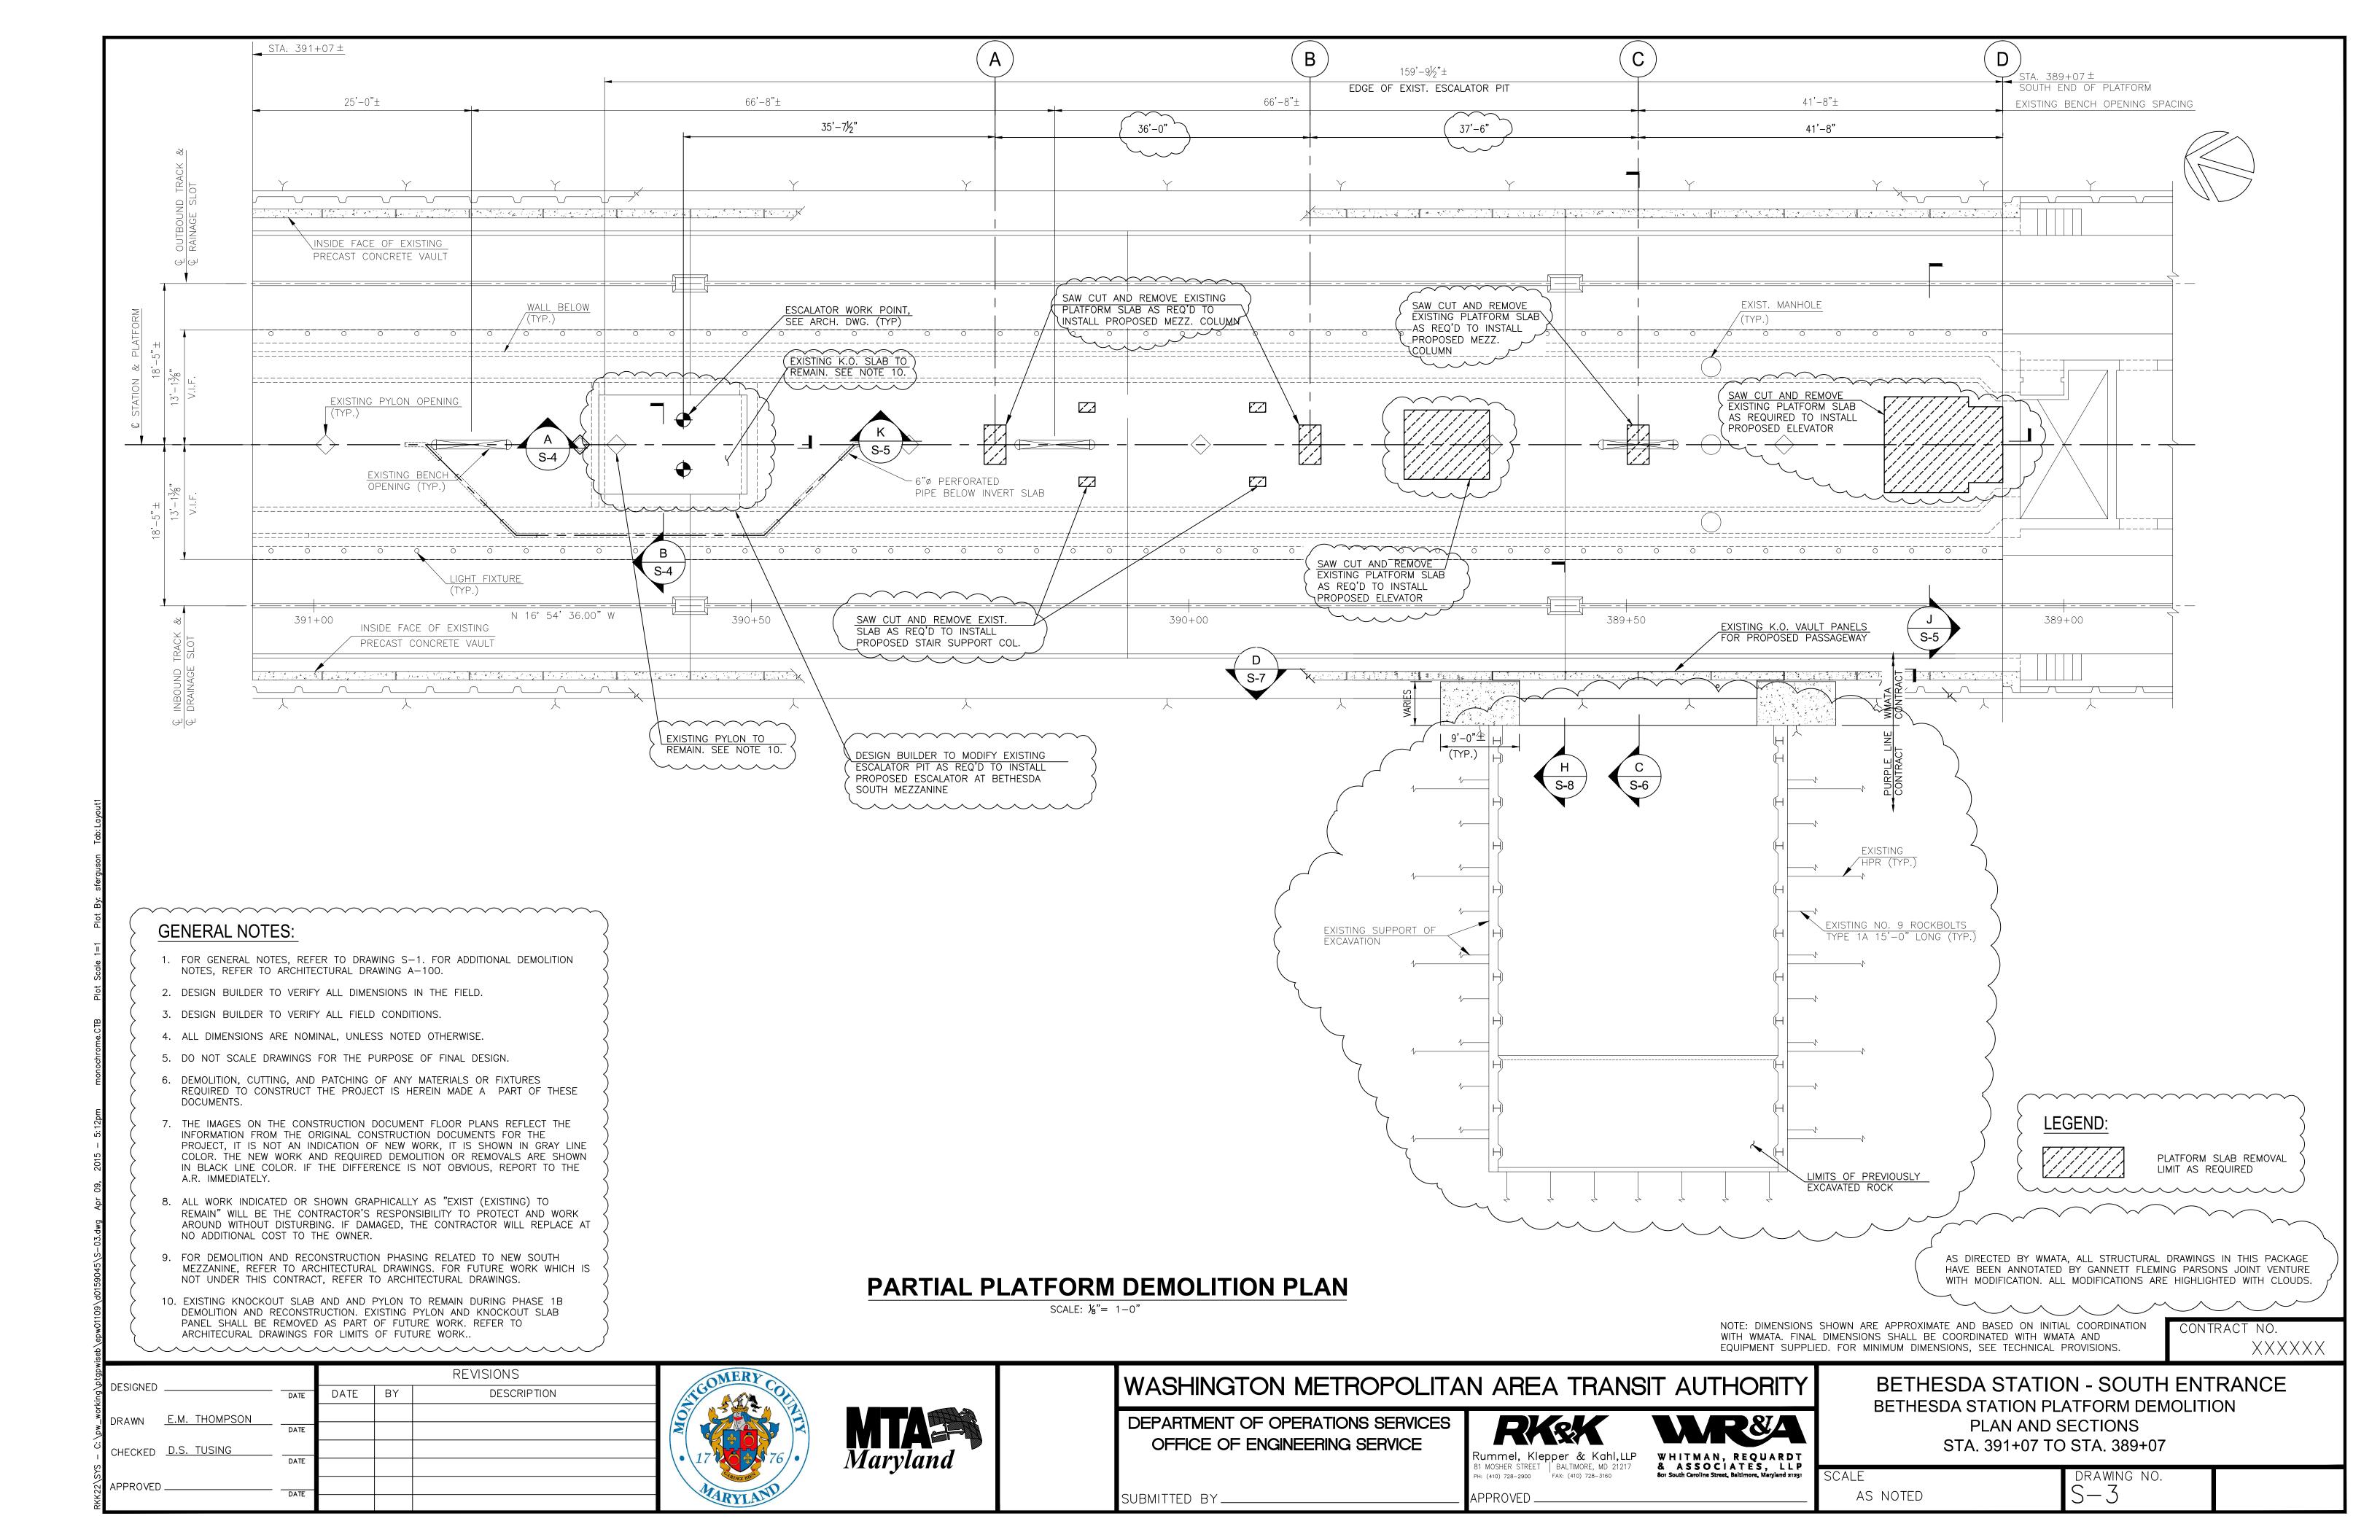
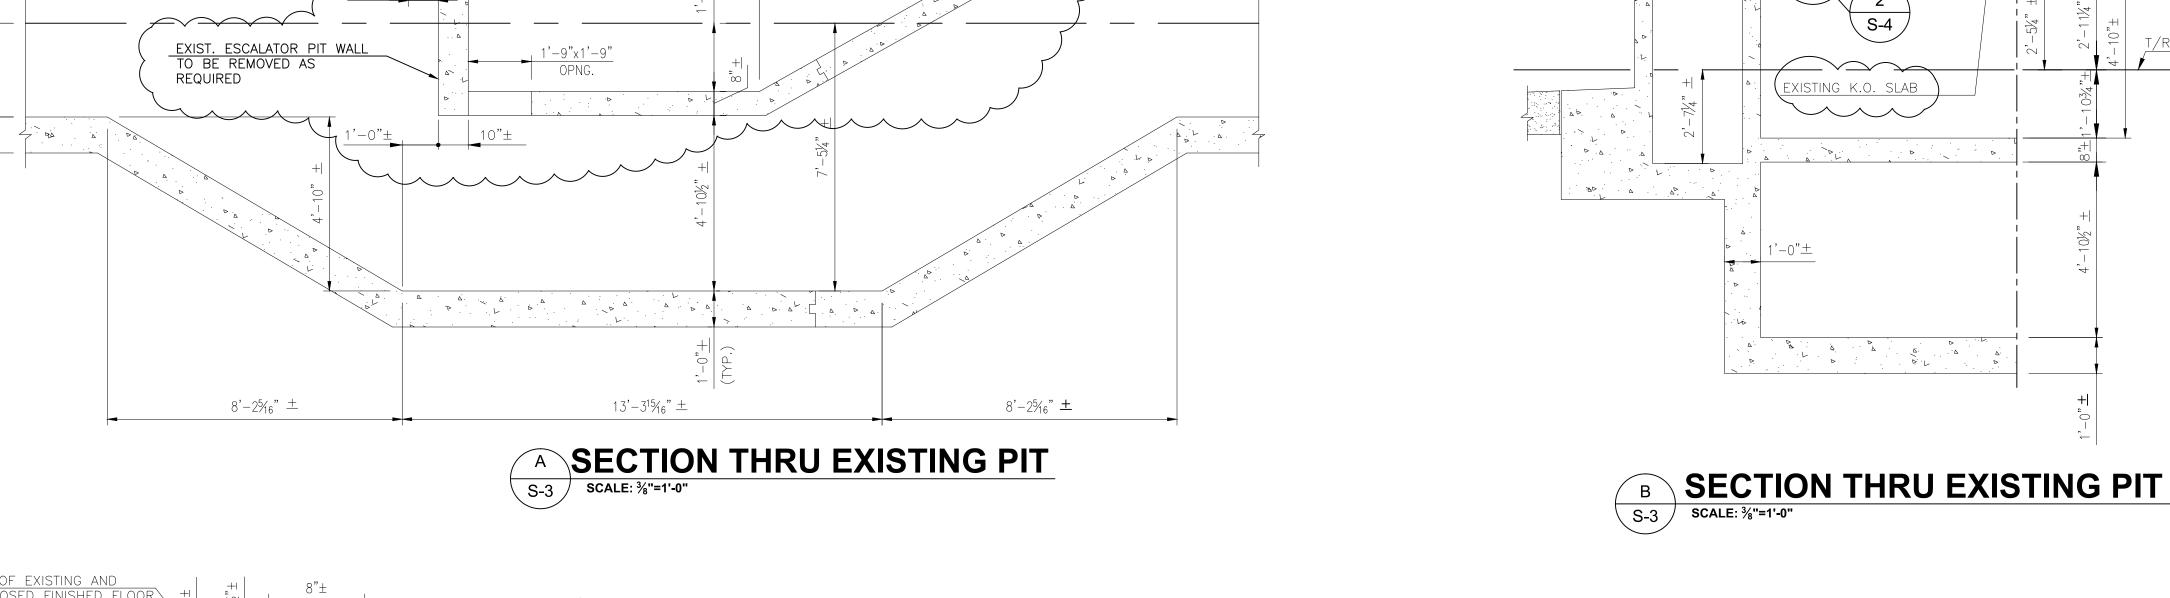
#### KNOCK OUT SLAB DETAIL S-4

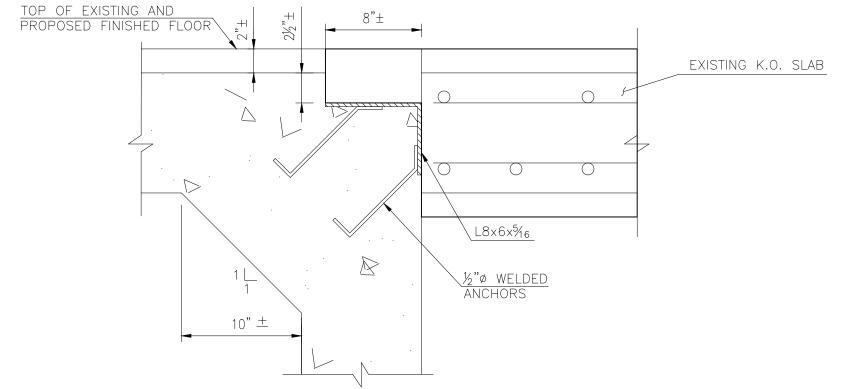

**KNOCK OUT SLAB DETAIL** SCALE: NTS

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WASHINGTON METROPOLITAN AREA TRANSIT AUTHORITY

APPROVED \_\_\_

13'-1¾" <u>+</u>

5'-8" ±

TOP OF FINISHED FLOOR

6<u>"+</u>

SLOPE 1%±

₽ PLATFORM

SYMMETRIC ABOUT &


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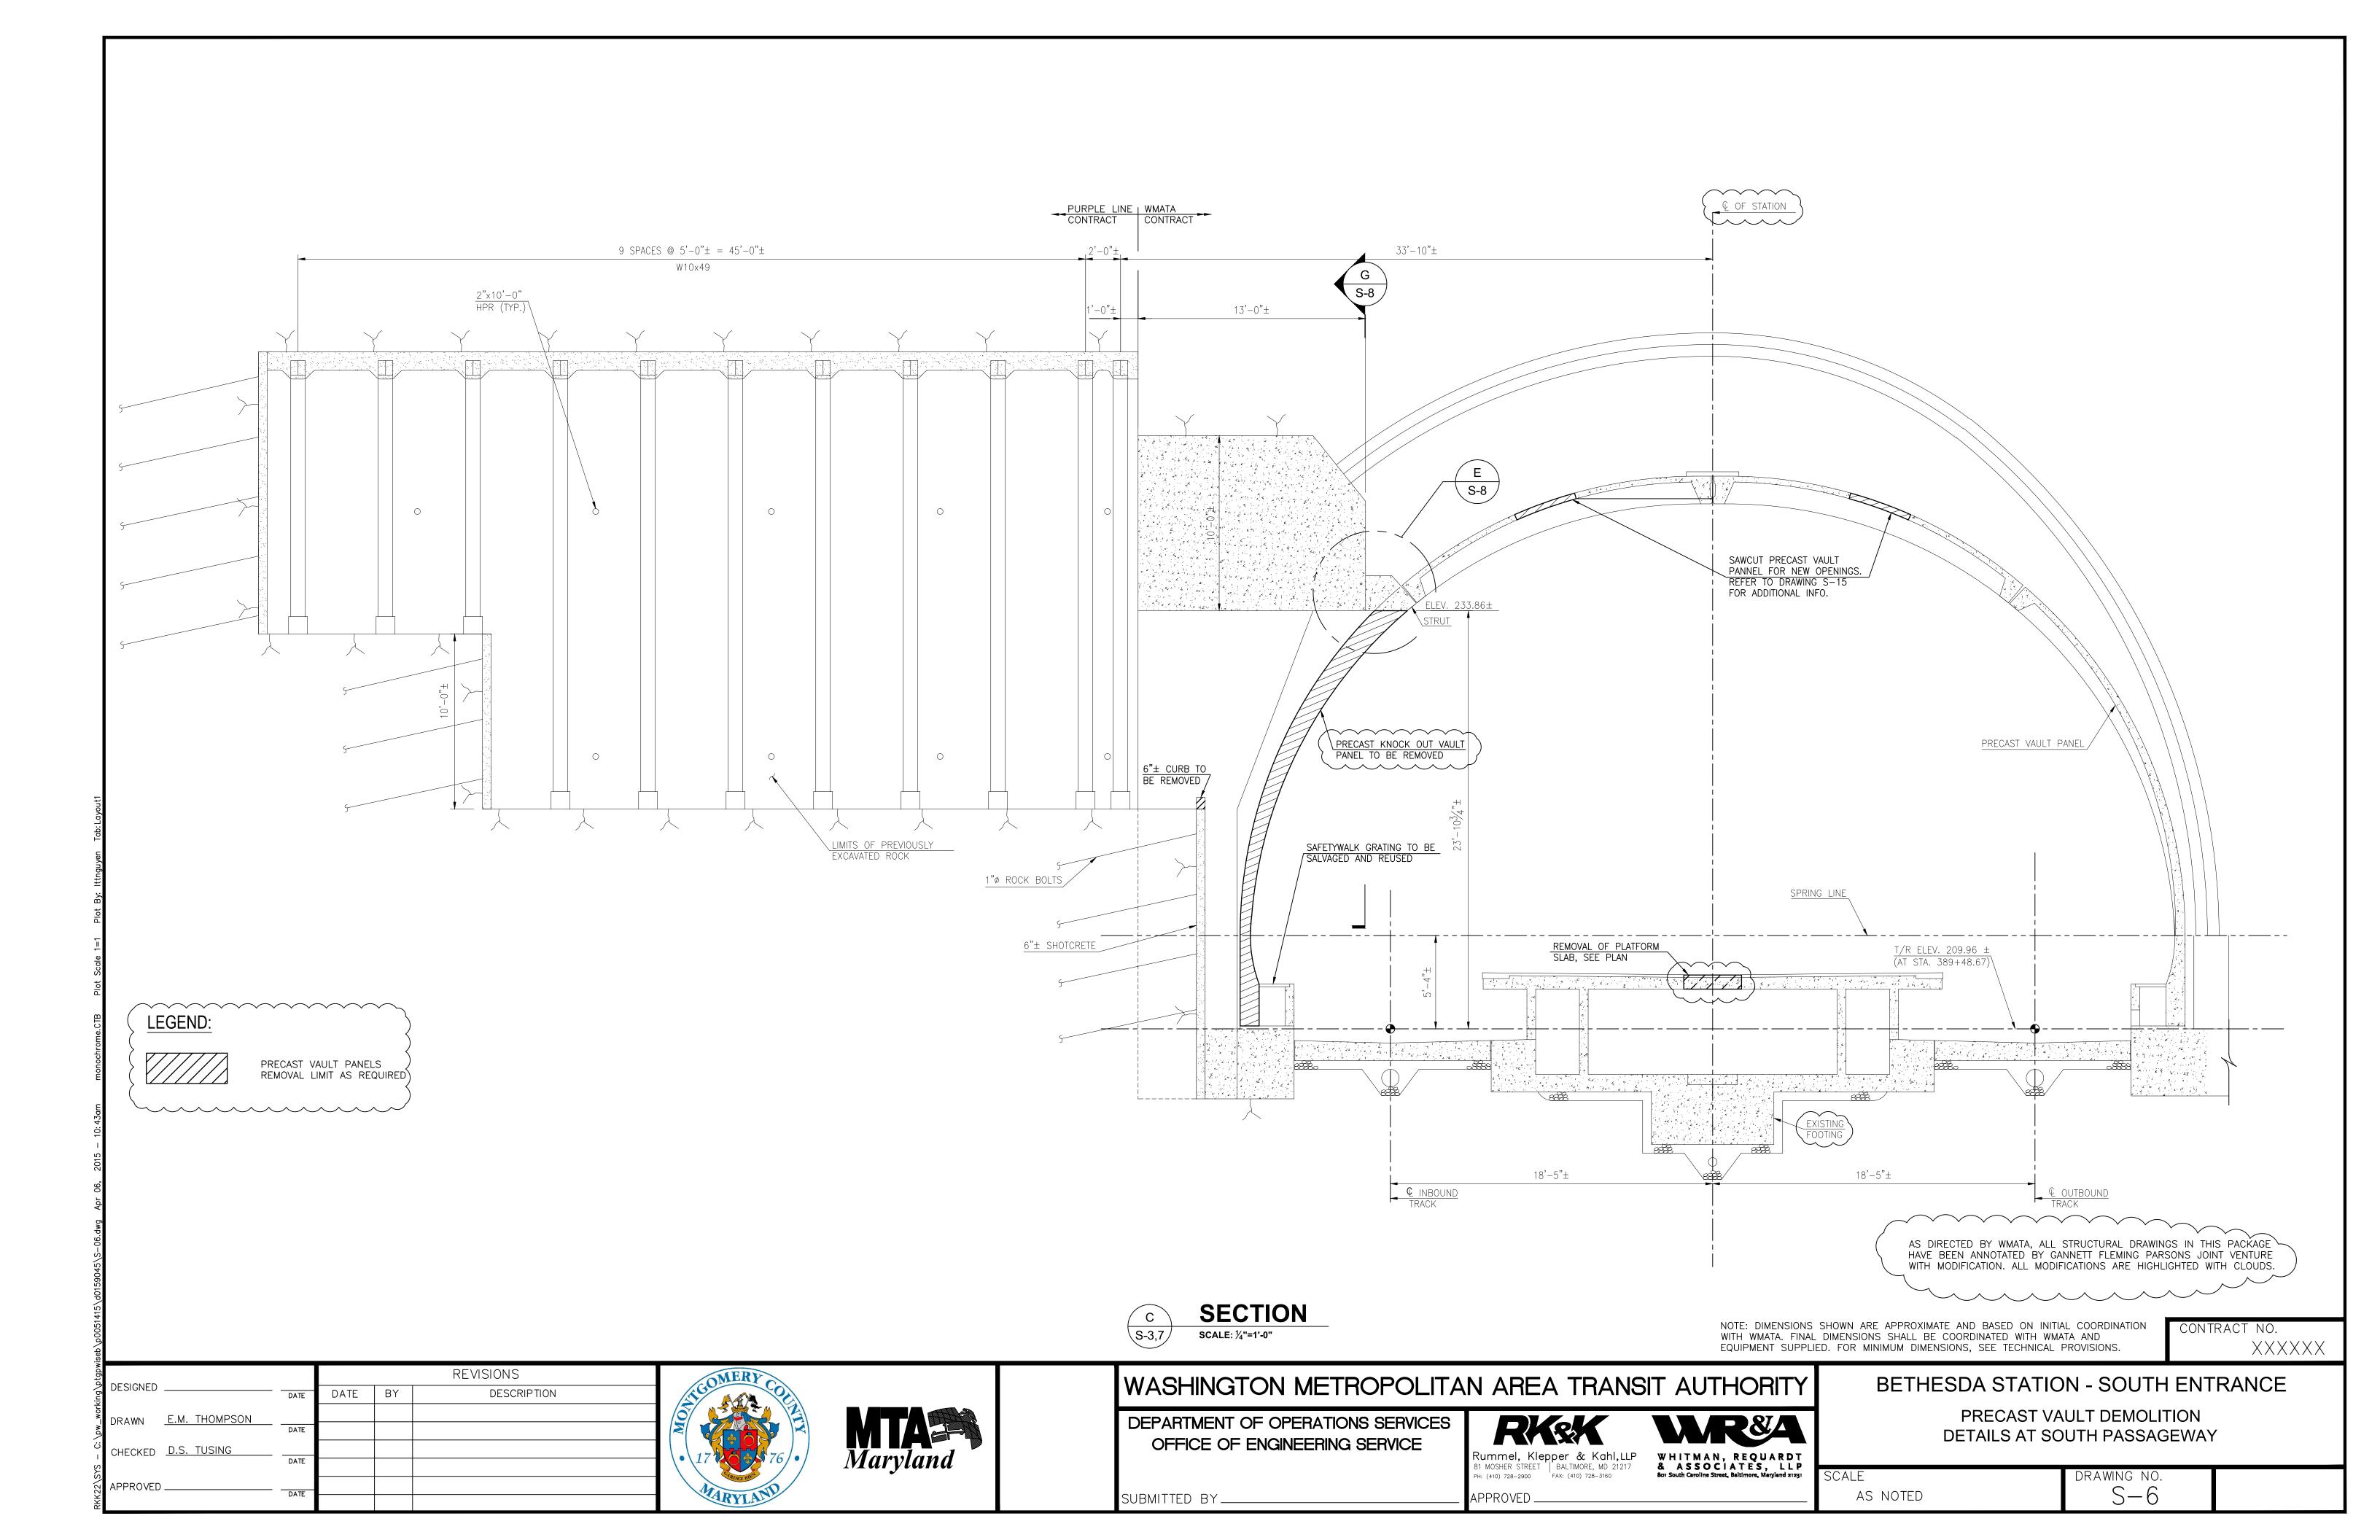
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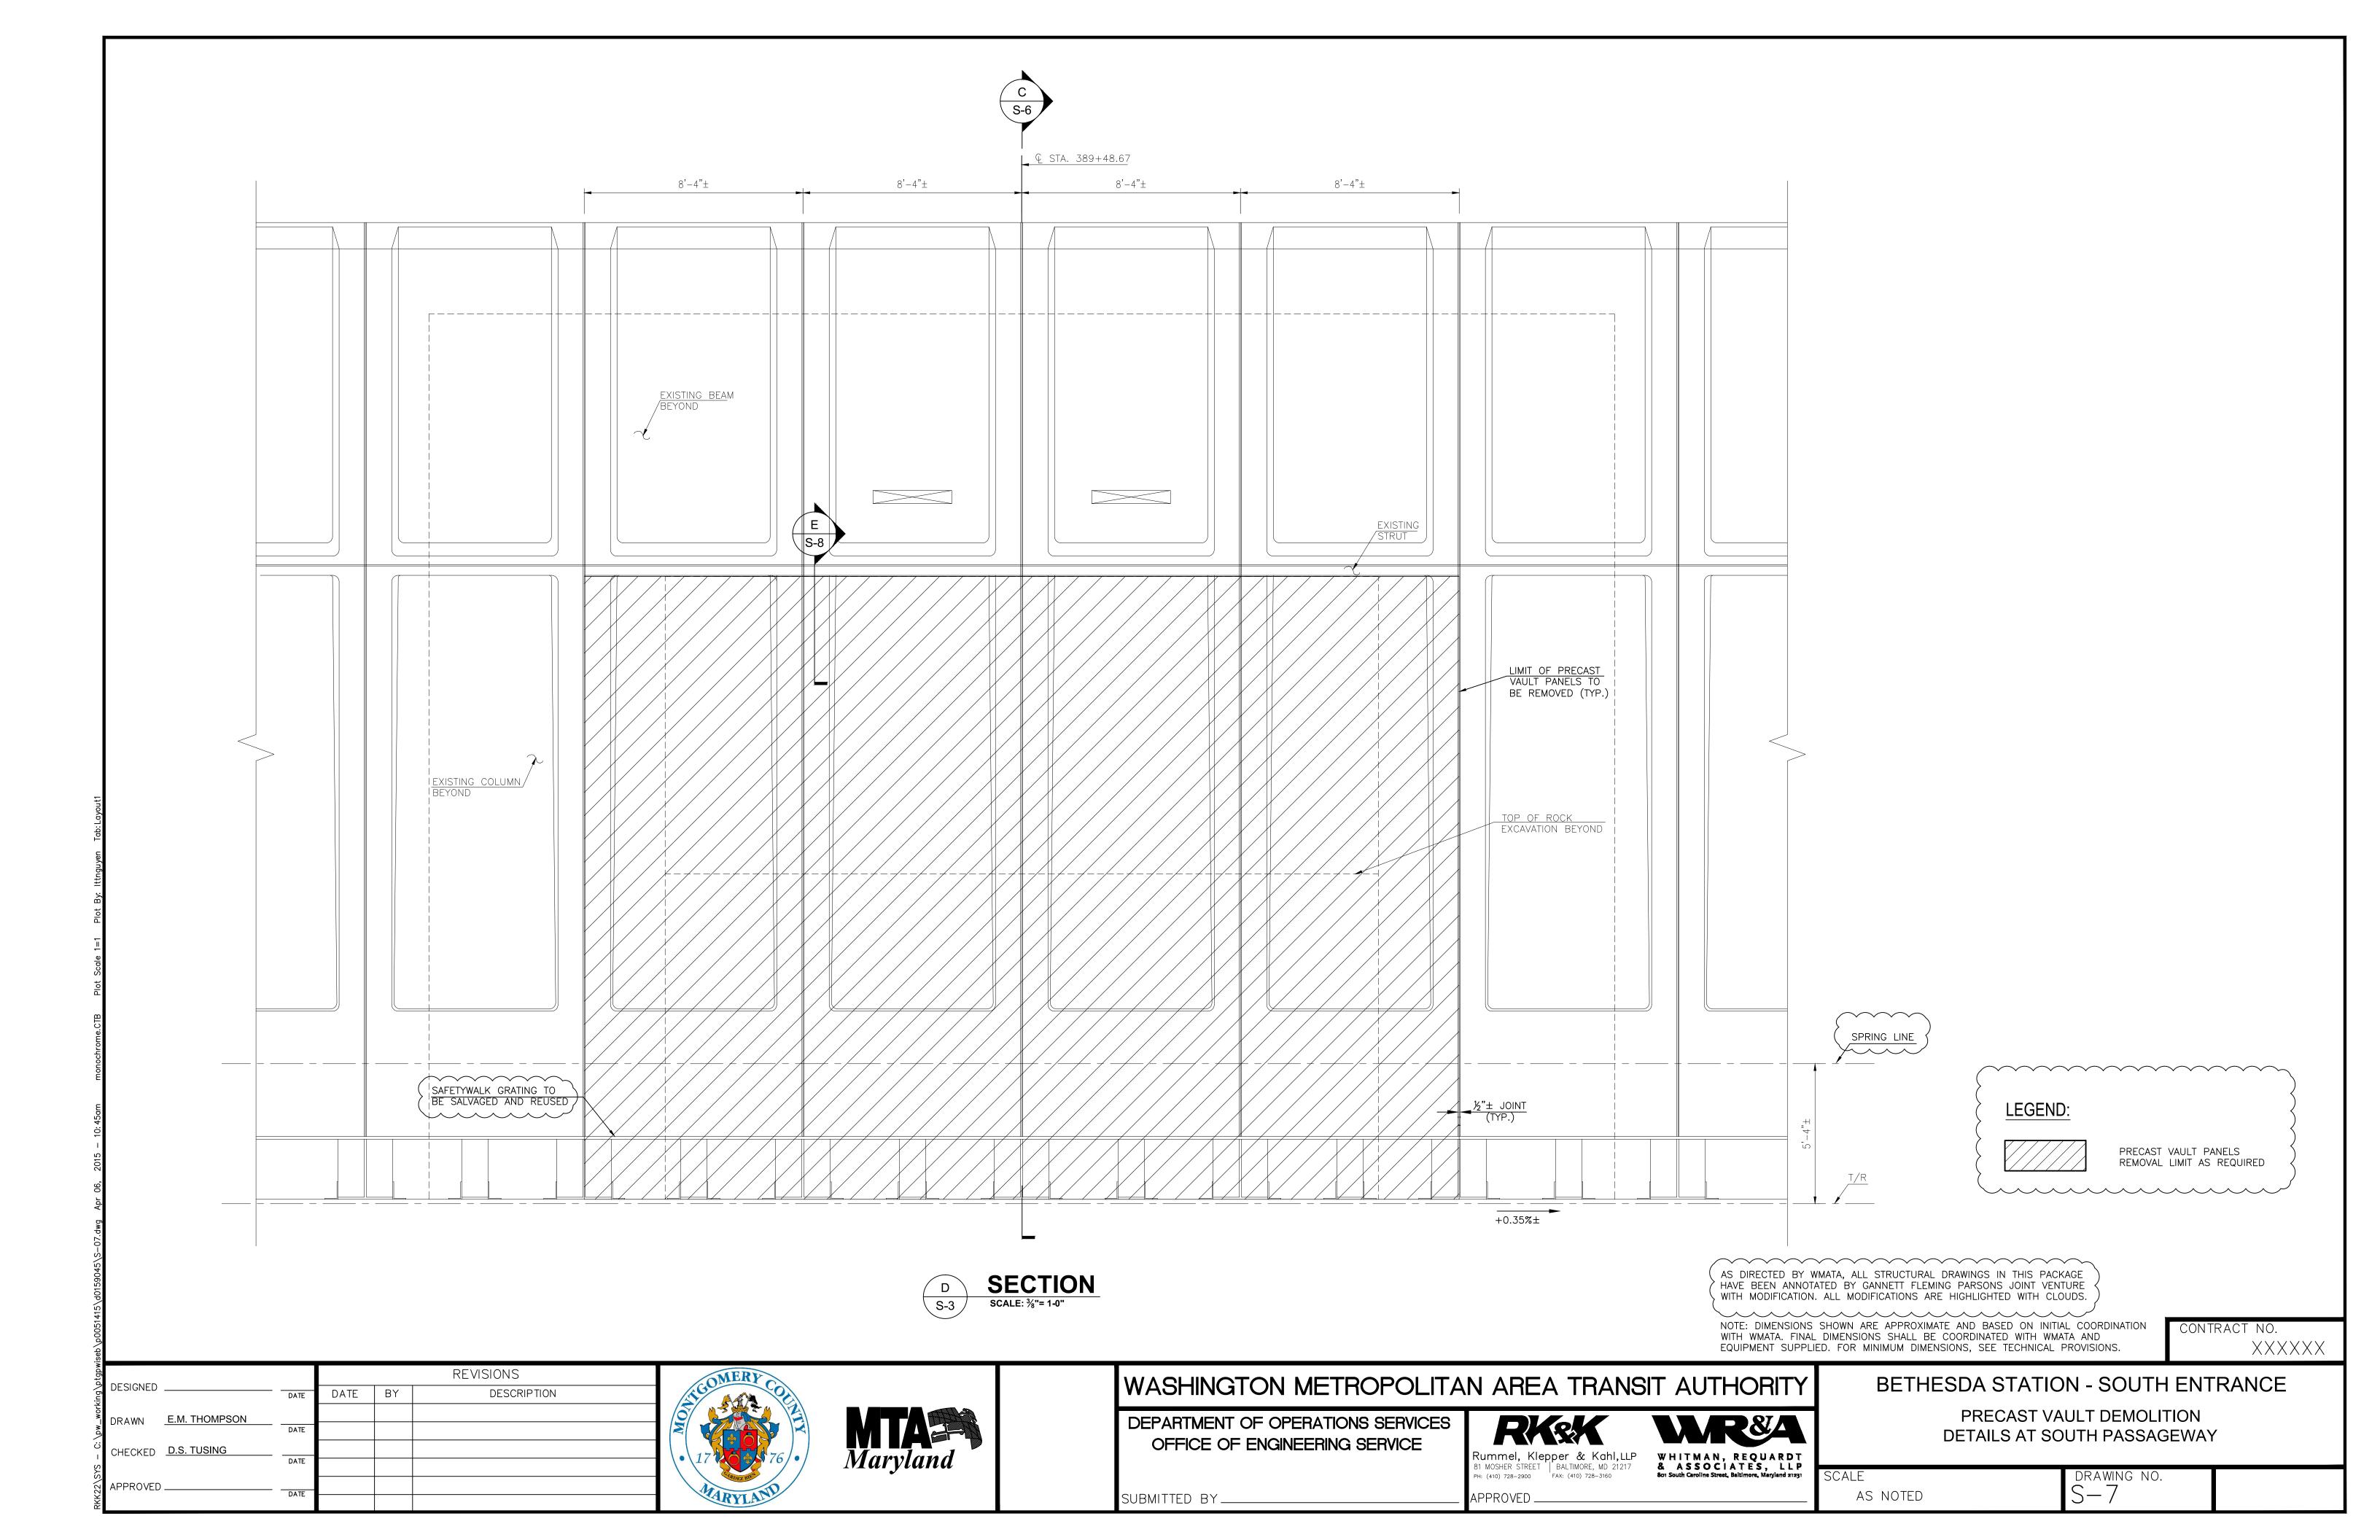
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81 MOSHER STREET | BALTIMORE, MD 21217
PH: (410) 728-2900 FAX: (410) 728-3160 WHITMAN, REQUARDT
& ASSOCIATES, LLP
801 South Caroline Street, Baltimore, Maryland 21231


BETHESDA STATION - SOUTH ENTRANCE BETHESDA STATION PLATFORM DEMOLITION PLAN AND SECTIONS STA. 391+07 TO STA. 389+07


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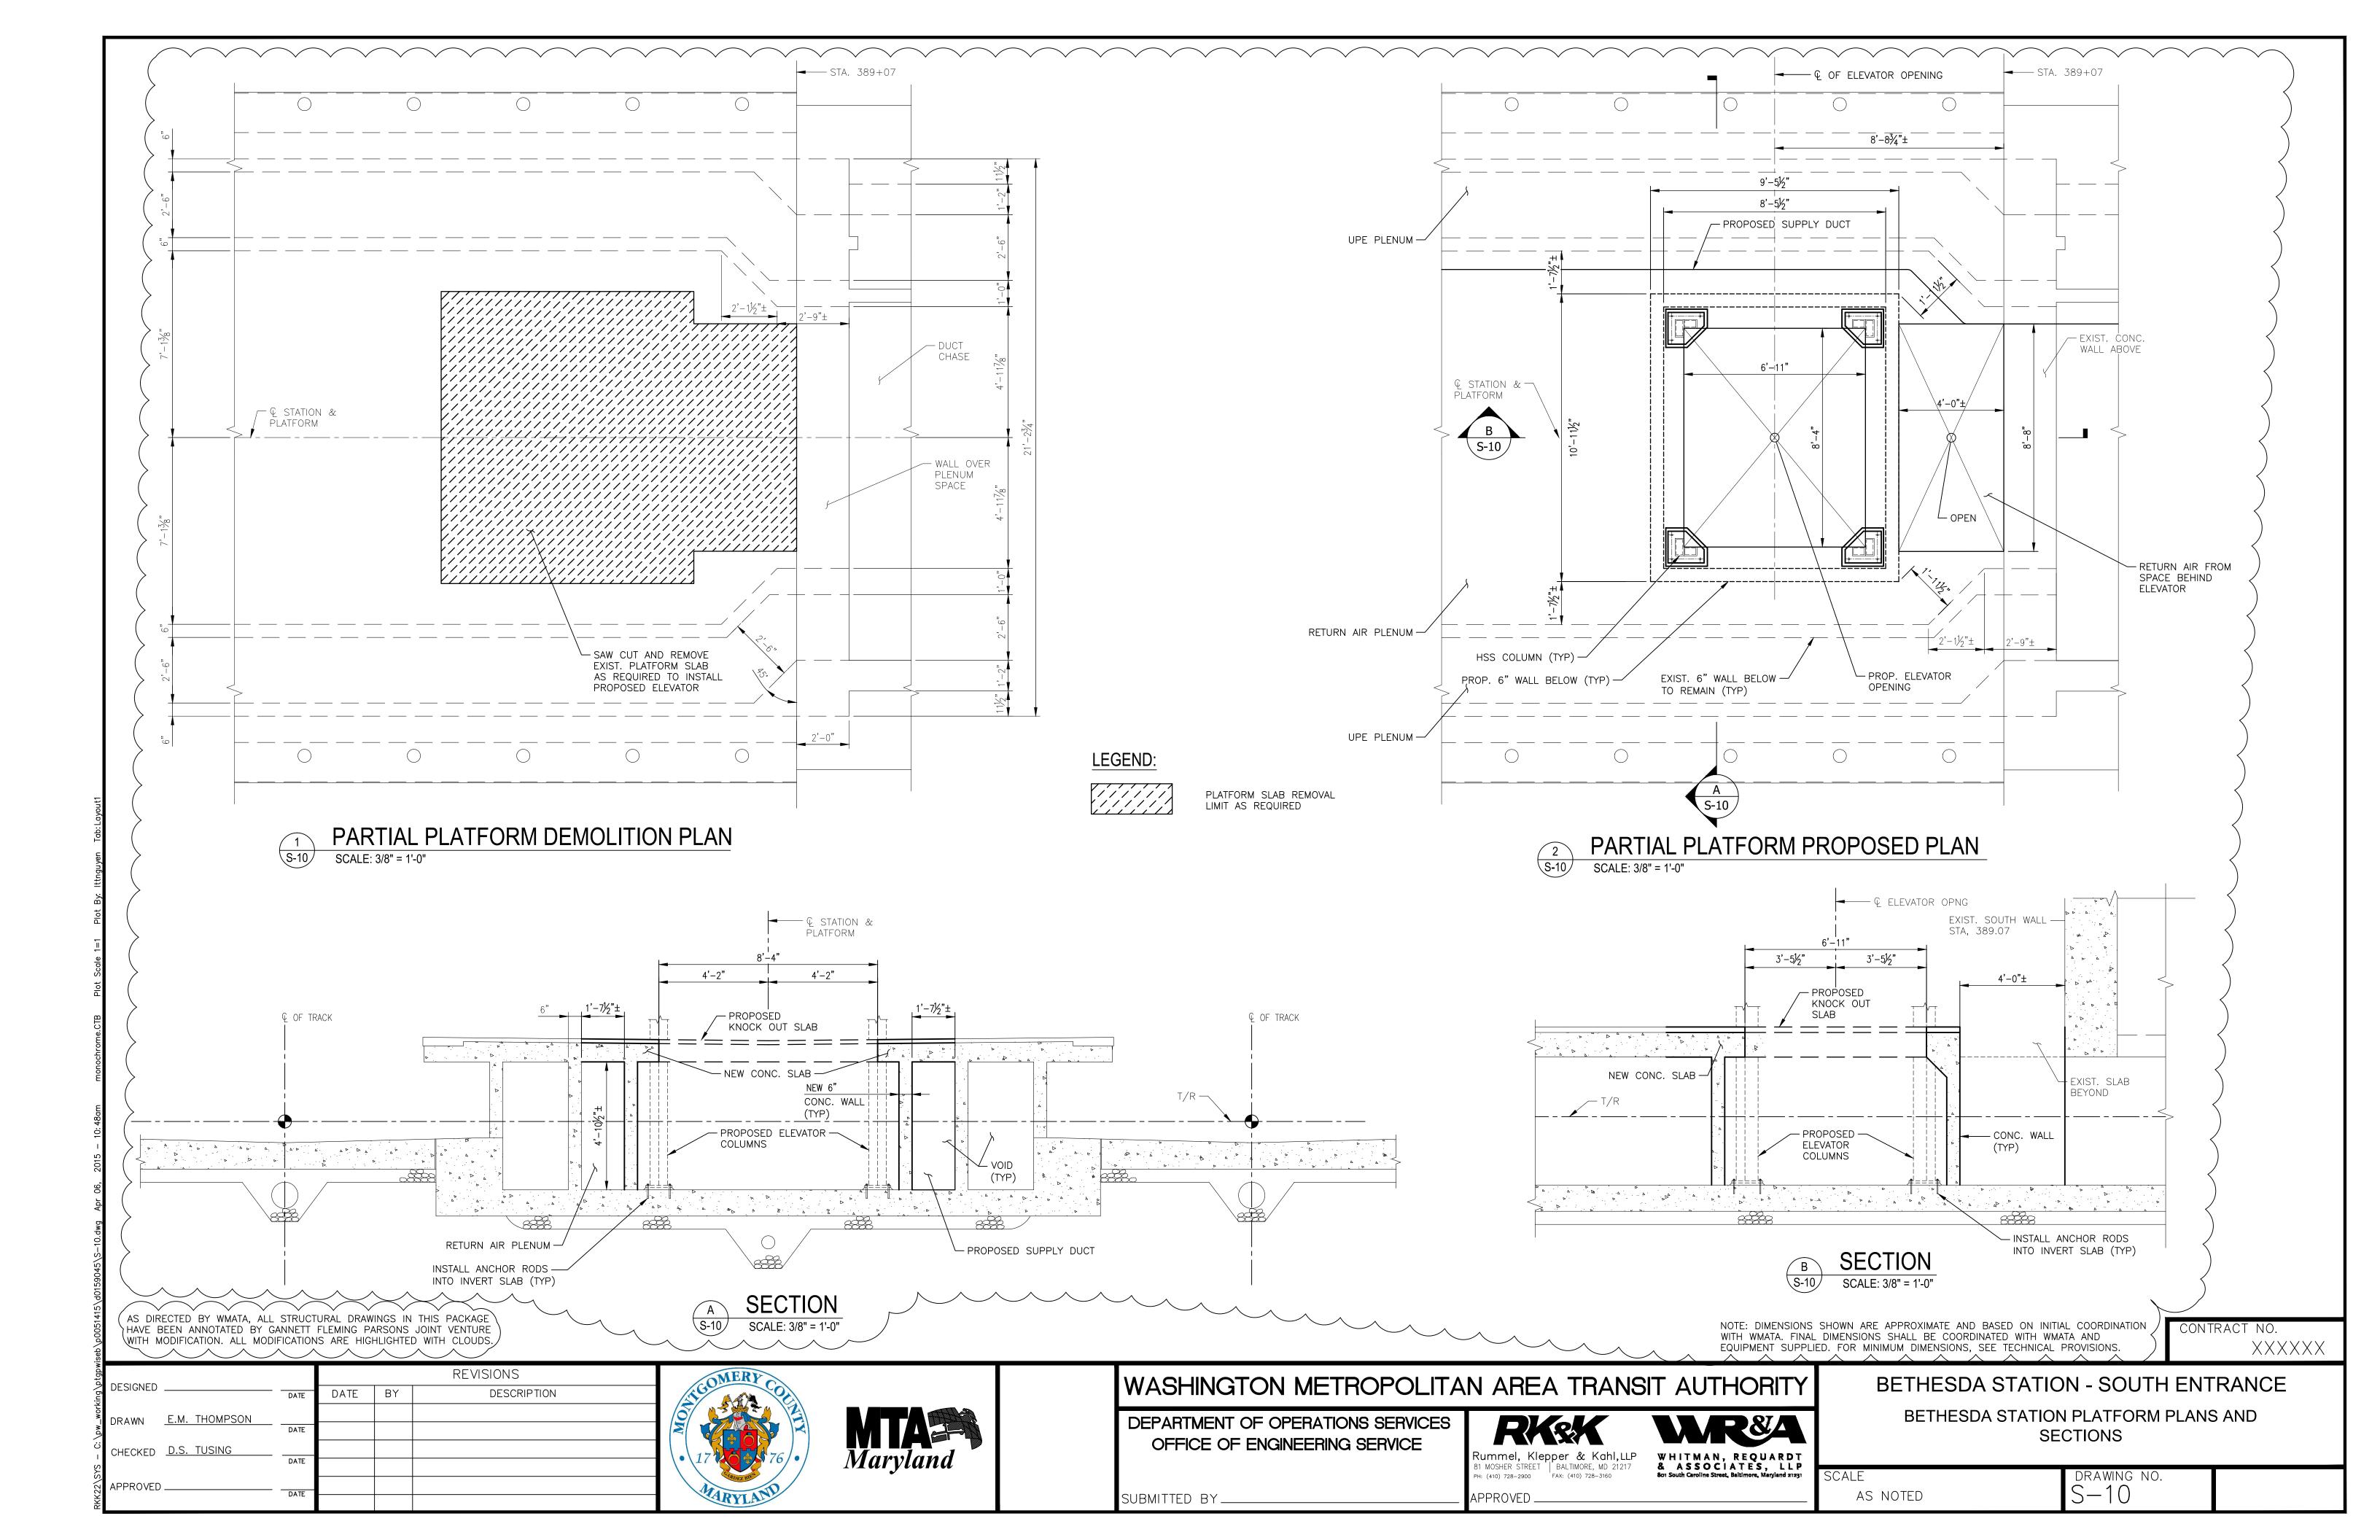








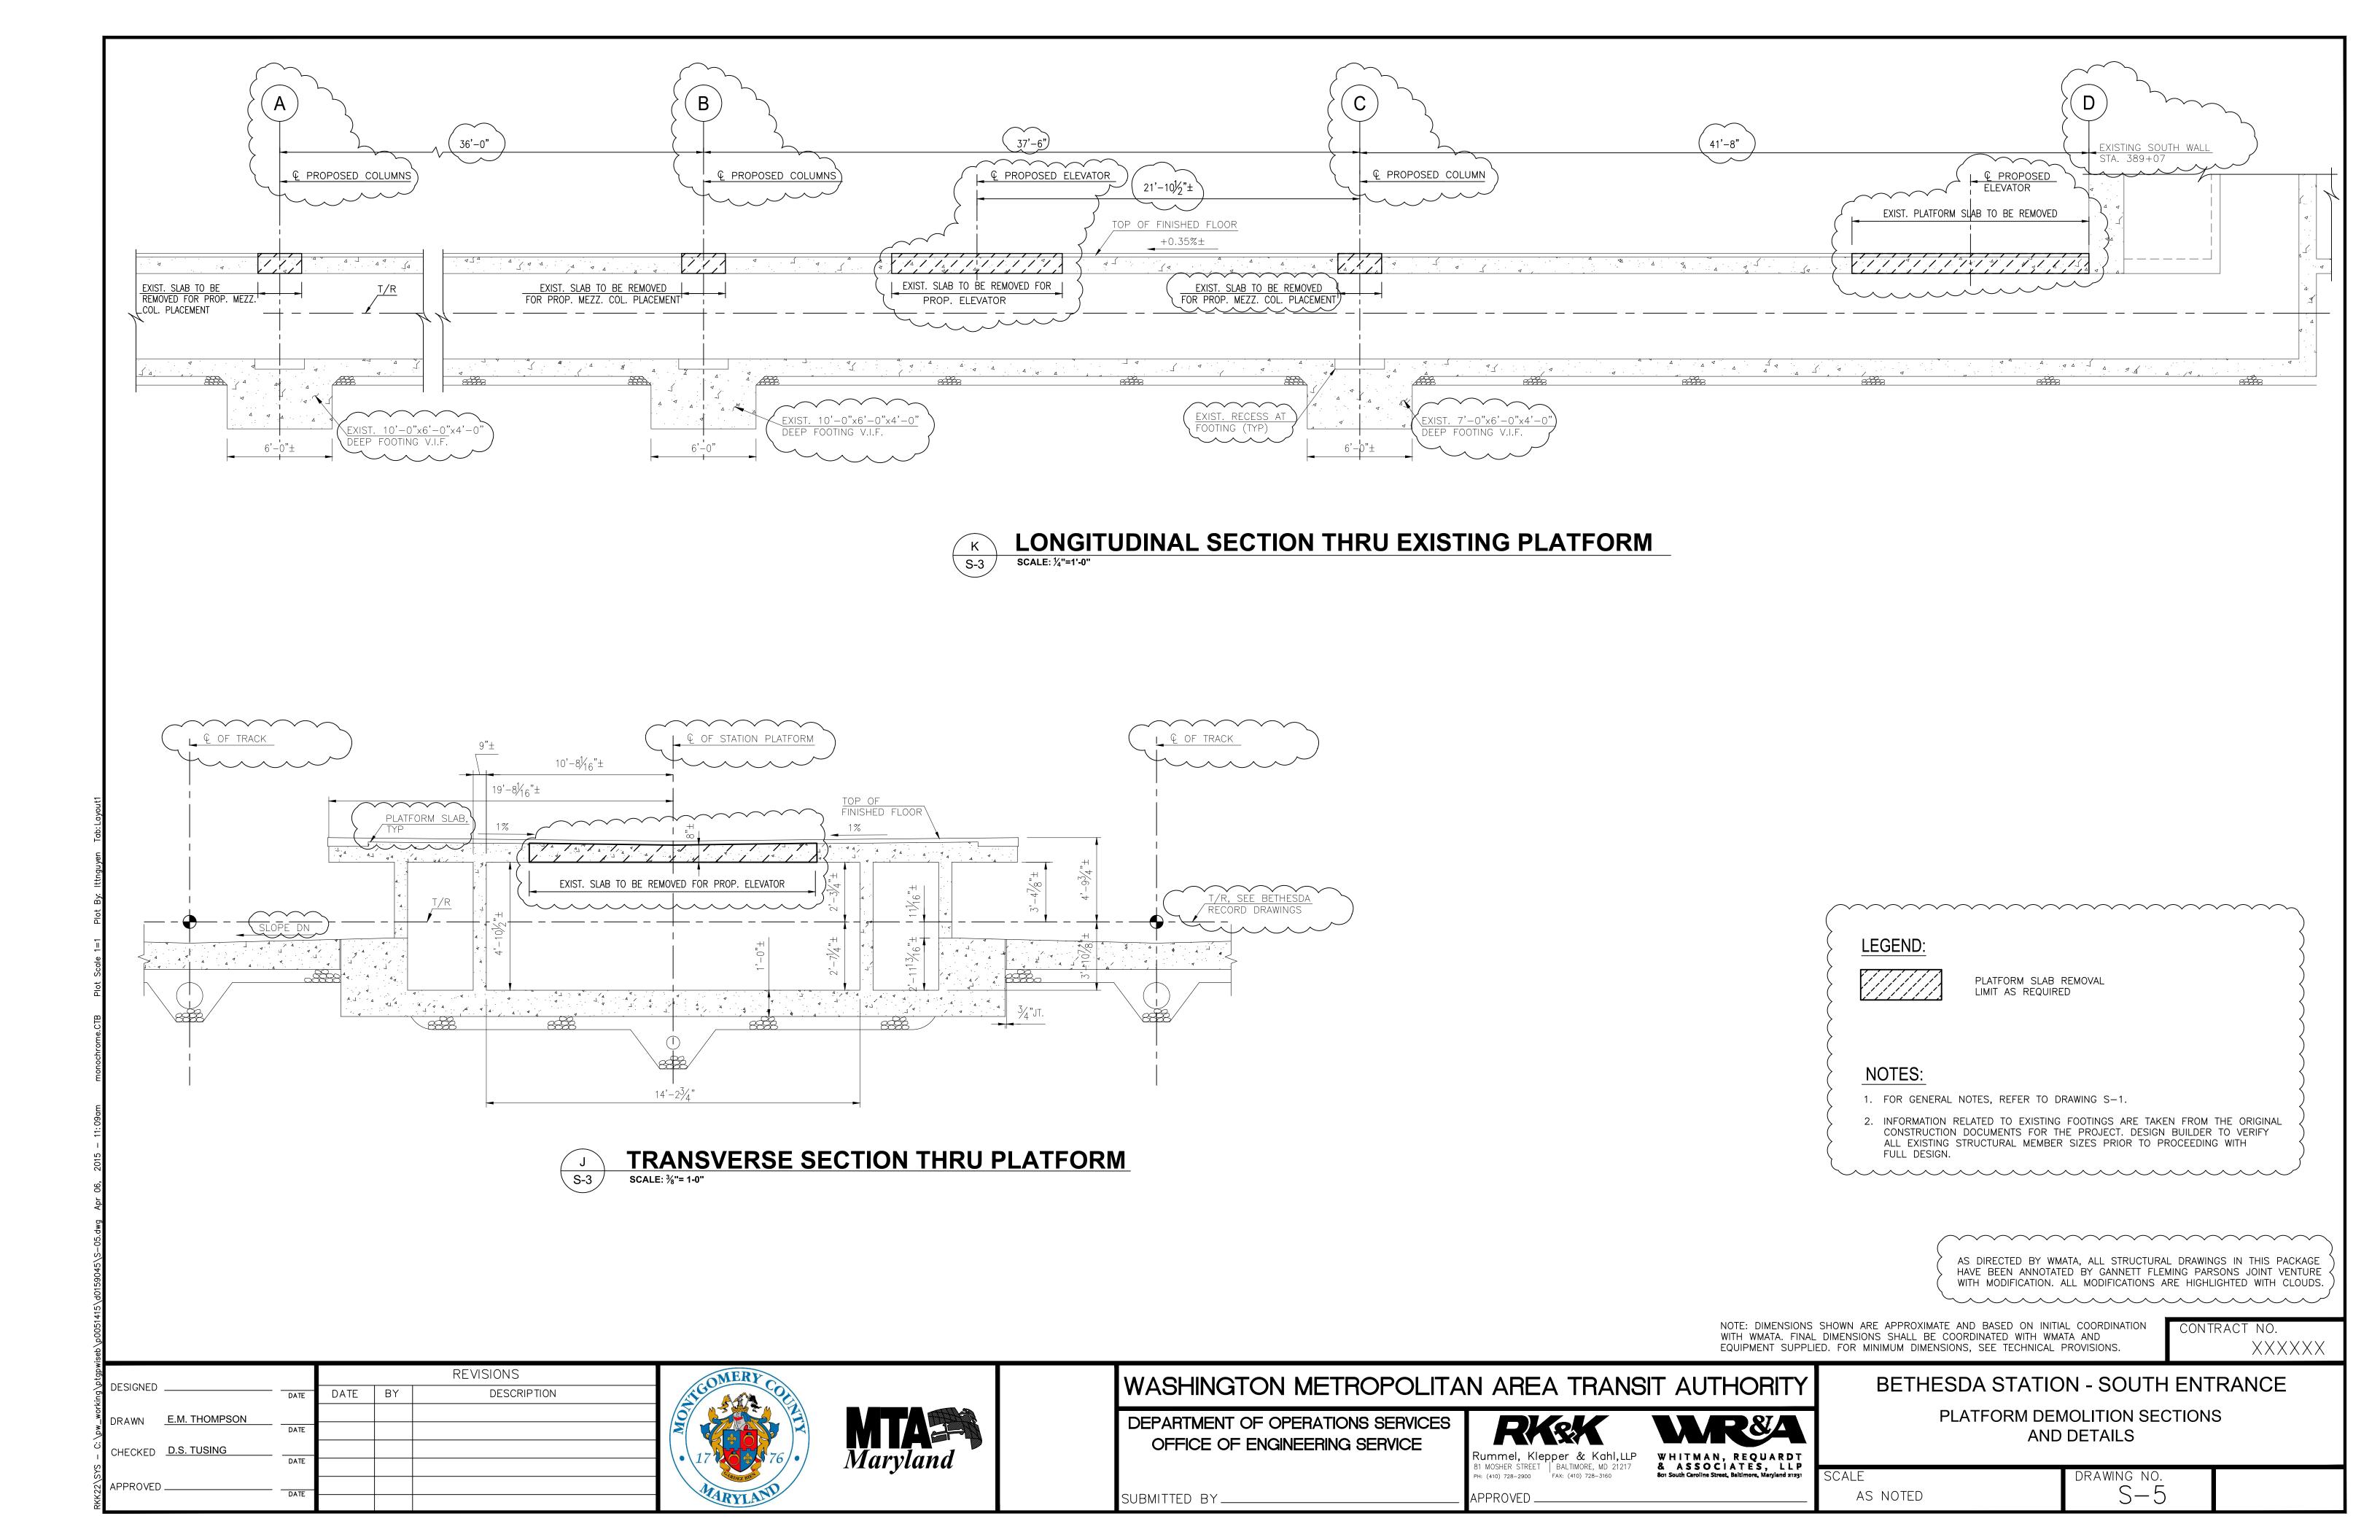


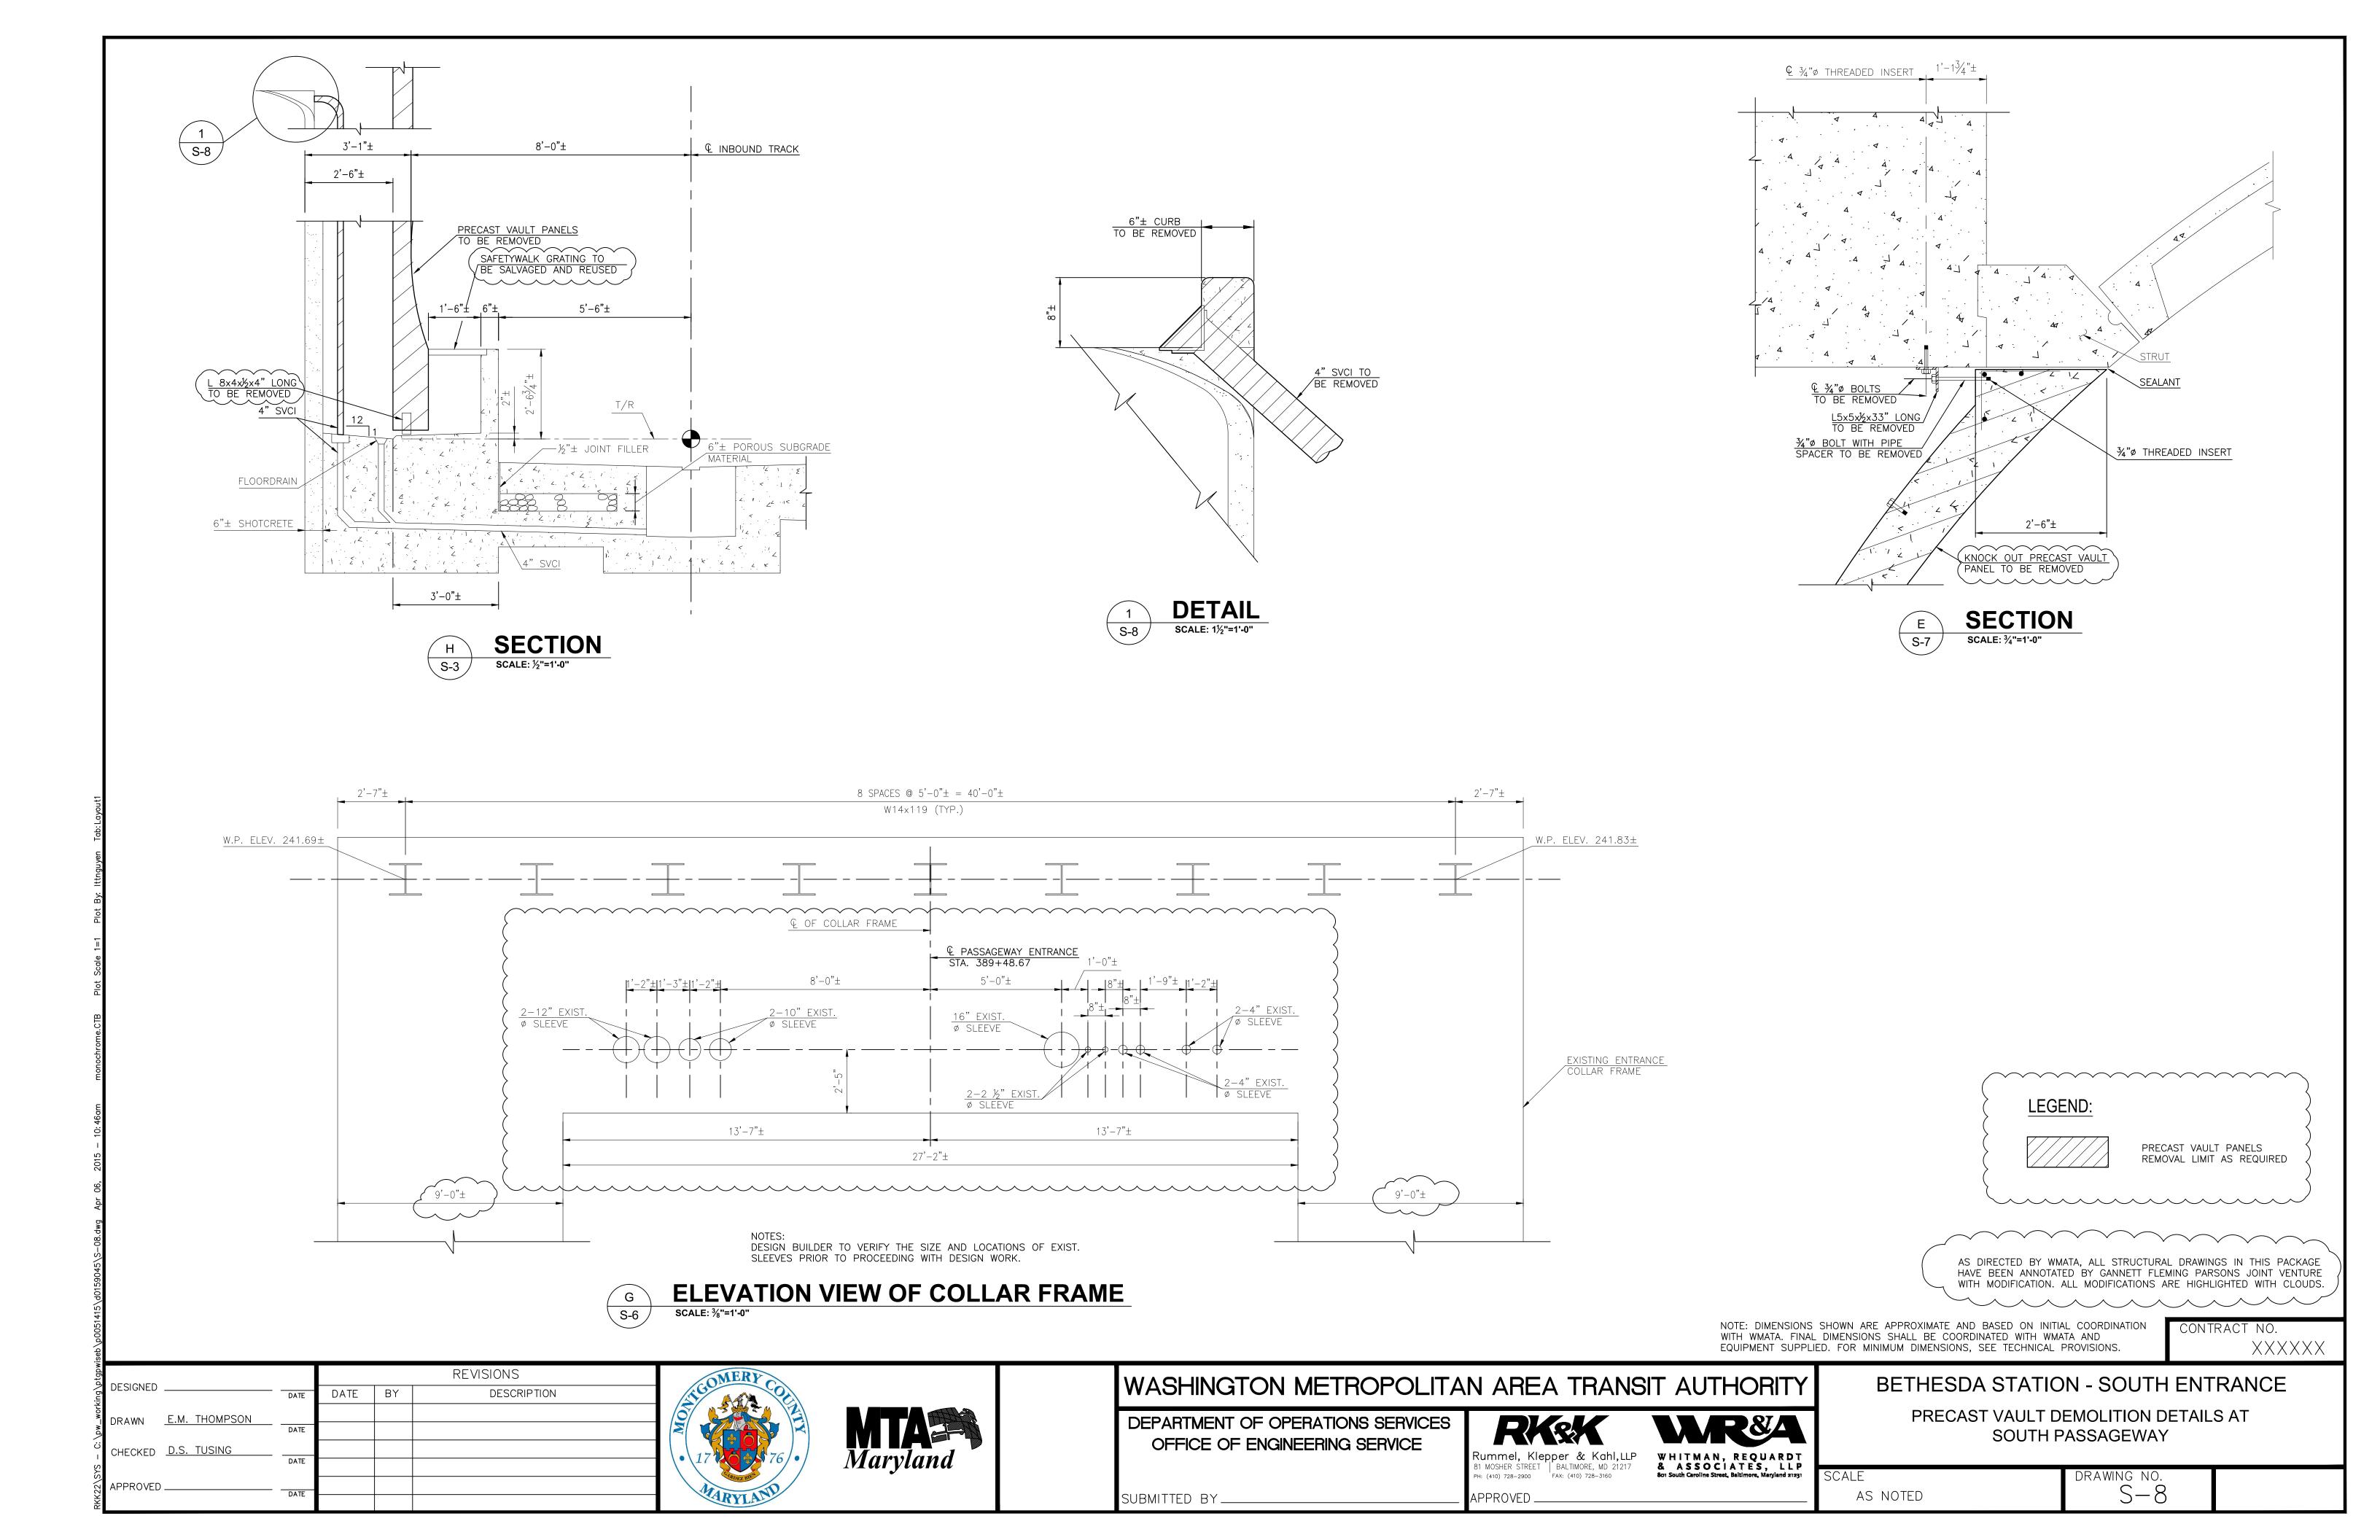


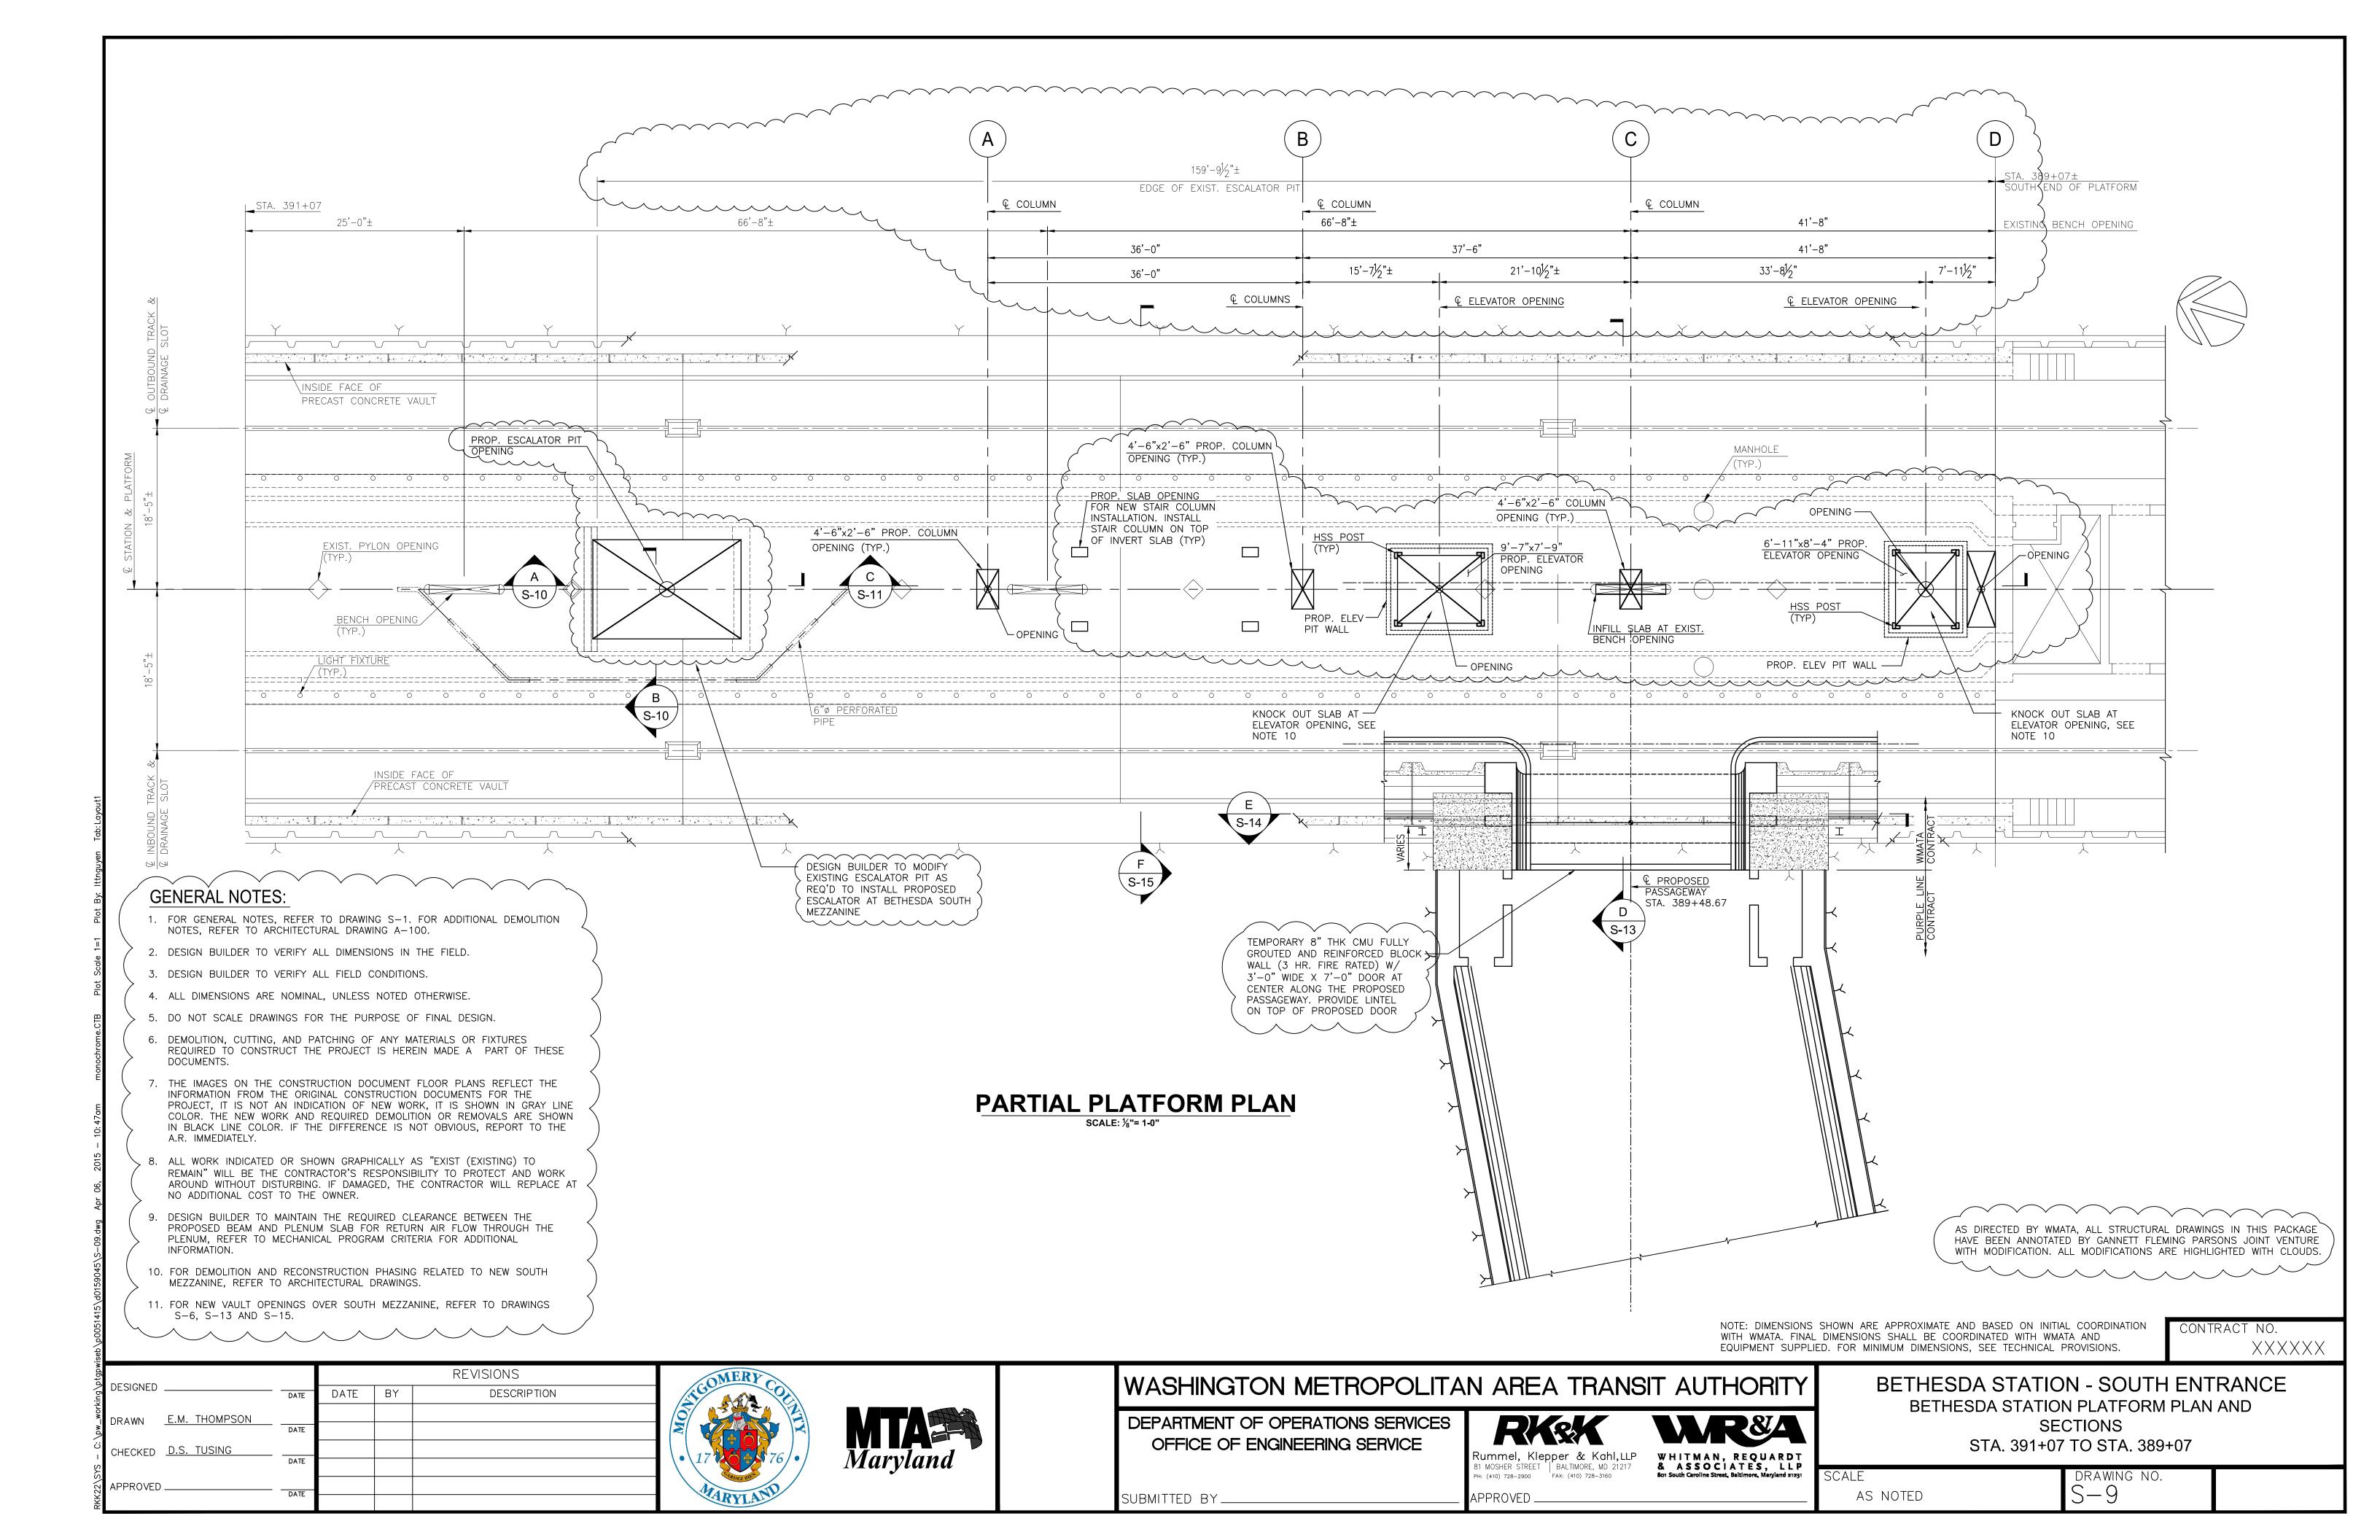


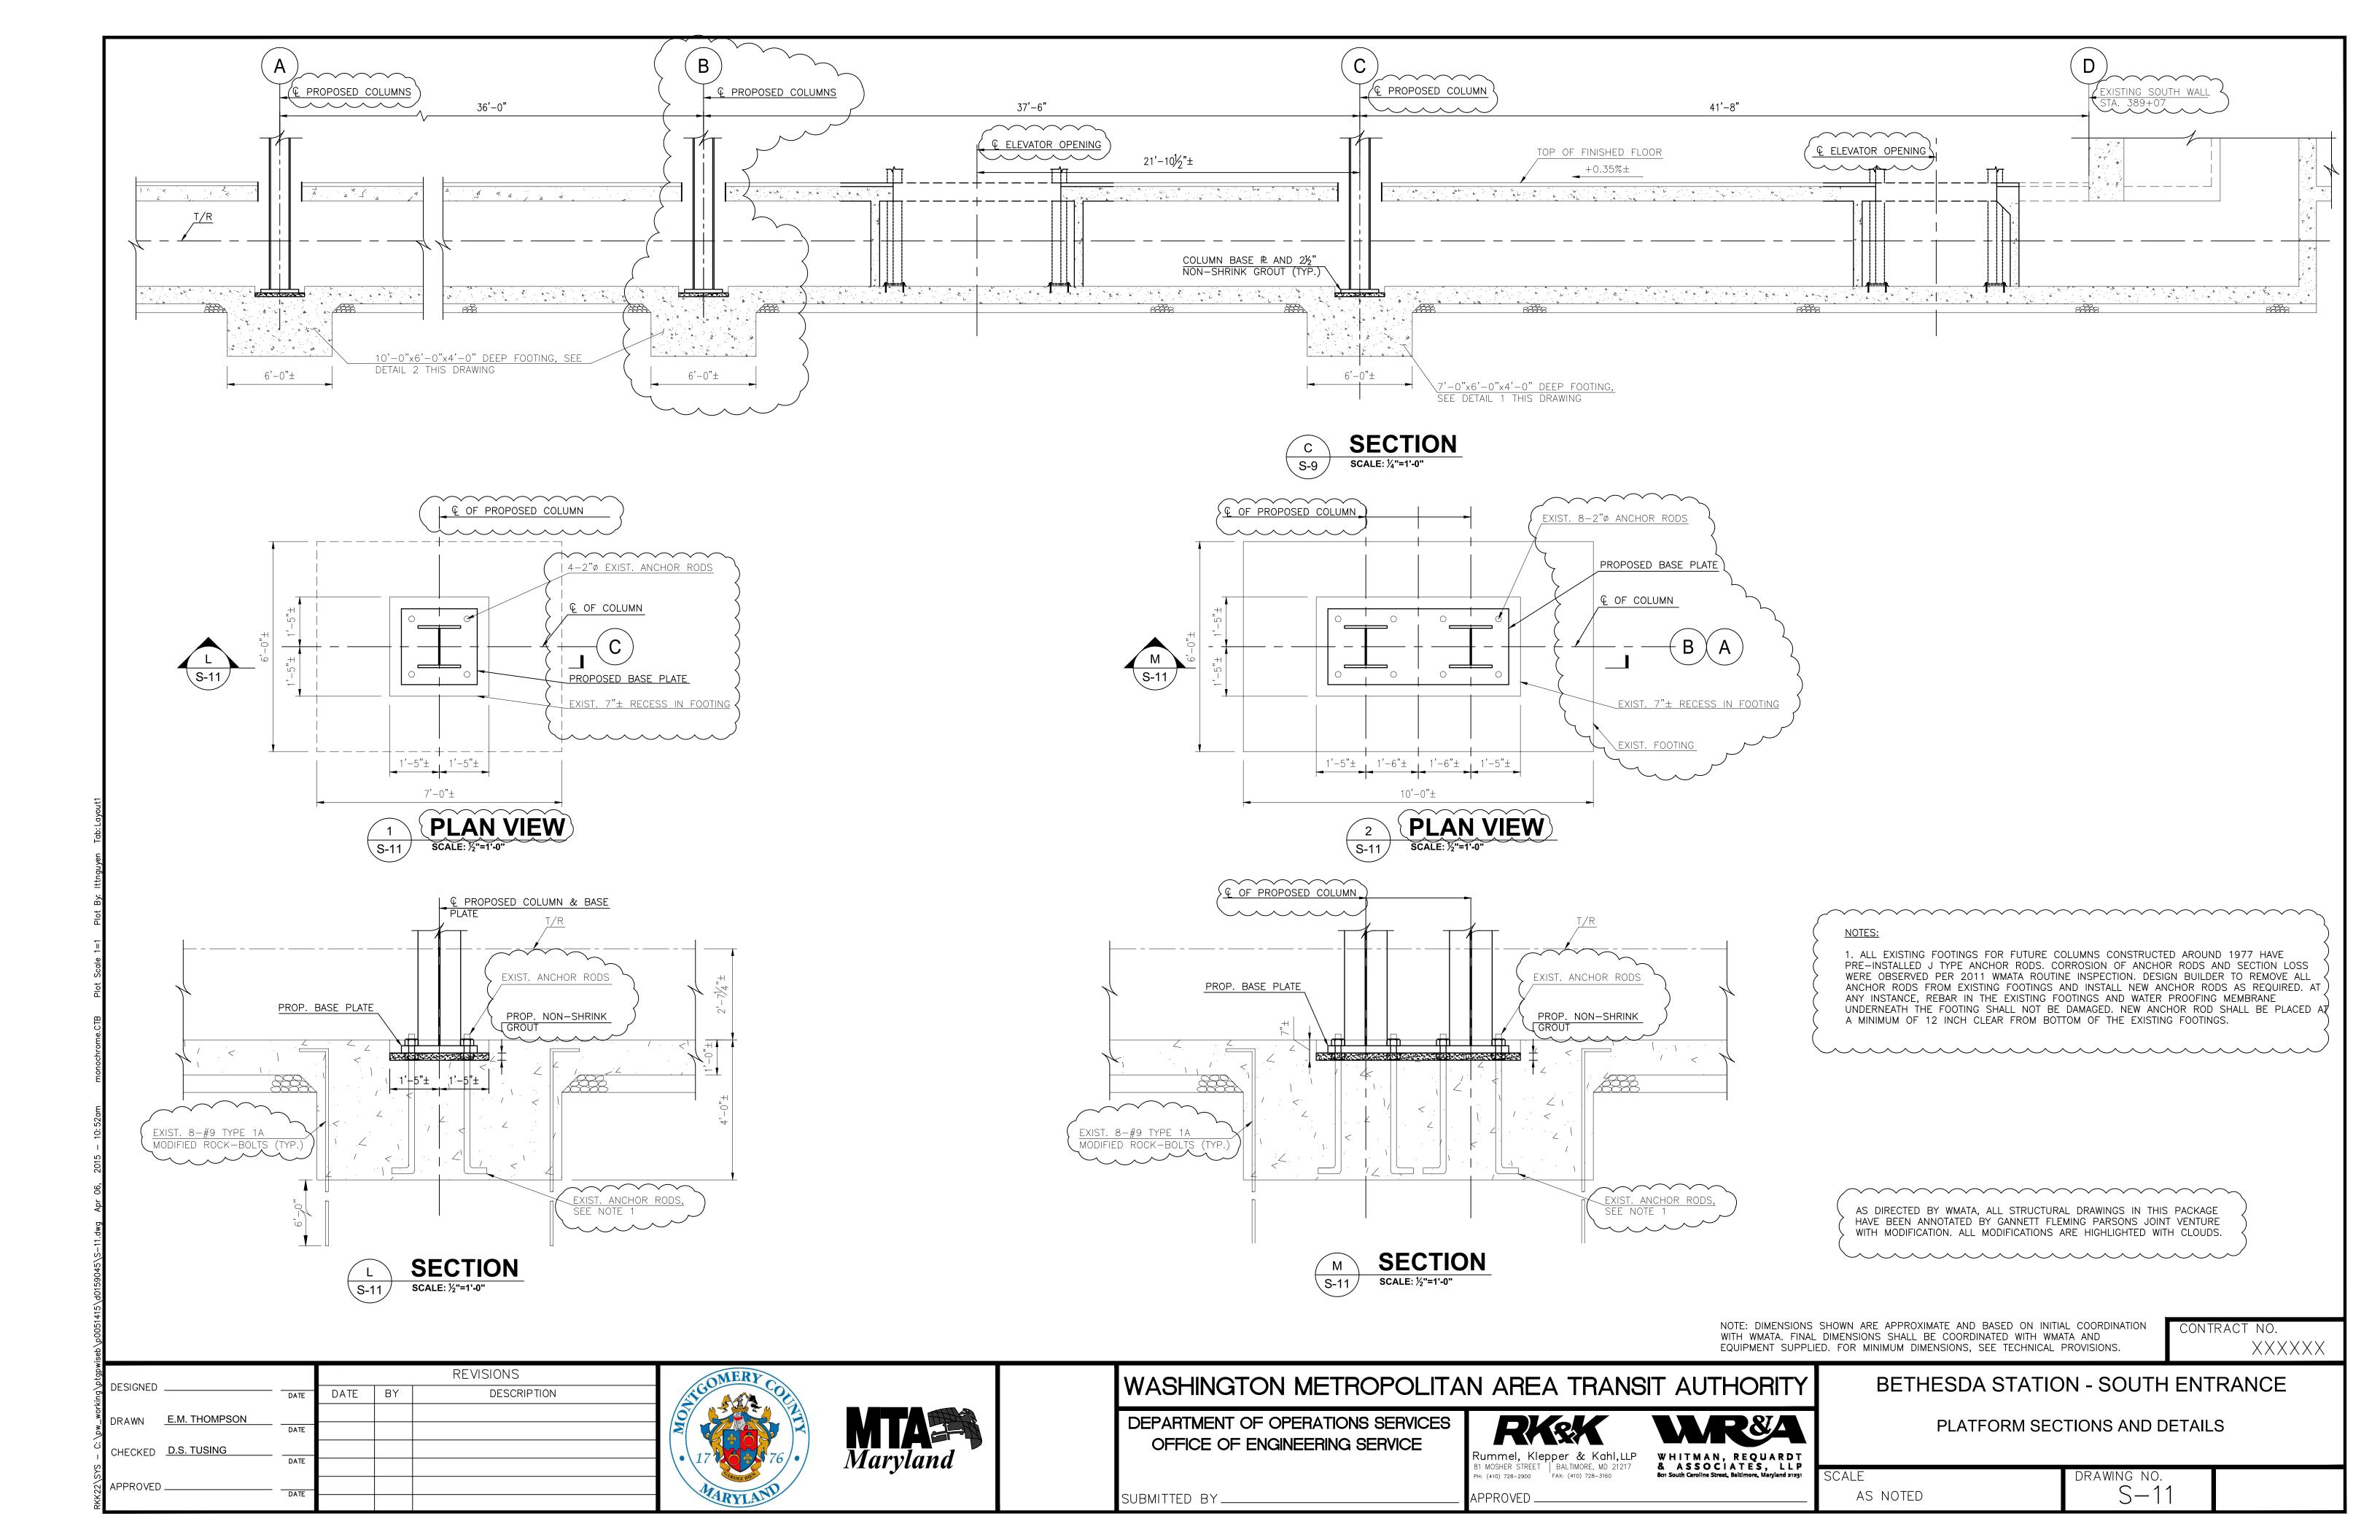


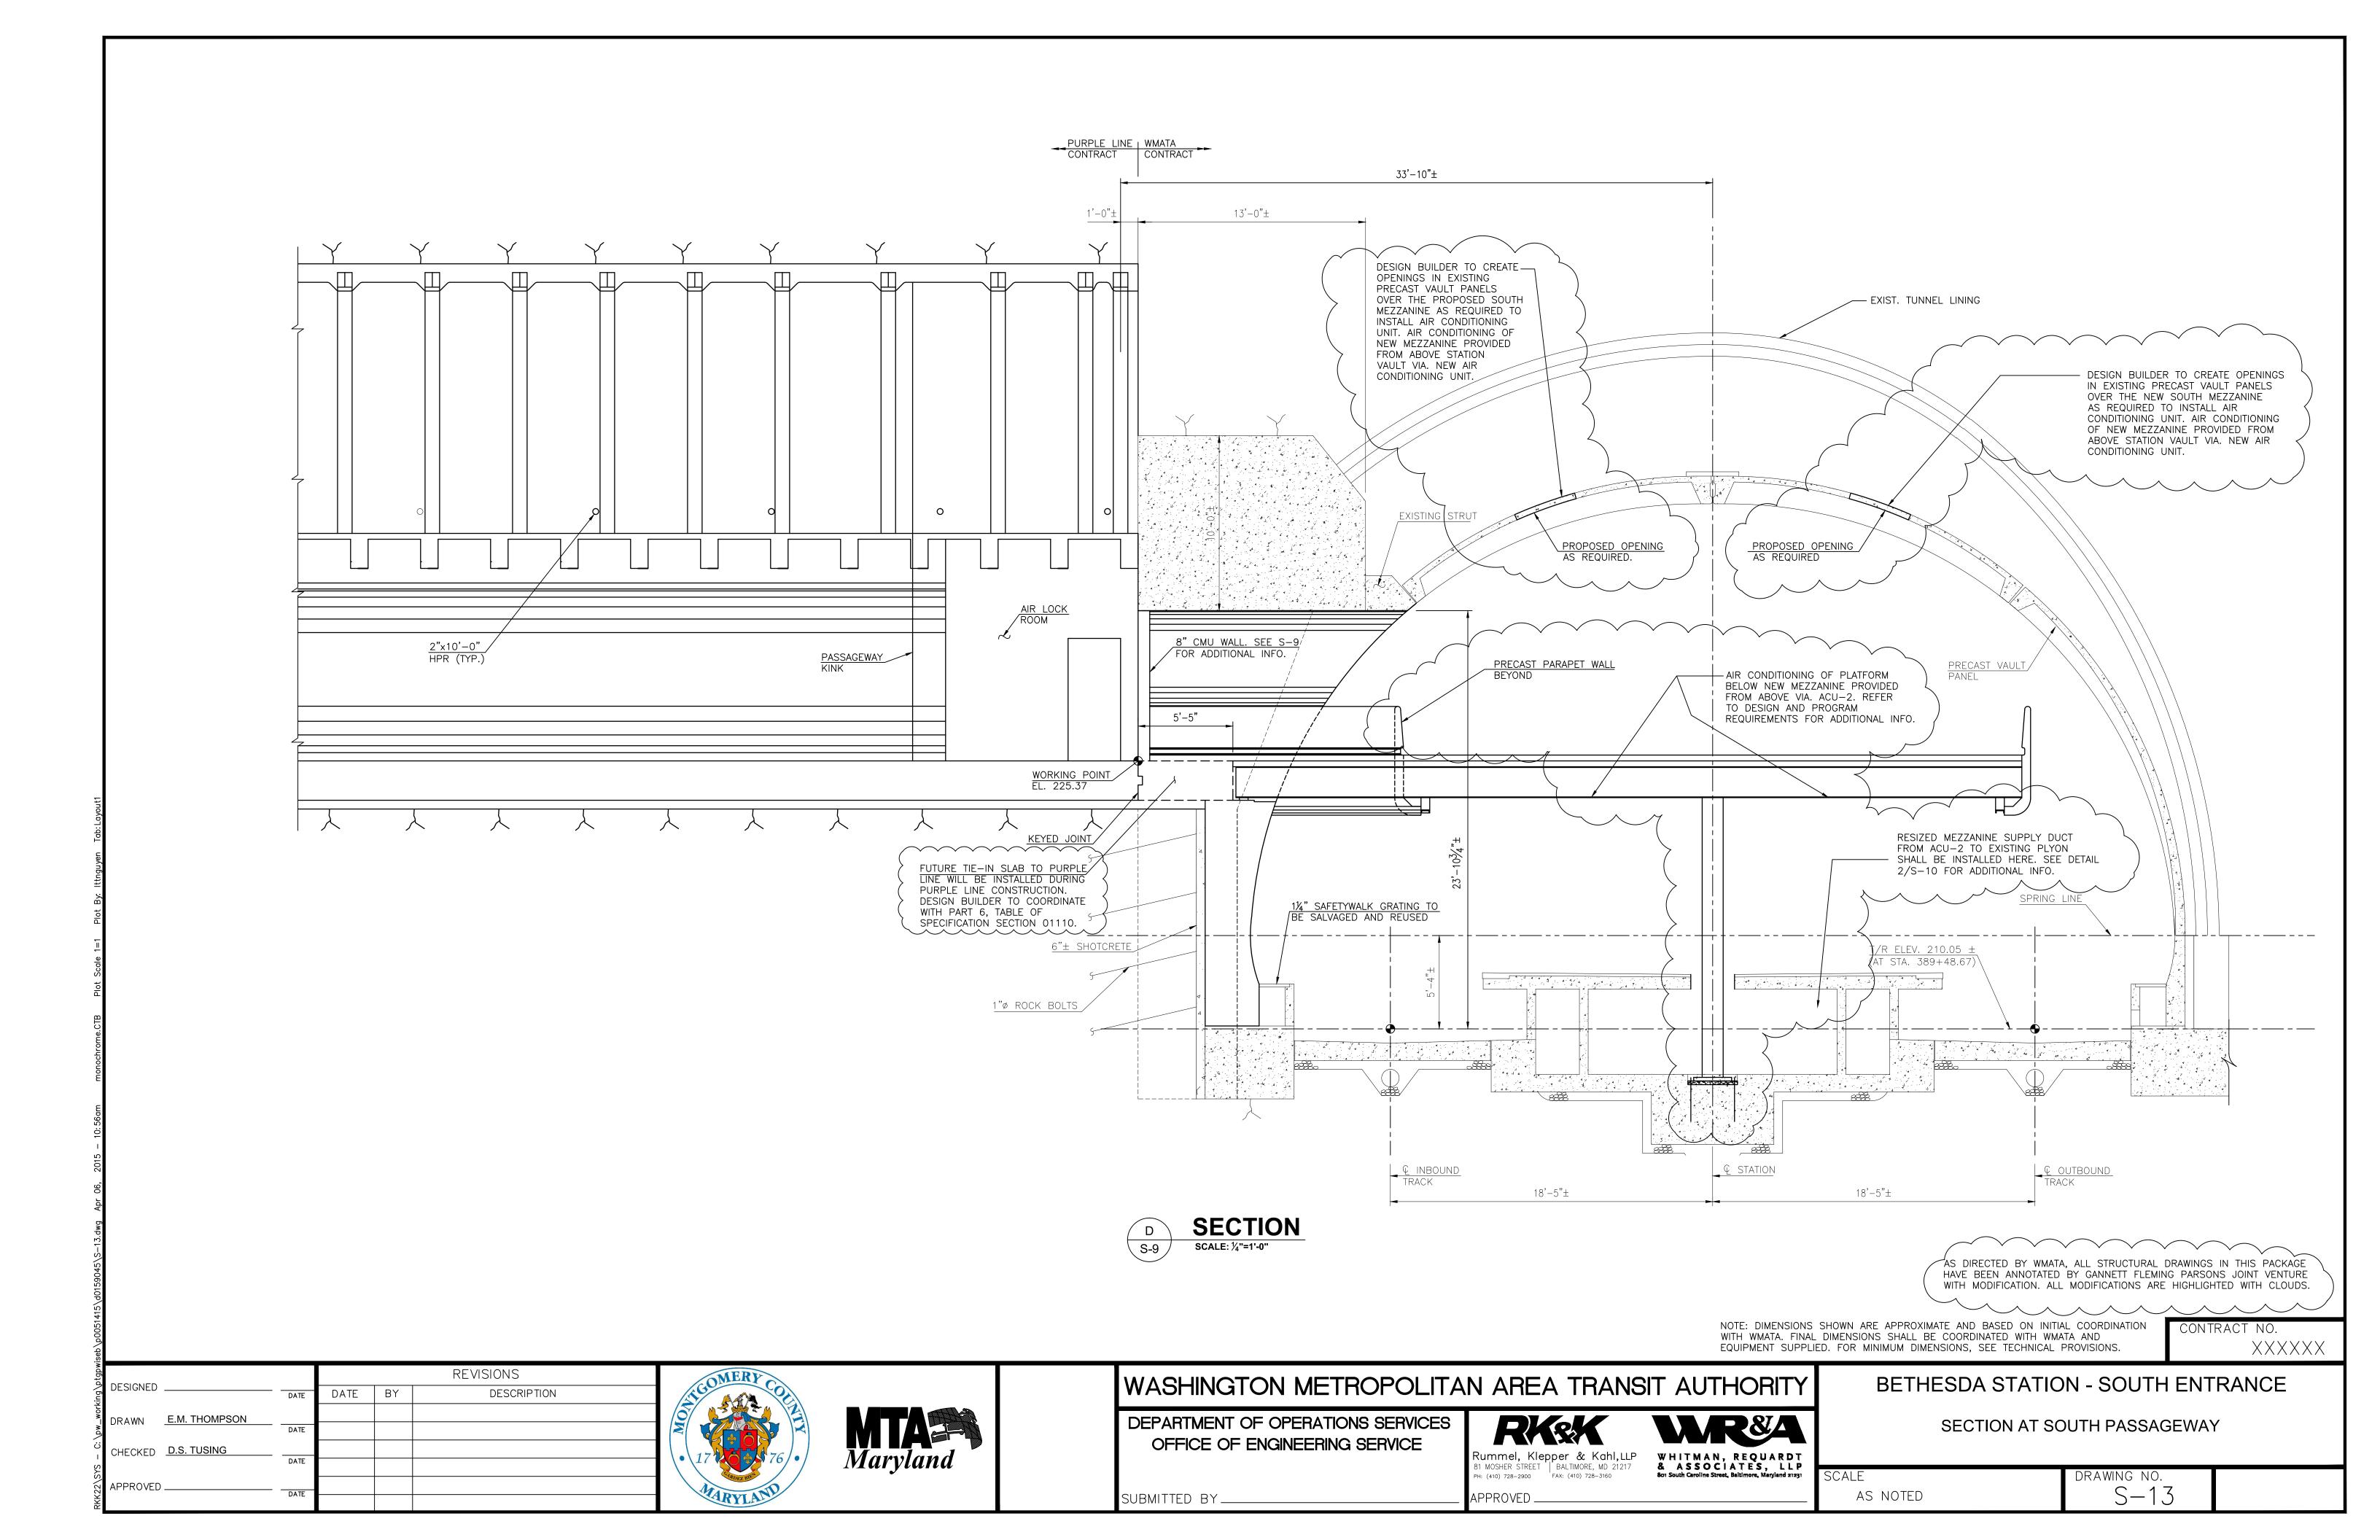

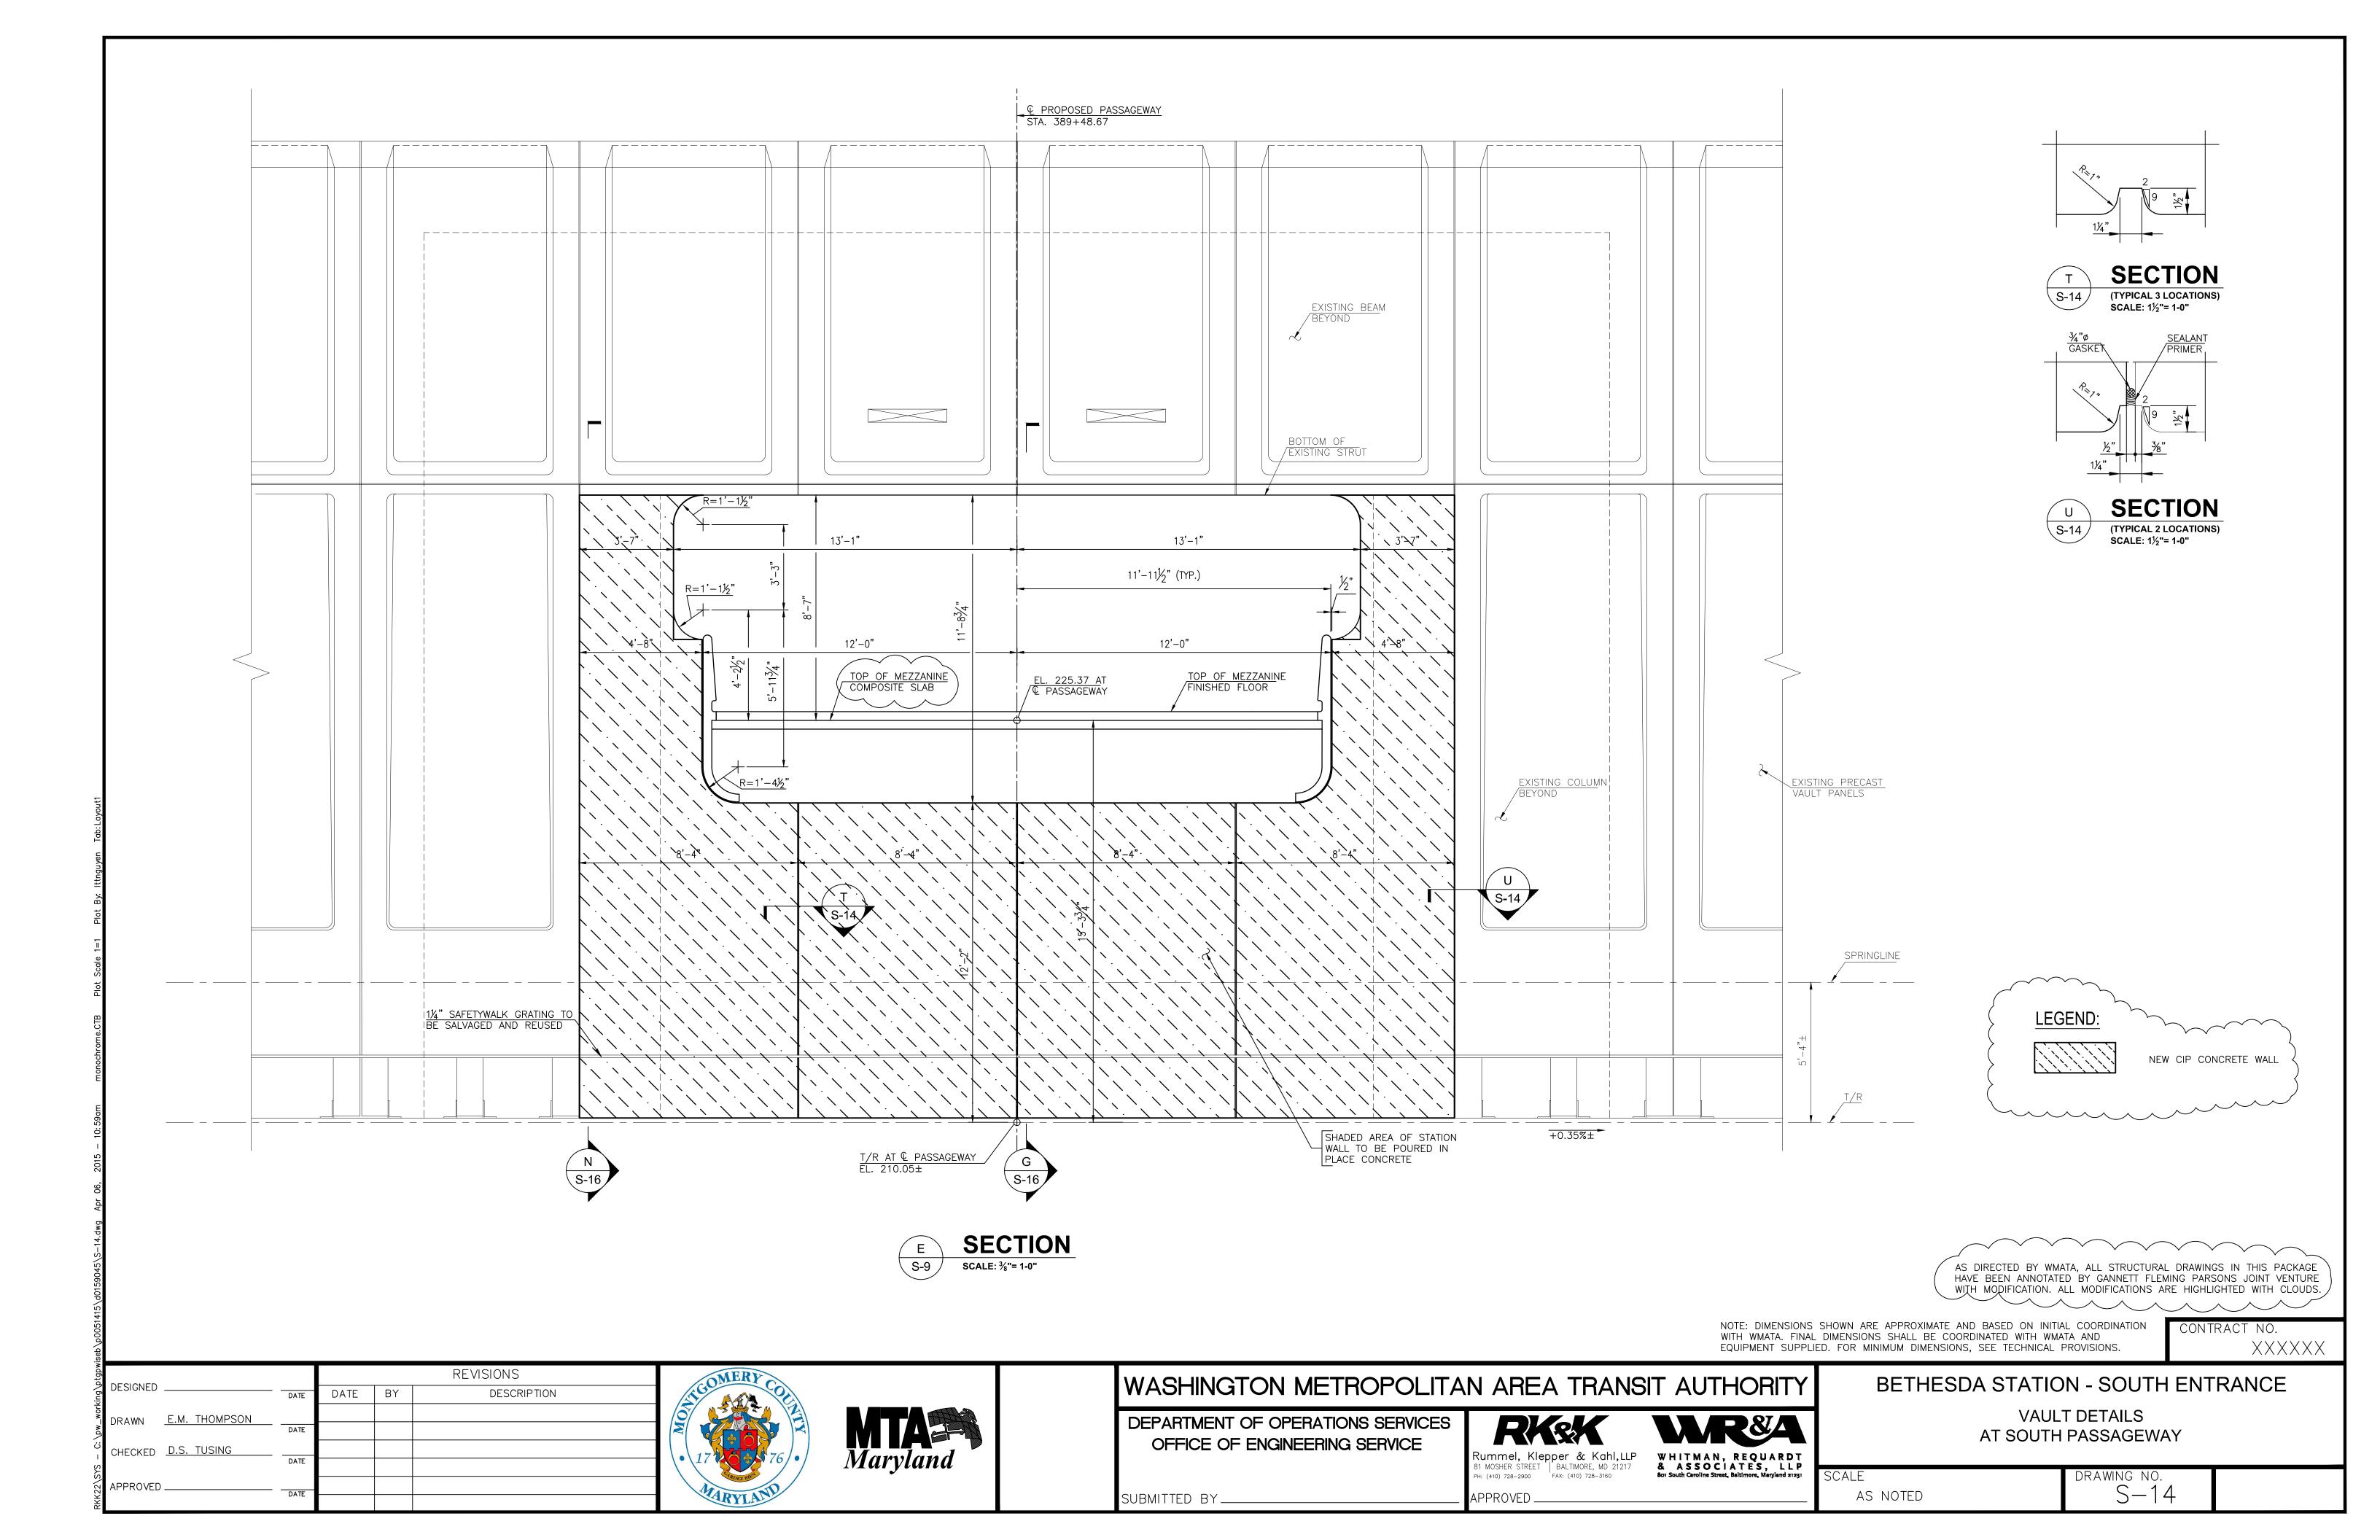

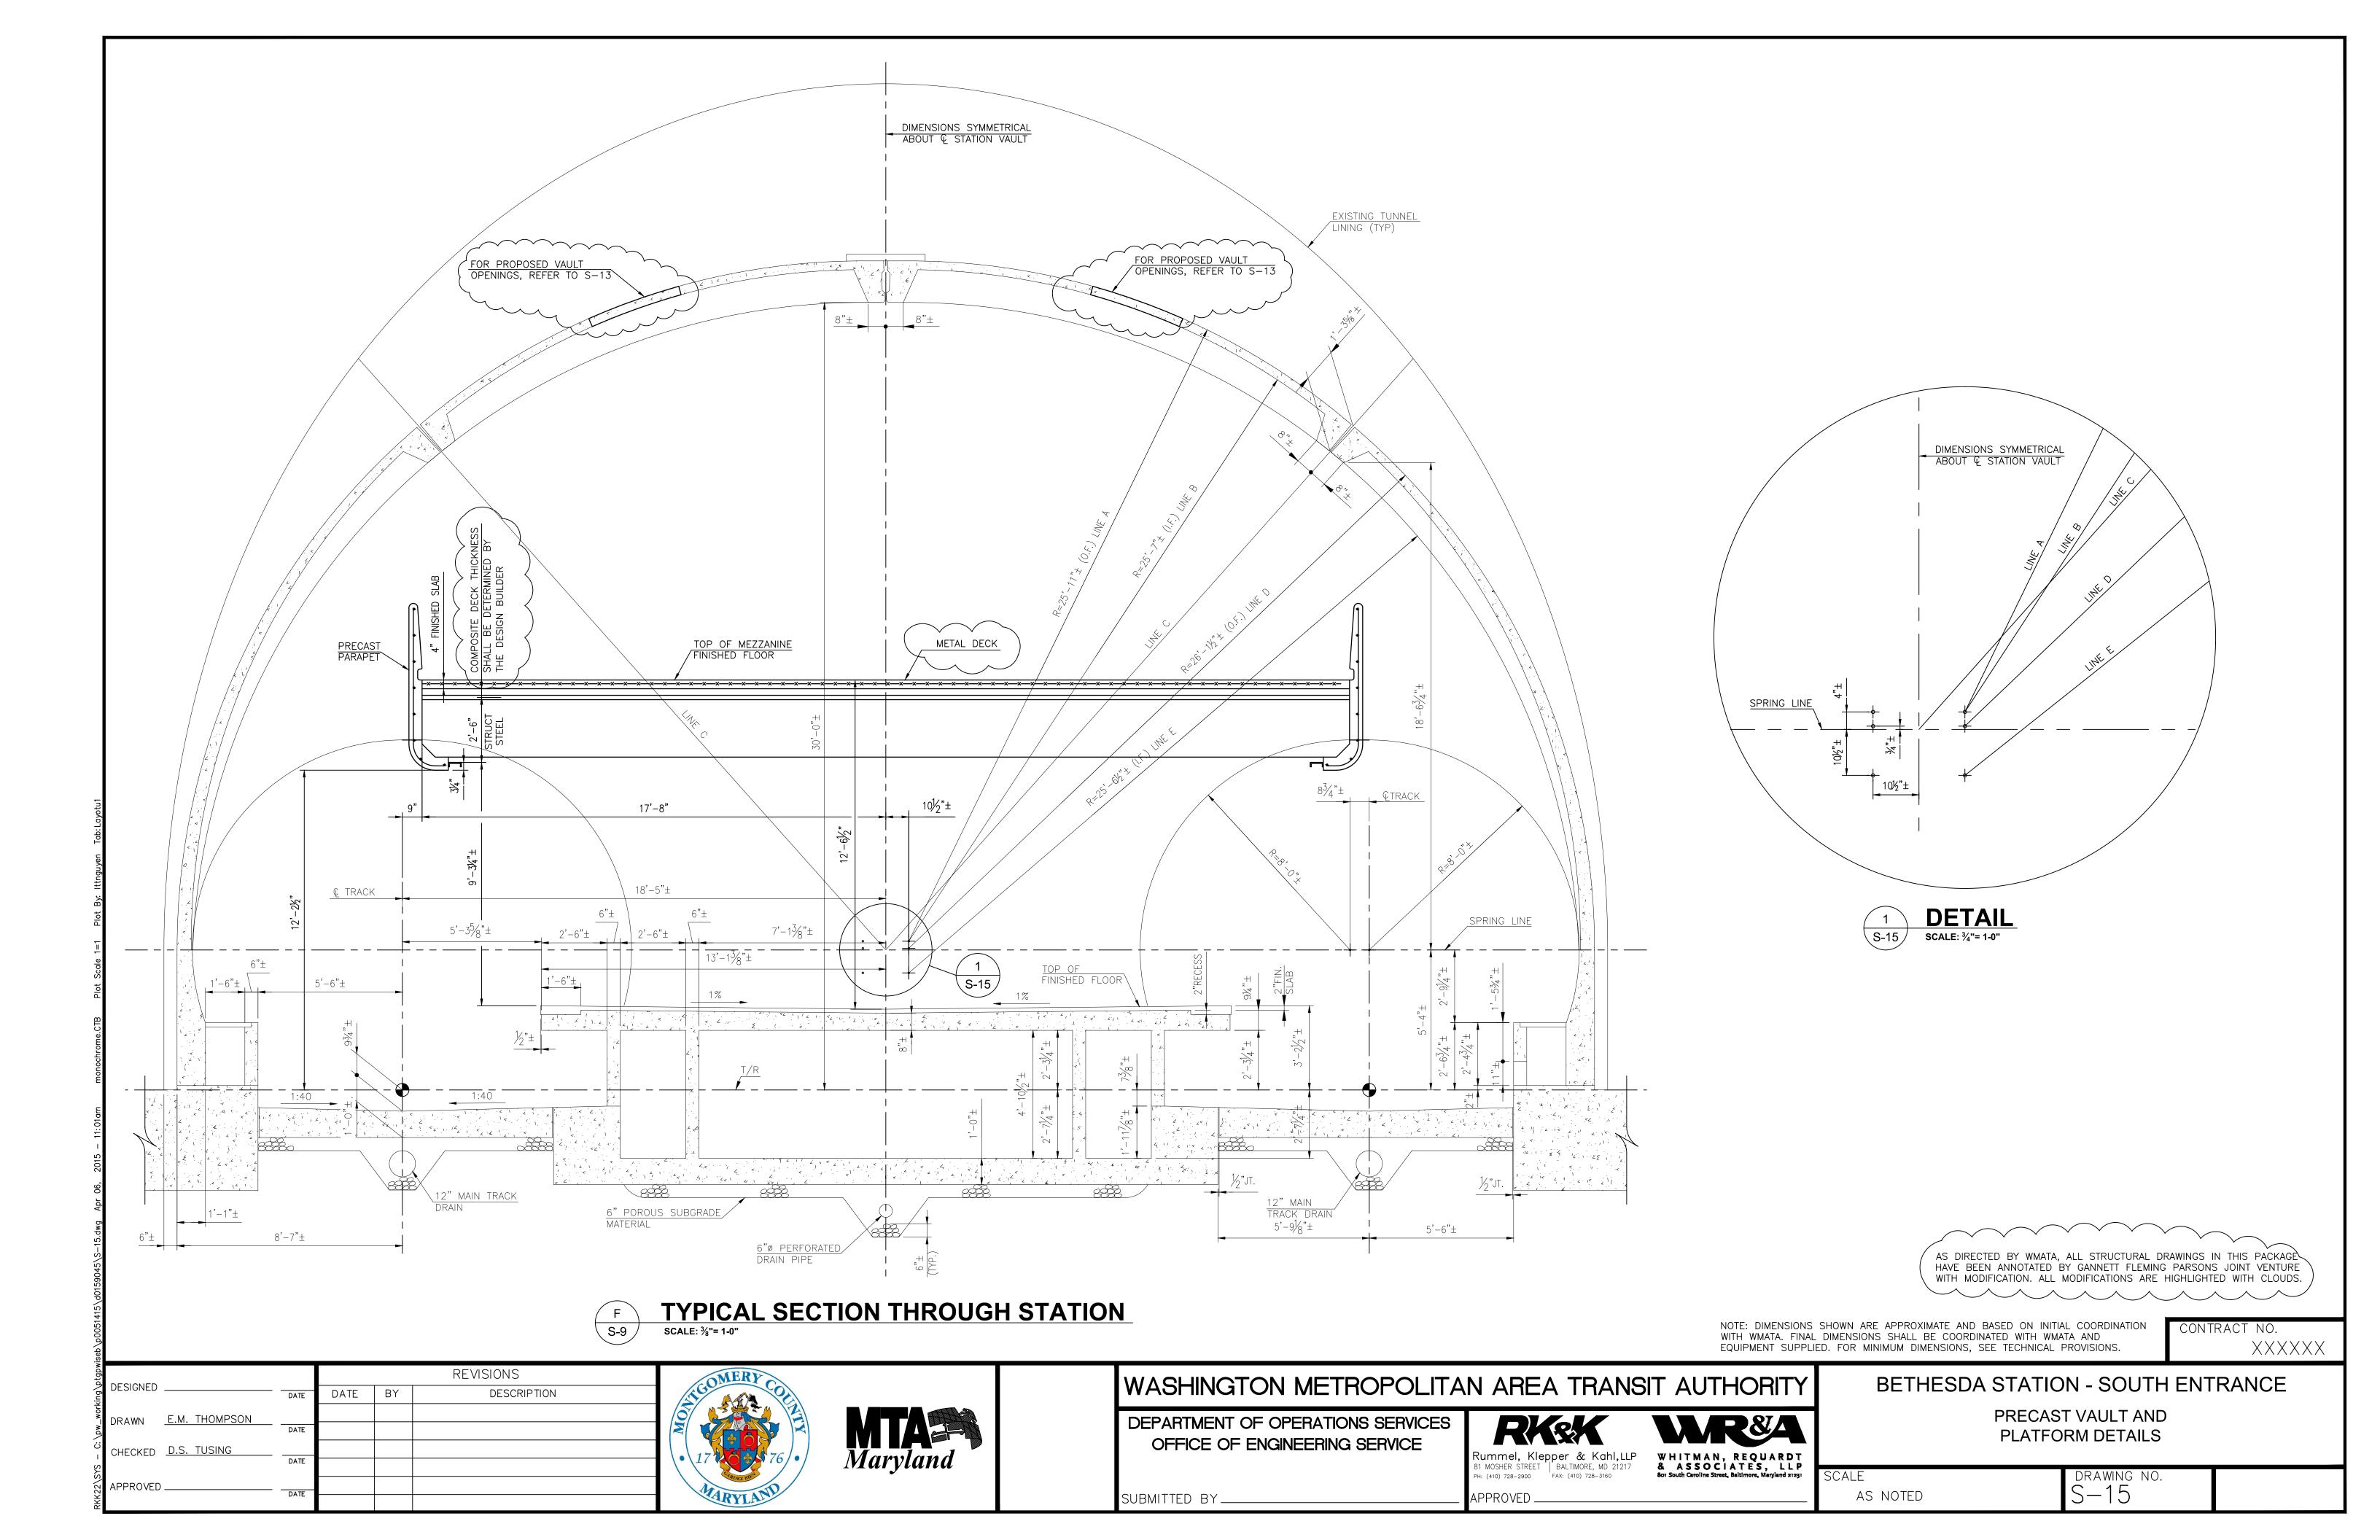

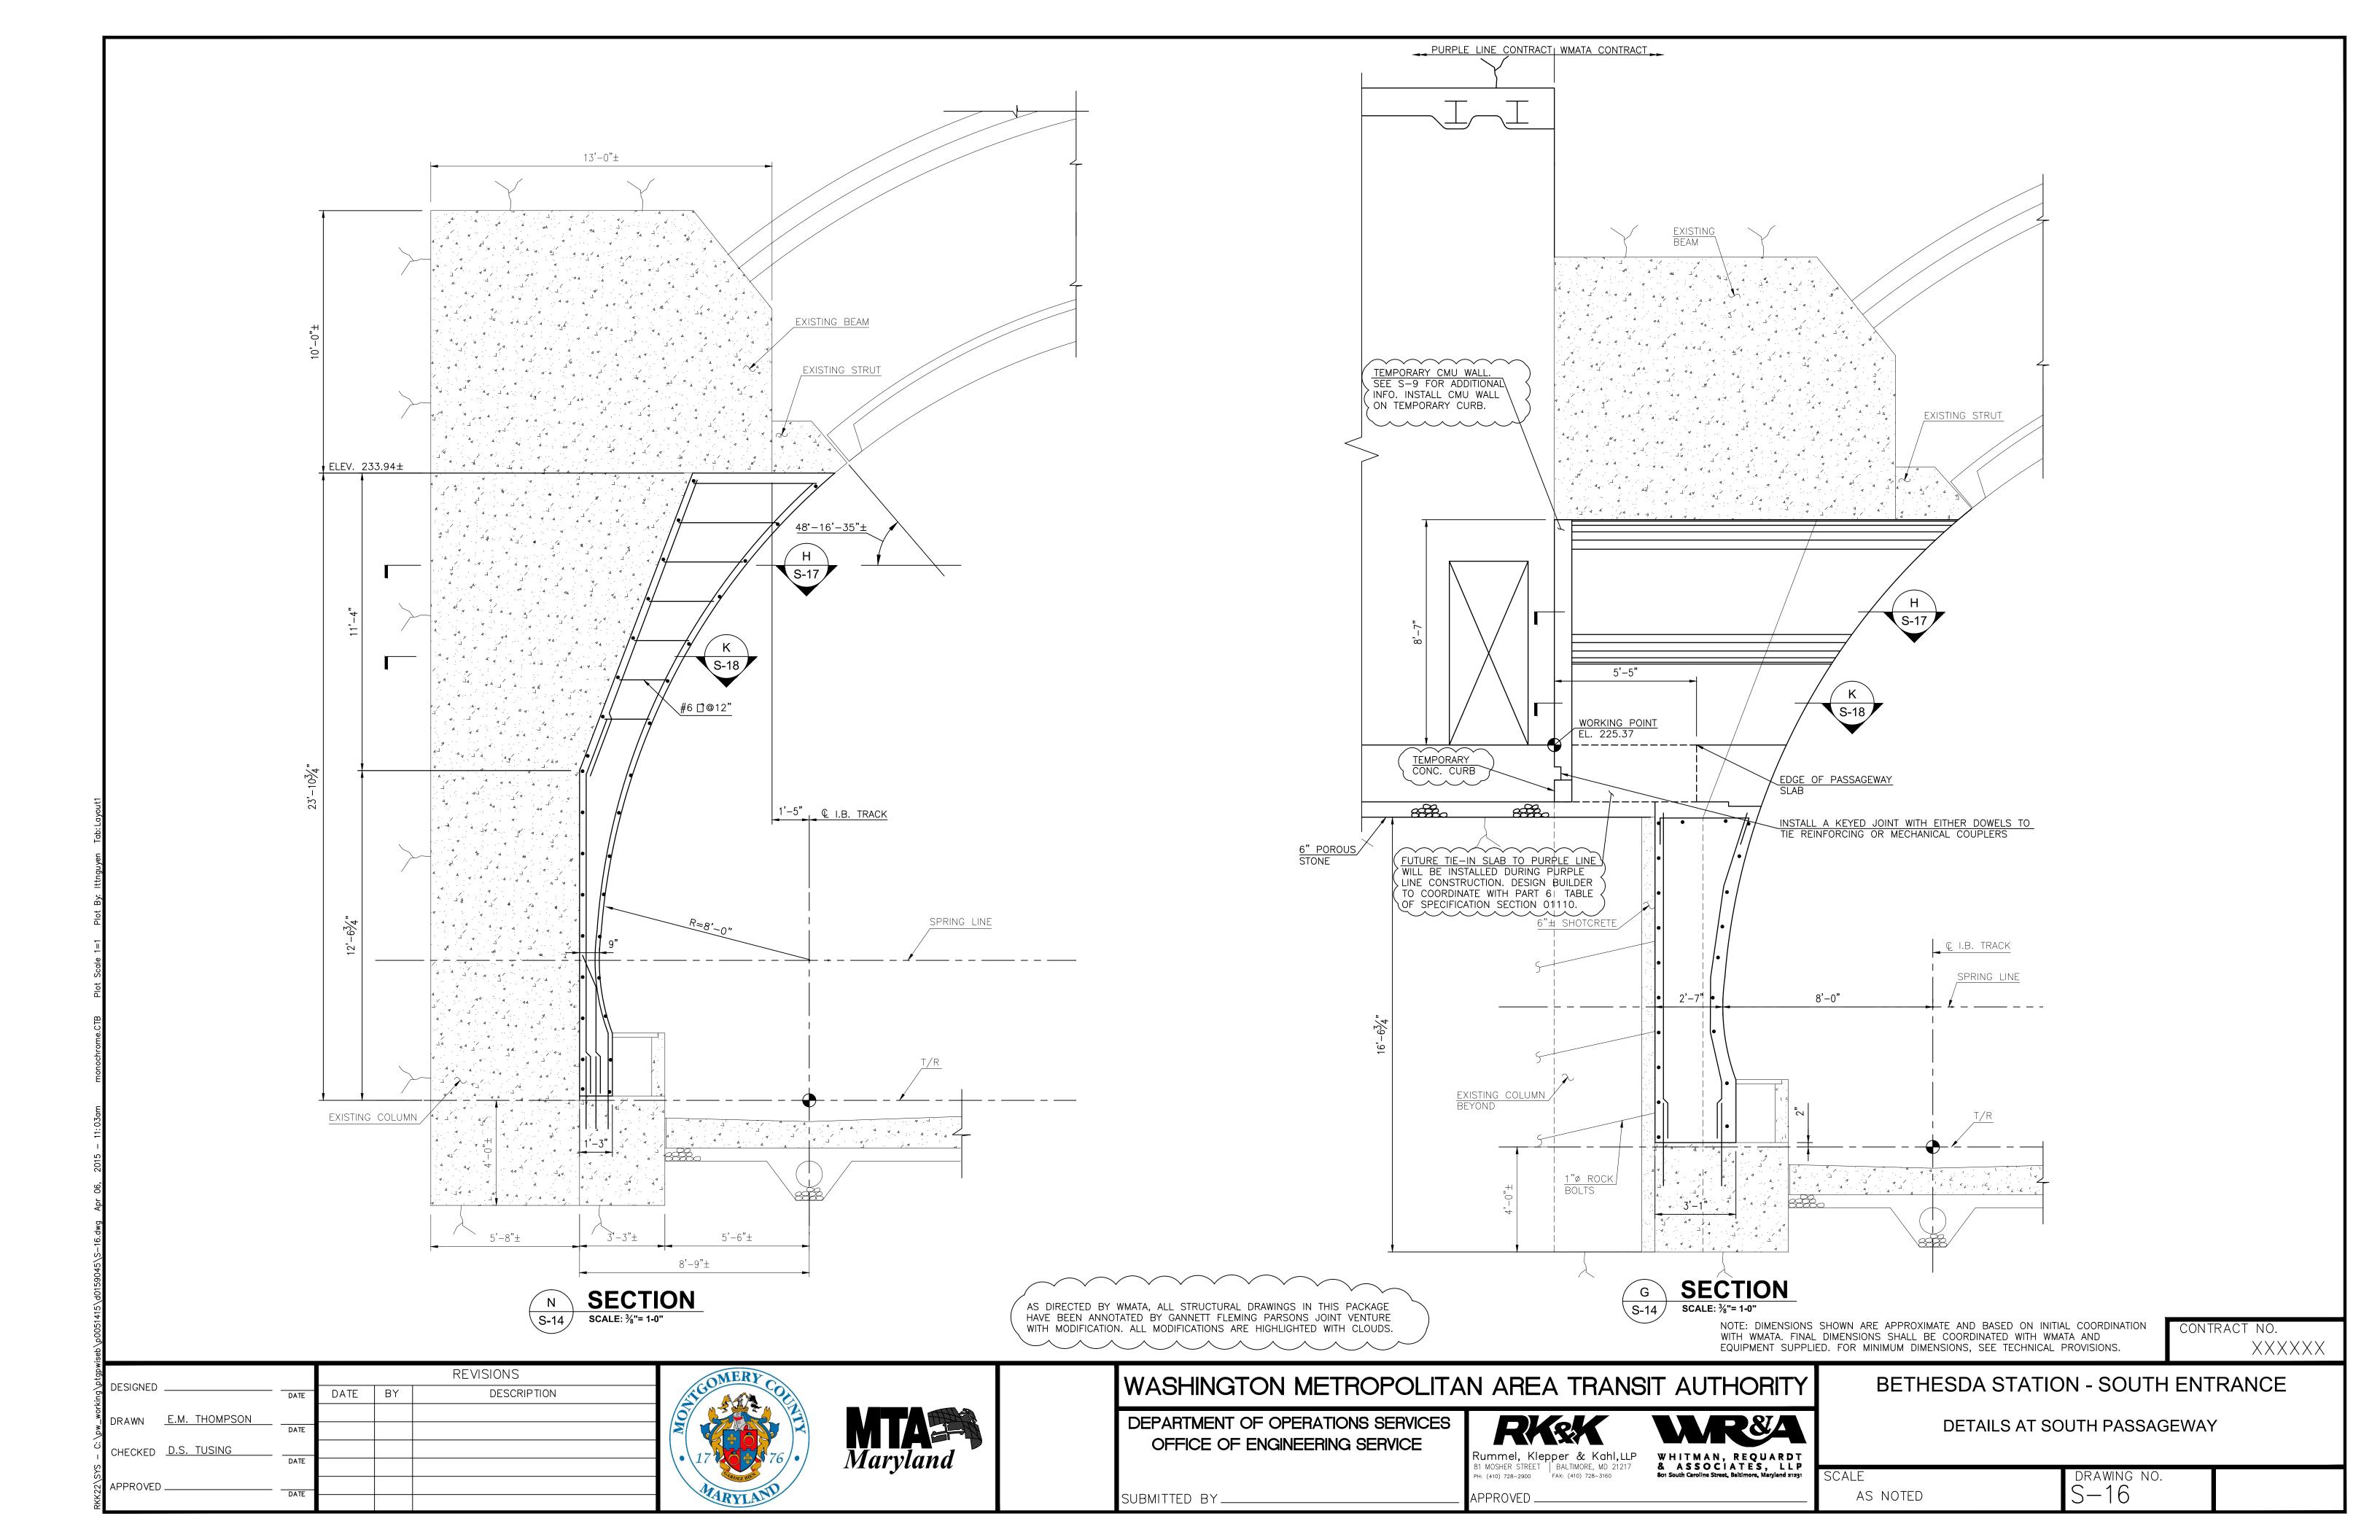

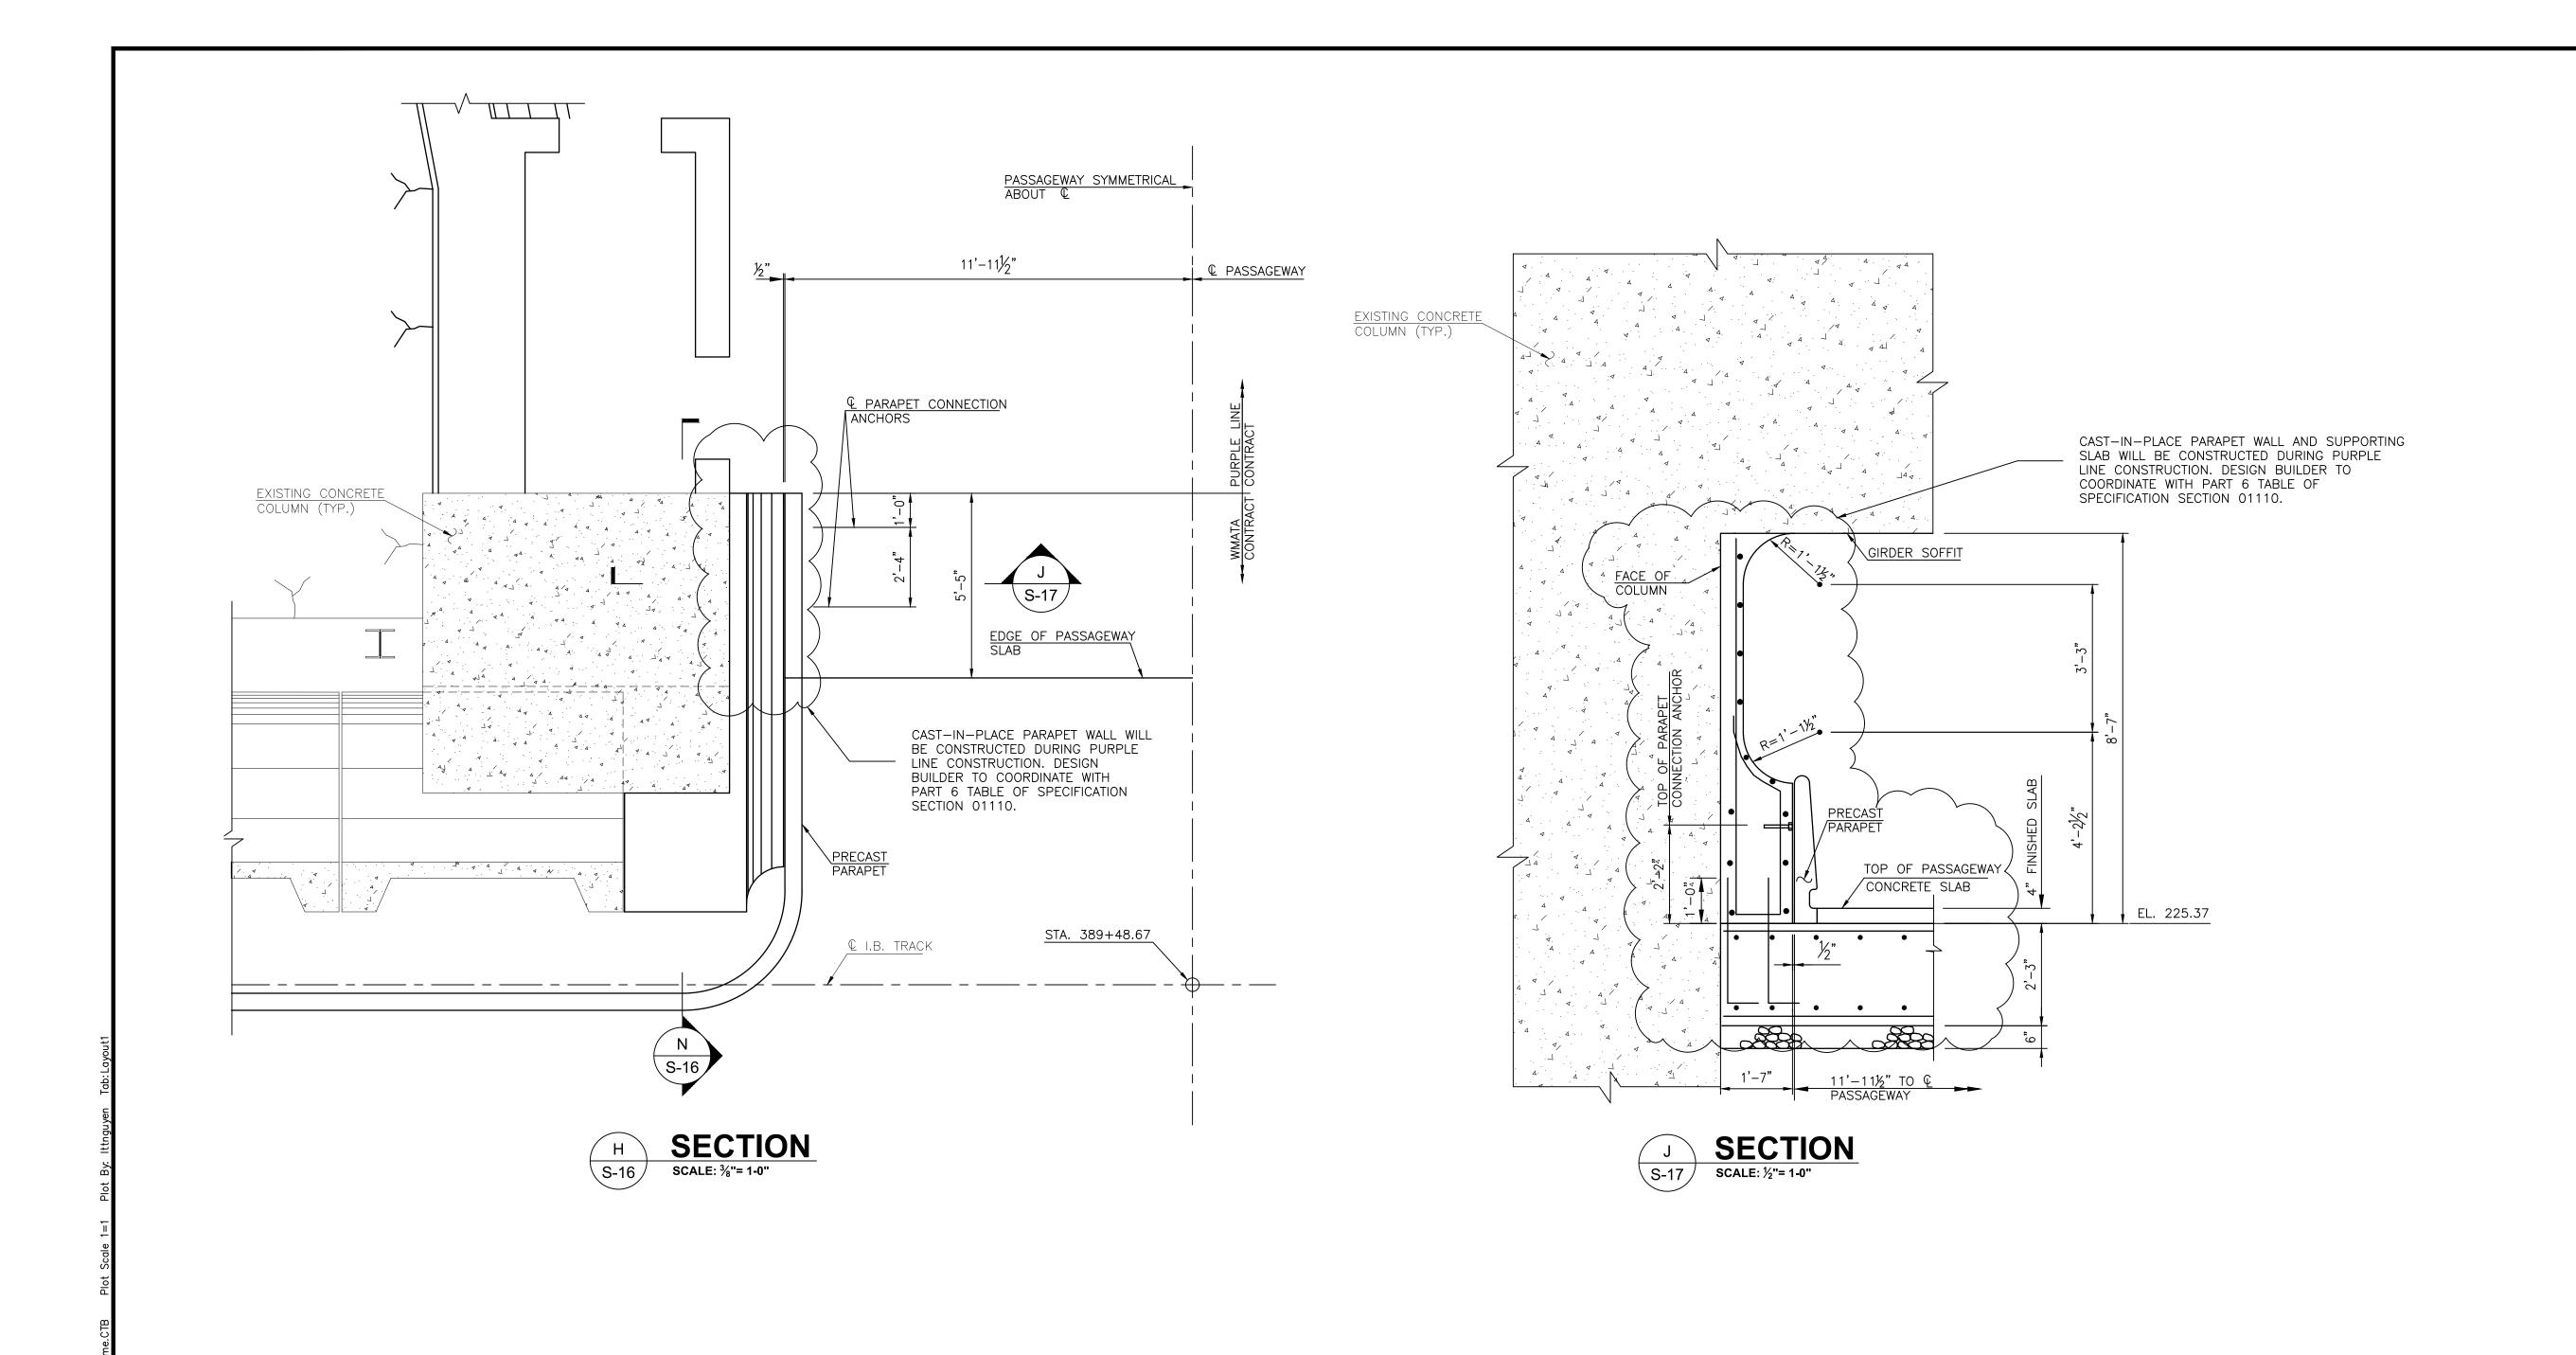

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CONTRACT NO. XXXXXX

DESIGNED DATE DATE BY DESCRIPTION

DRAWN E.M. THOMPSON DATE

CHECKED D.S. TUSING

DATE

APPROVED DATE





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DEPARTMENT OF OPERATIONS SERVICES
OFFICE OF ENGINEERING SERVICE

Rummel, Klepper & Kahl, LLP
81 MOSHER STREET | BALTIMORE, MD 21217
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BETHESDA STATION - SOUTH ENTRANCE

DETAILS AT SOUTH PASSAGEWAY

SUBMITTED BY\_\_\_

AS NOTED

DRAWING NO. S-17

